



# ANNEXE AT THE RESERVE

315 & 323 COVIL AVE.

CITY OF WILMINGTON ~ WILMINGTON TOWNSHIP  
NEW HANOVER COUNTY, NORTH CAROLINA

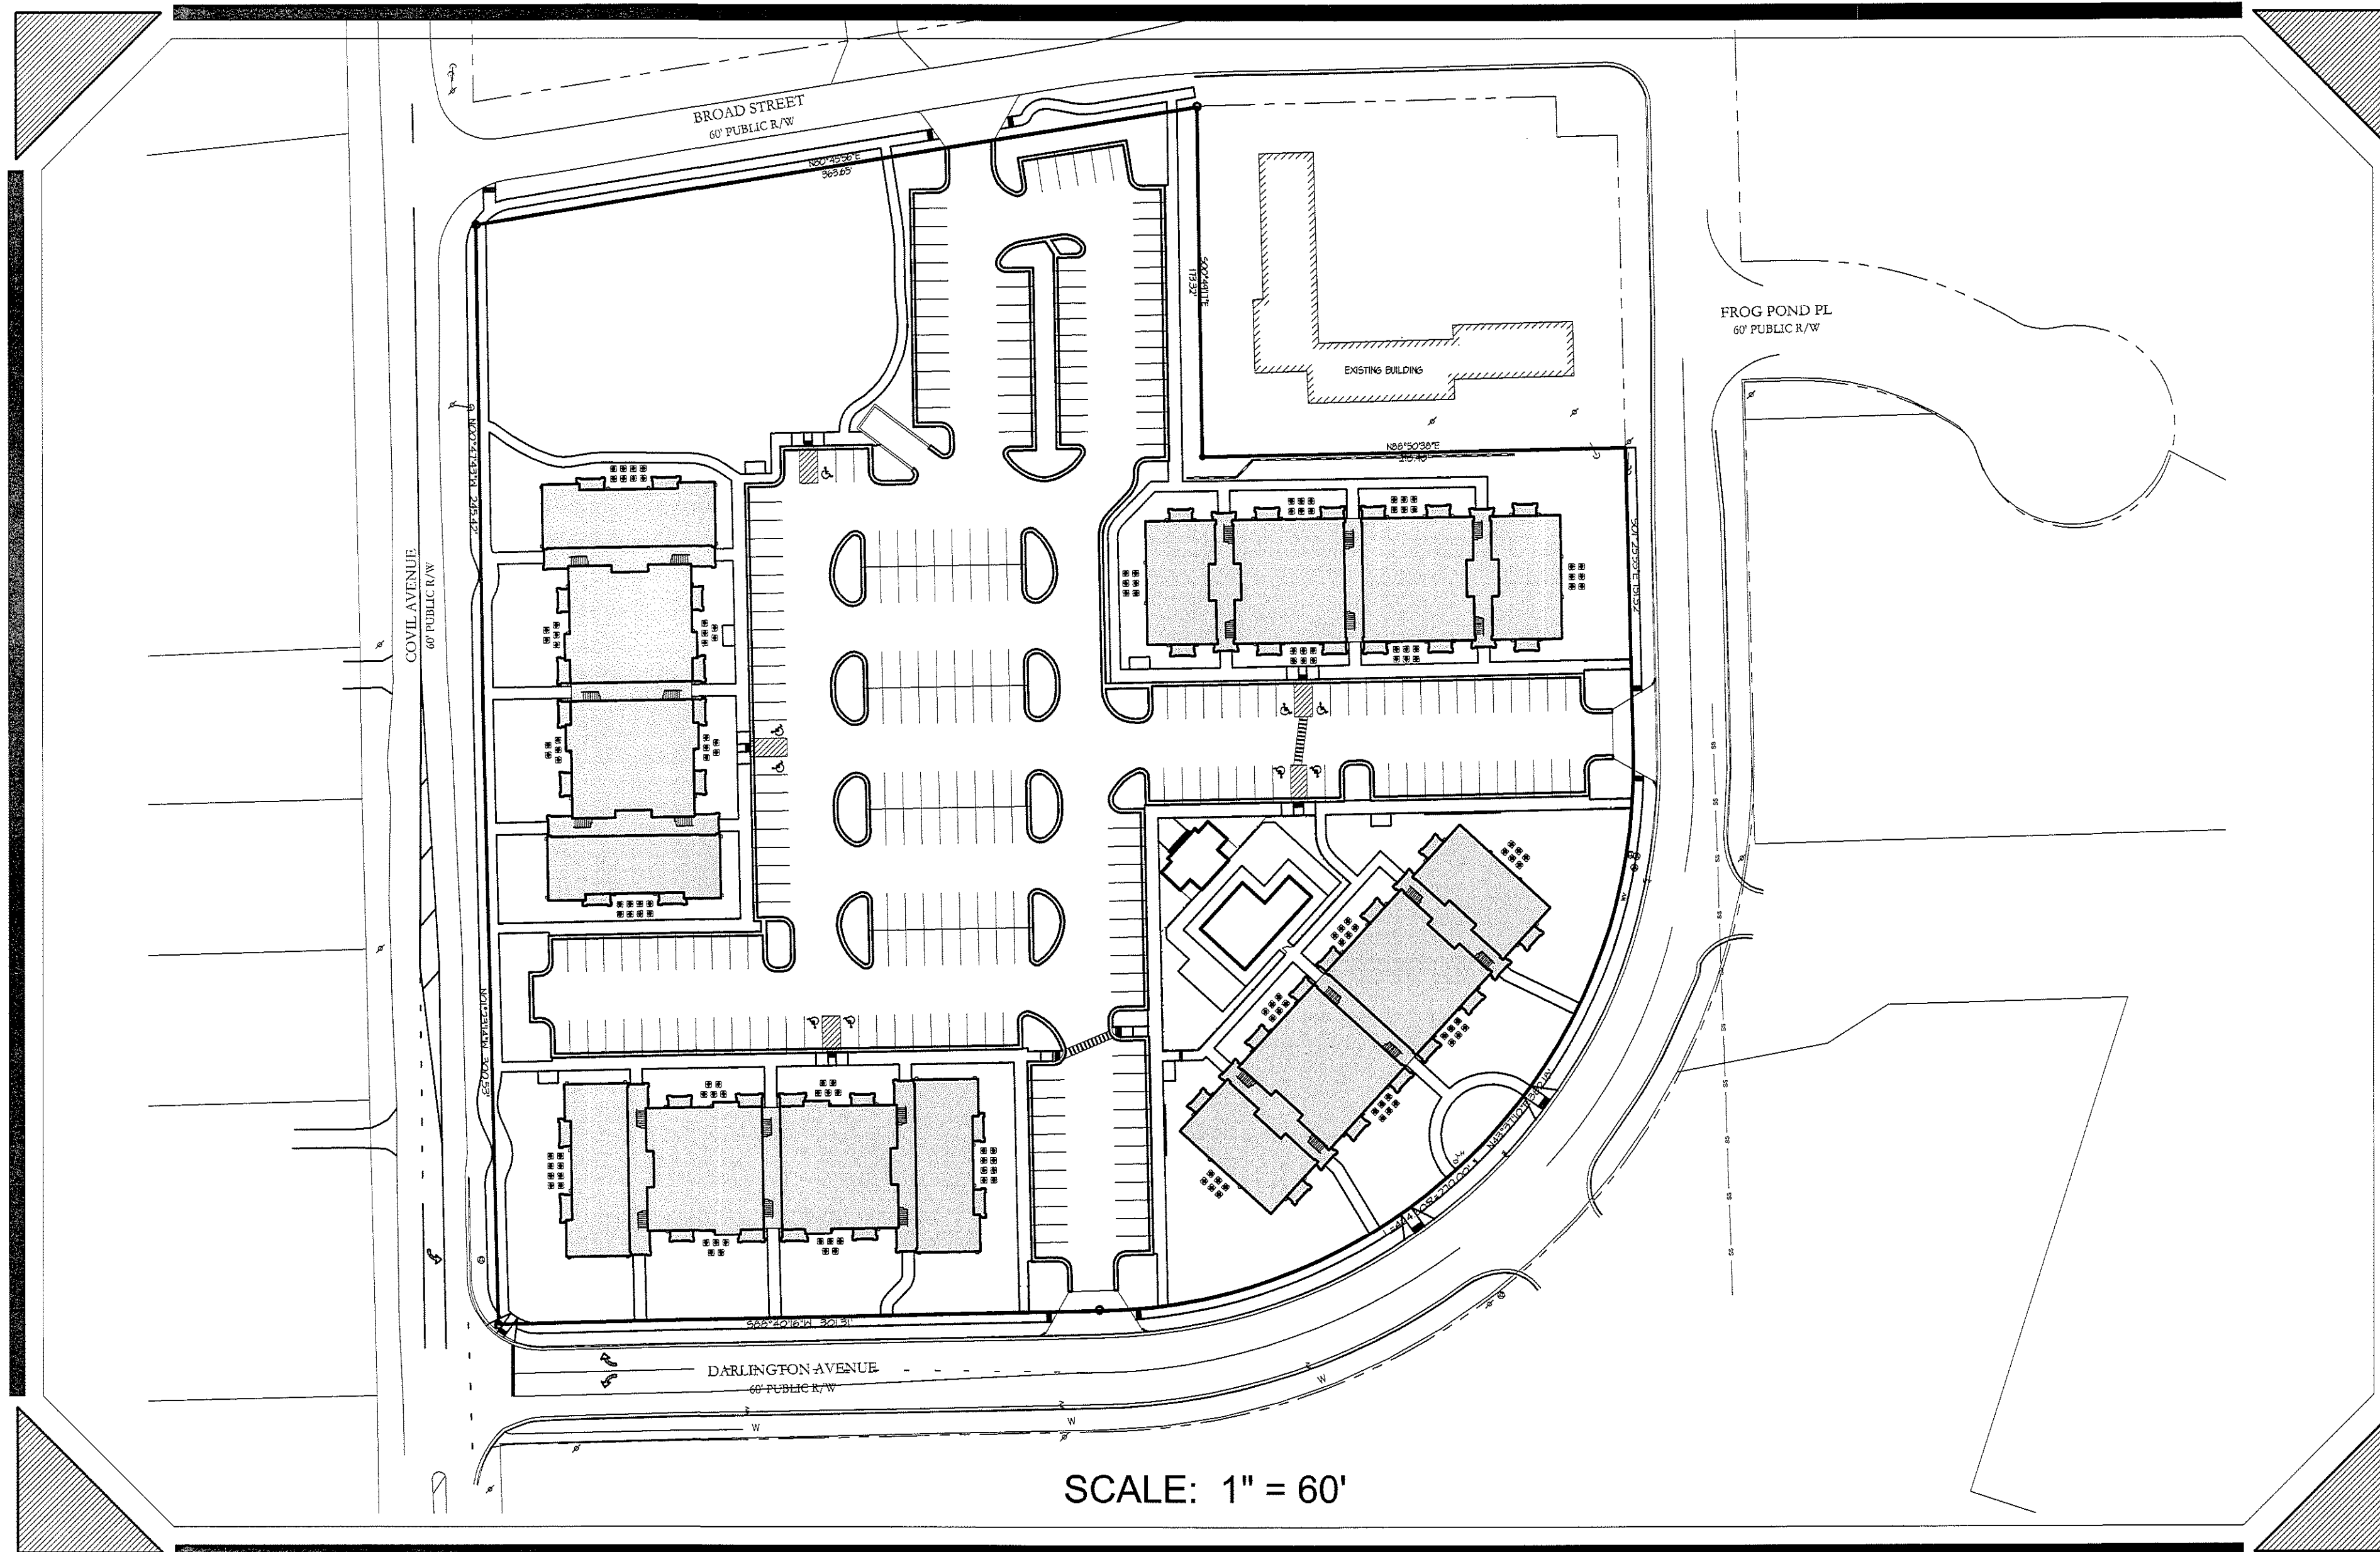


SCALE: 1" = 60'

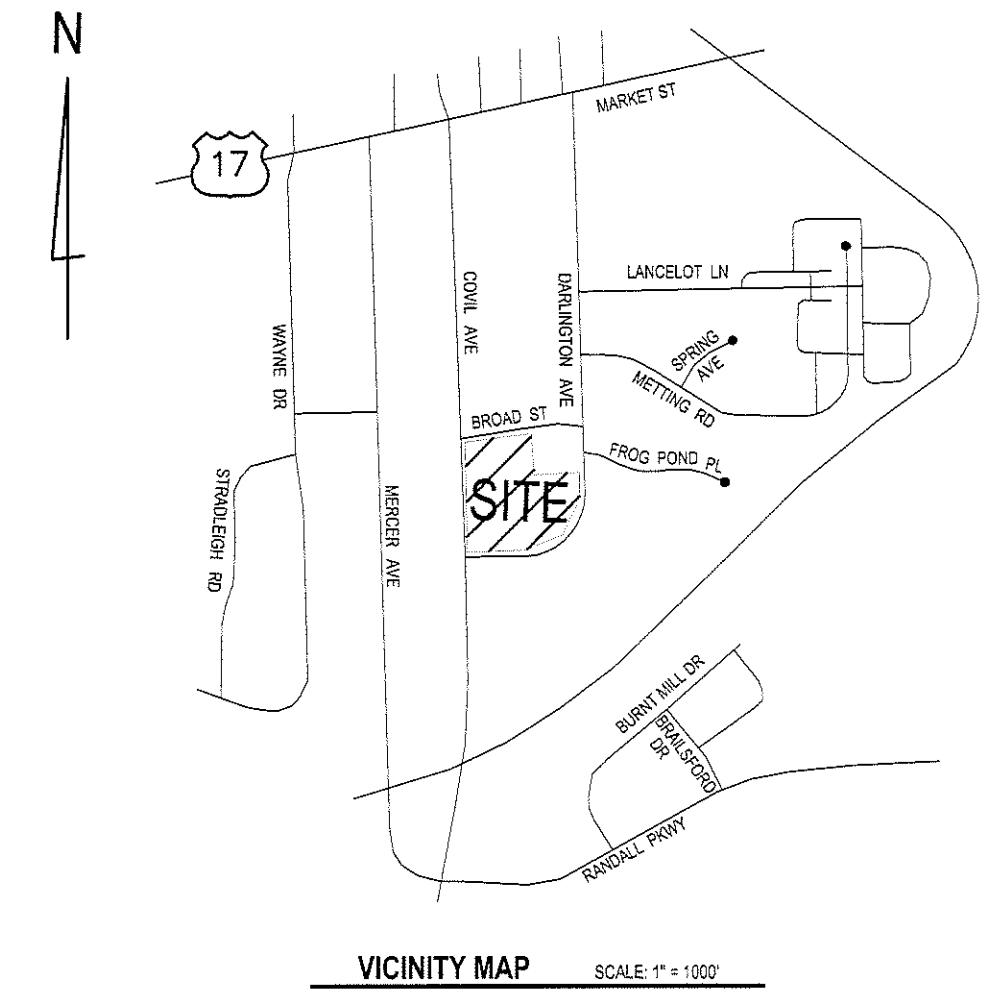

REVISIONS	
1.	REV PER CITY COMMENTS 08-16-2015

**CPT ENGINEERING AND SURVEYING, INC.**  
LAND DEVELOPMENT CONSULTING  
CORPORATE LICENSE NUMBER C-1315  
4400 TYNING STREET  
HIGH POINT, NORTH CAROLINA 27265  
PHONE: (336) 812-8800 ~ FAX: (336) 812-8780

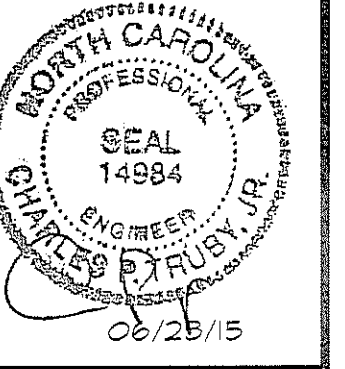

**CITY OF WILMINGTON**  
NORTH CAROLINA  
Public Services • Engineering Division  
APPROVED STORMWATER MANAGEMENT PLAN  
Date: \_\_\_\_\_ Permit # \_\_\_\_\_  
Signed: \_\_\_\_\_

**Approved Construction Plan**  
Name \_\_\_\_\_ Date \_\_\_\_\_  
Planning \_\_\_\_\_  
Traffic \_\_\_\_\_  
Fire \_\_\_\_\_

**SHEET INDEX**

NO.	TITLE
C1	Cover
C2	Existing Conditions (By Others)
C3	Demolition Plan
C4	Site Inventory Map
C5	Site Plan
C6	Utility Plan
C7	Grading & Drainage Plan
C8	Drainage Area Plan
C9	Stormwater Management Plan
C10	Tree Inventory Map
C11	Off-Site Drainage Area Map
C12	Truck Movement Plan
C13	Trash Compactor Plan & Details
D1	Site Notes & Details
D2	Site Details
D3	Utility Details
PH-01	Site Lighting Plan (By Others)
L1	Landscape Plan (By Others)
L2	Landscape Plan (By Others)
A3.1	Building Elevations (By Others)
A3.2	Building Elevations (By Others)

**OWNER / DEVELOPER:**  
BRC WILMINGTON LLC  
5826 SAMET DRIVE, SUITE 105  
HIGH POINT, NC 27265  
PHONE: (336) 889-1512  
FAX: (336) 889-1501

**ENGINEER:**  
CPT ENGINEERING & SURVEYING, INC.  
4400 TYNING STREET  
HIGH POINT, NC 27265  
CONTACT: CHUCK TRUBY, P.E.  
PHONE: (336) 812-8800 ext.304  
FAX: (336) 812-8780

Jun 23, 2015 F:\Projects\1140-12\DWG\1140-12 CIVIL BASEMAP.dwg Tab Name: Cover.dwg

REVISIONS		
NO.	DATE	DESCRIPTION


**COVER SHEET**  
**ANNEXE AT THE RESERVE**  
CITY OF WILMINGTON ~ WILMINGTON TOWNSHIP  
NEW HANOVER COUNTY, NORTH CAROLINA

315 & 323 COVIL AVE.  
**COVER SHEET**  
SCALE: NTS  
DATE: 08/17/15  
PROJECT: 1140-12  
DRAWN BY: TGL  
SHEET **C1**

REVISIONS

1. REV PER CITY COMMENTS  
08-18-2015

ENGINEERING AND SURVEYING, INC.  
LAND DEVELOPMENT CONSULTING  
CORPORATE LICENSE NUMBER C-1575  
4400 TYNNING STREET  
HIGH POINT, NORTH CAROLINA 27265  
PHONE: (336) 812-8000 ~ FAX: (336) 812-5180

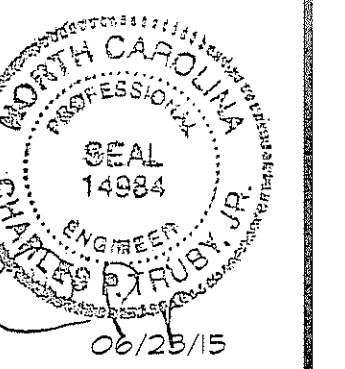

EXISTING CONDITIONS (BY OTHERS)  
**ANNEXE AT THE RESERVE**  
CITY OF WILMINGTON ~ WILMINGTON TOWNSHIP  
NEW HANOVER COUNTY, NORTH CAROLINA

315 & 323 COVIL AVE.

EXISTING  
CONDITIONS




SCALE: 1" = 40'

DATE: 03/17/15

PROJECT: 1140-12

DRAWN BY: TGL

SHEET **C2**

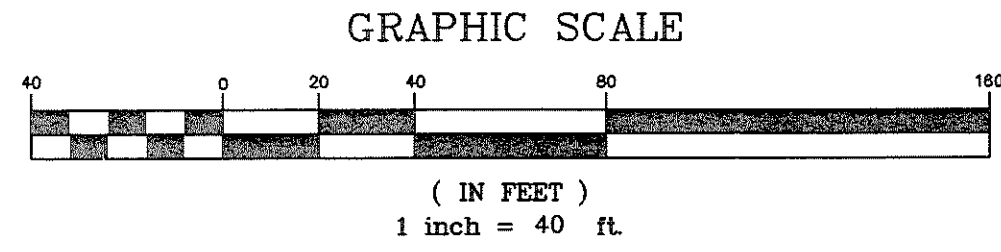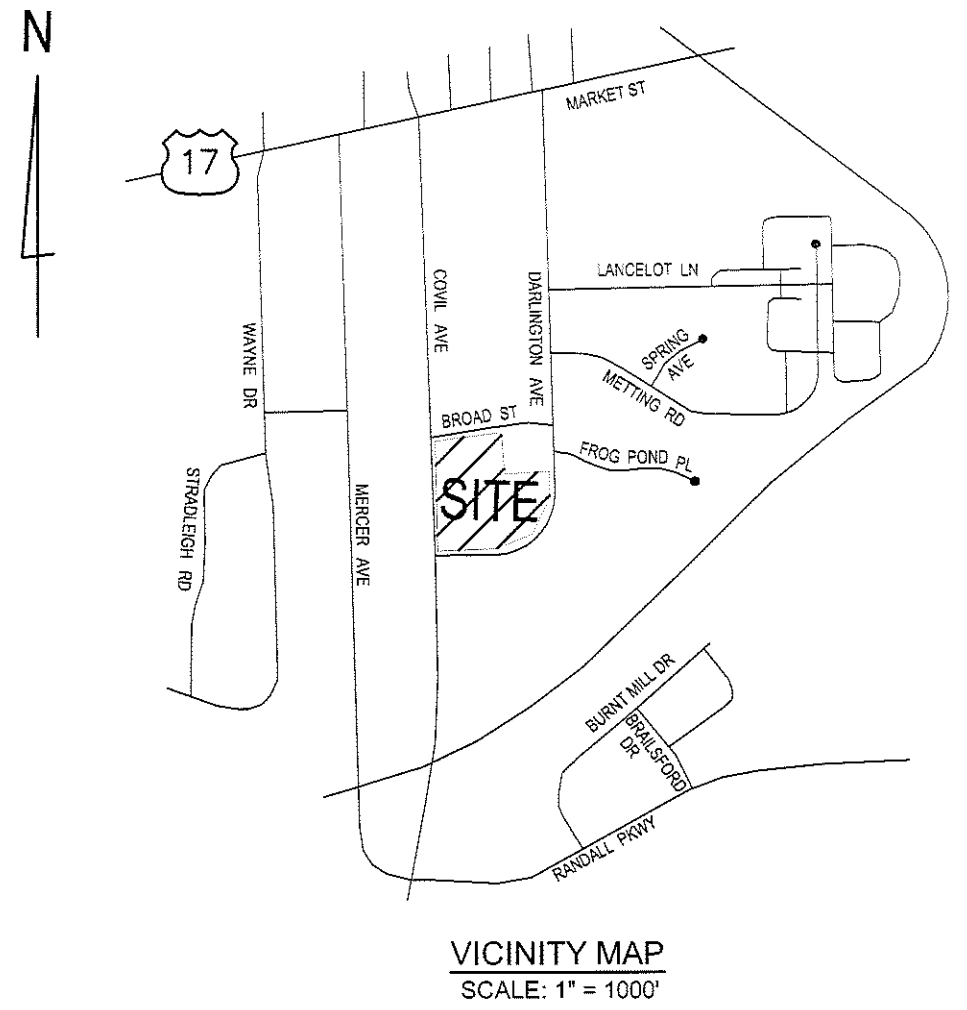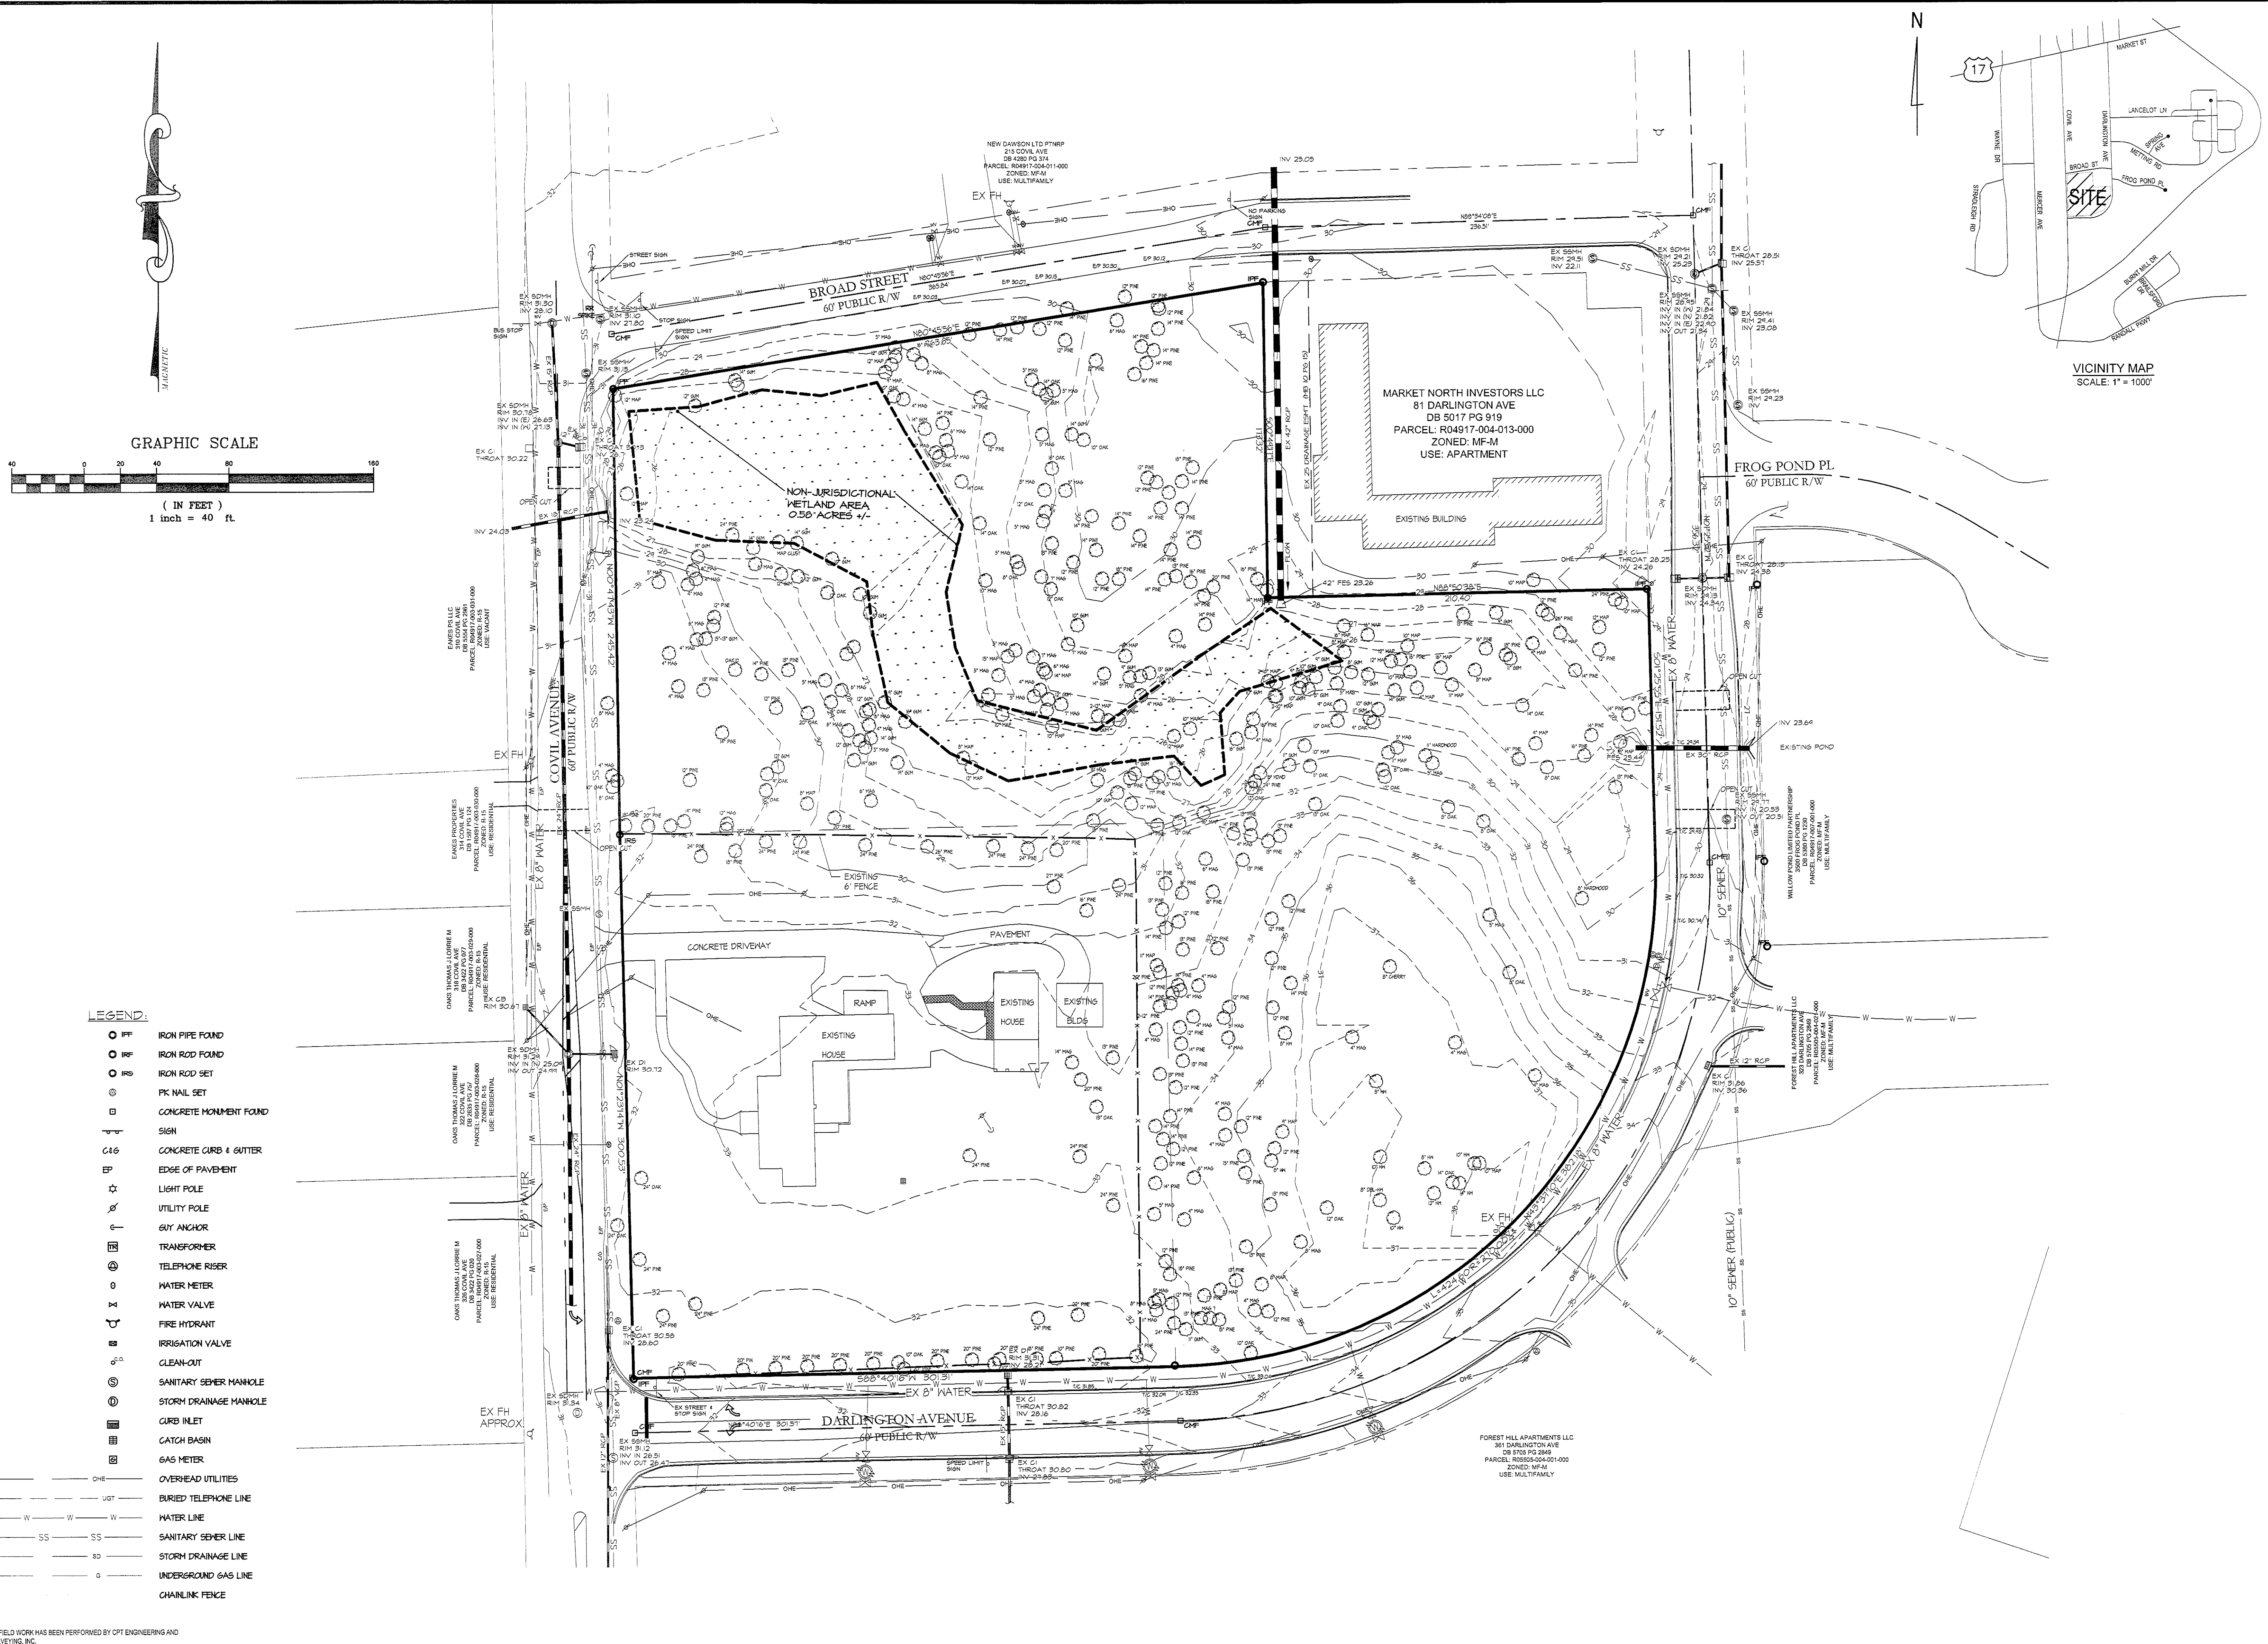

- LEGEND:**
- IPI IRON PIPE FOUND
  - IRI IRON ROD FOUND
  - IRD IRON ROD SET
  - PKN PK NAIL SET
  - CMF CONCRETE MONUMENT FOUND
  - S SIGN
  - C&G CONCRETE CURB & GUTTER
  - EP EDGE OF PAVEMENT
  - ★ LIGHT POLE
  - U UTILITY POLE
  - ⊙ GUY ANCHOR
  - ⊕ TRANSFORMER
  - ⊕ TELEPHONE RISER
  - ⊕ WATER METER
  - ⊕ WATER VALVE
  - ⊕ FIRE HYDRANT
  - ⊕ IRRIGATION VALVE
  - ⊕ CLEAN-OUT
  - ⊕ SANITARY SEWER MANHOLE
  - ⊕ STORM DRAINAGE MANHOLE
  - C&I CURB INLET
  - CB CATCH BASIN
  - G GAS METER
  - OHE OVERHEAD UTILITIES
  - UOT BURIED TELEPHONE LINE
  - W WATER LINE
  - SS SANITARY SEWER LINE
  - SD STORM DRAINAGE LINE
  - G UNDERGROUND GAS LINE
  - CLF CHAINLINK FENCE

Jun 25, 2015 F:\Projects\1140-12\DWG\1140-12 CIVIL BASEMAP.dwg TGL Name: C2-EX-CONDITIONS


NO FIELD WORK HAS BEEN PERFORMED BY OPT ENGINEERING AND SURVEYING, INC.



REVISIONS

REV	PER	CITY COMMENTS
02	6-2018	




**ENGINEERING AND SURVEYING, INC.**  
 LAND DEVELOPMENT CONSULTING  
 CORPORATE LICENSE NUMBER C-1975  
 4400 TYNING STREET  
 HIGH POINT, NORTH CAROLINA 27265  
 PHONE: (336) 812-8800 ~ FAX: (336) 812-8780

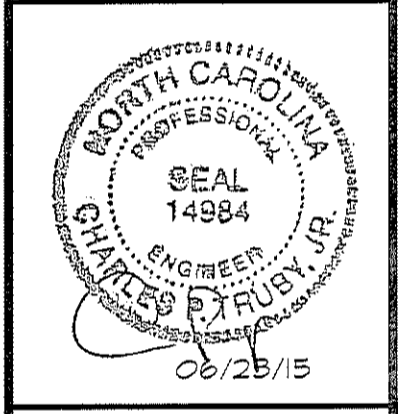

**DEMOLITION PLAN**  
**ANNEXE AT THE RESERVE**  
 CITY OF WILMINGTON ~ WILMINGTON TOWNSHIP  
 NEW HANOVER COUNTY, NORTH CAROLINA

315 & 323 COVIL AVE.

SCALE:	1" = 40'
DATE:	03/17/15
PROJECT:	1140-12
DRAWN BY:	TGL
SHEET	<b>C3</b>

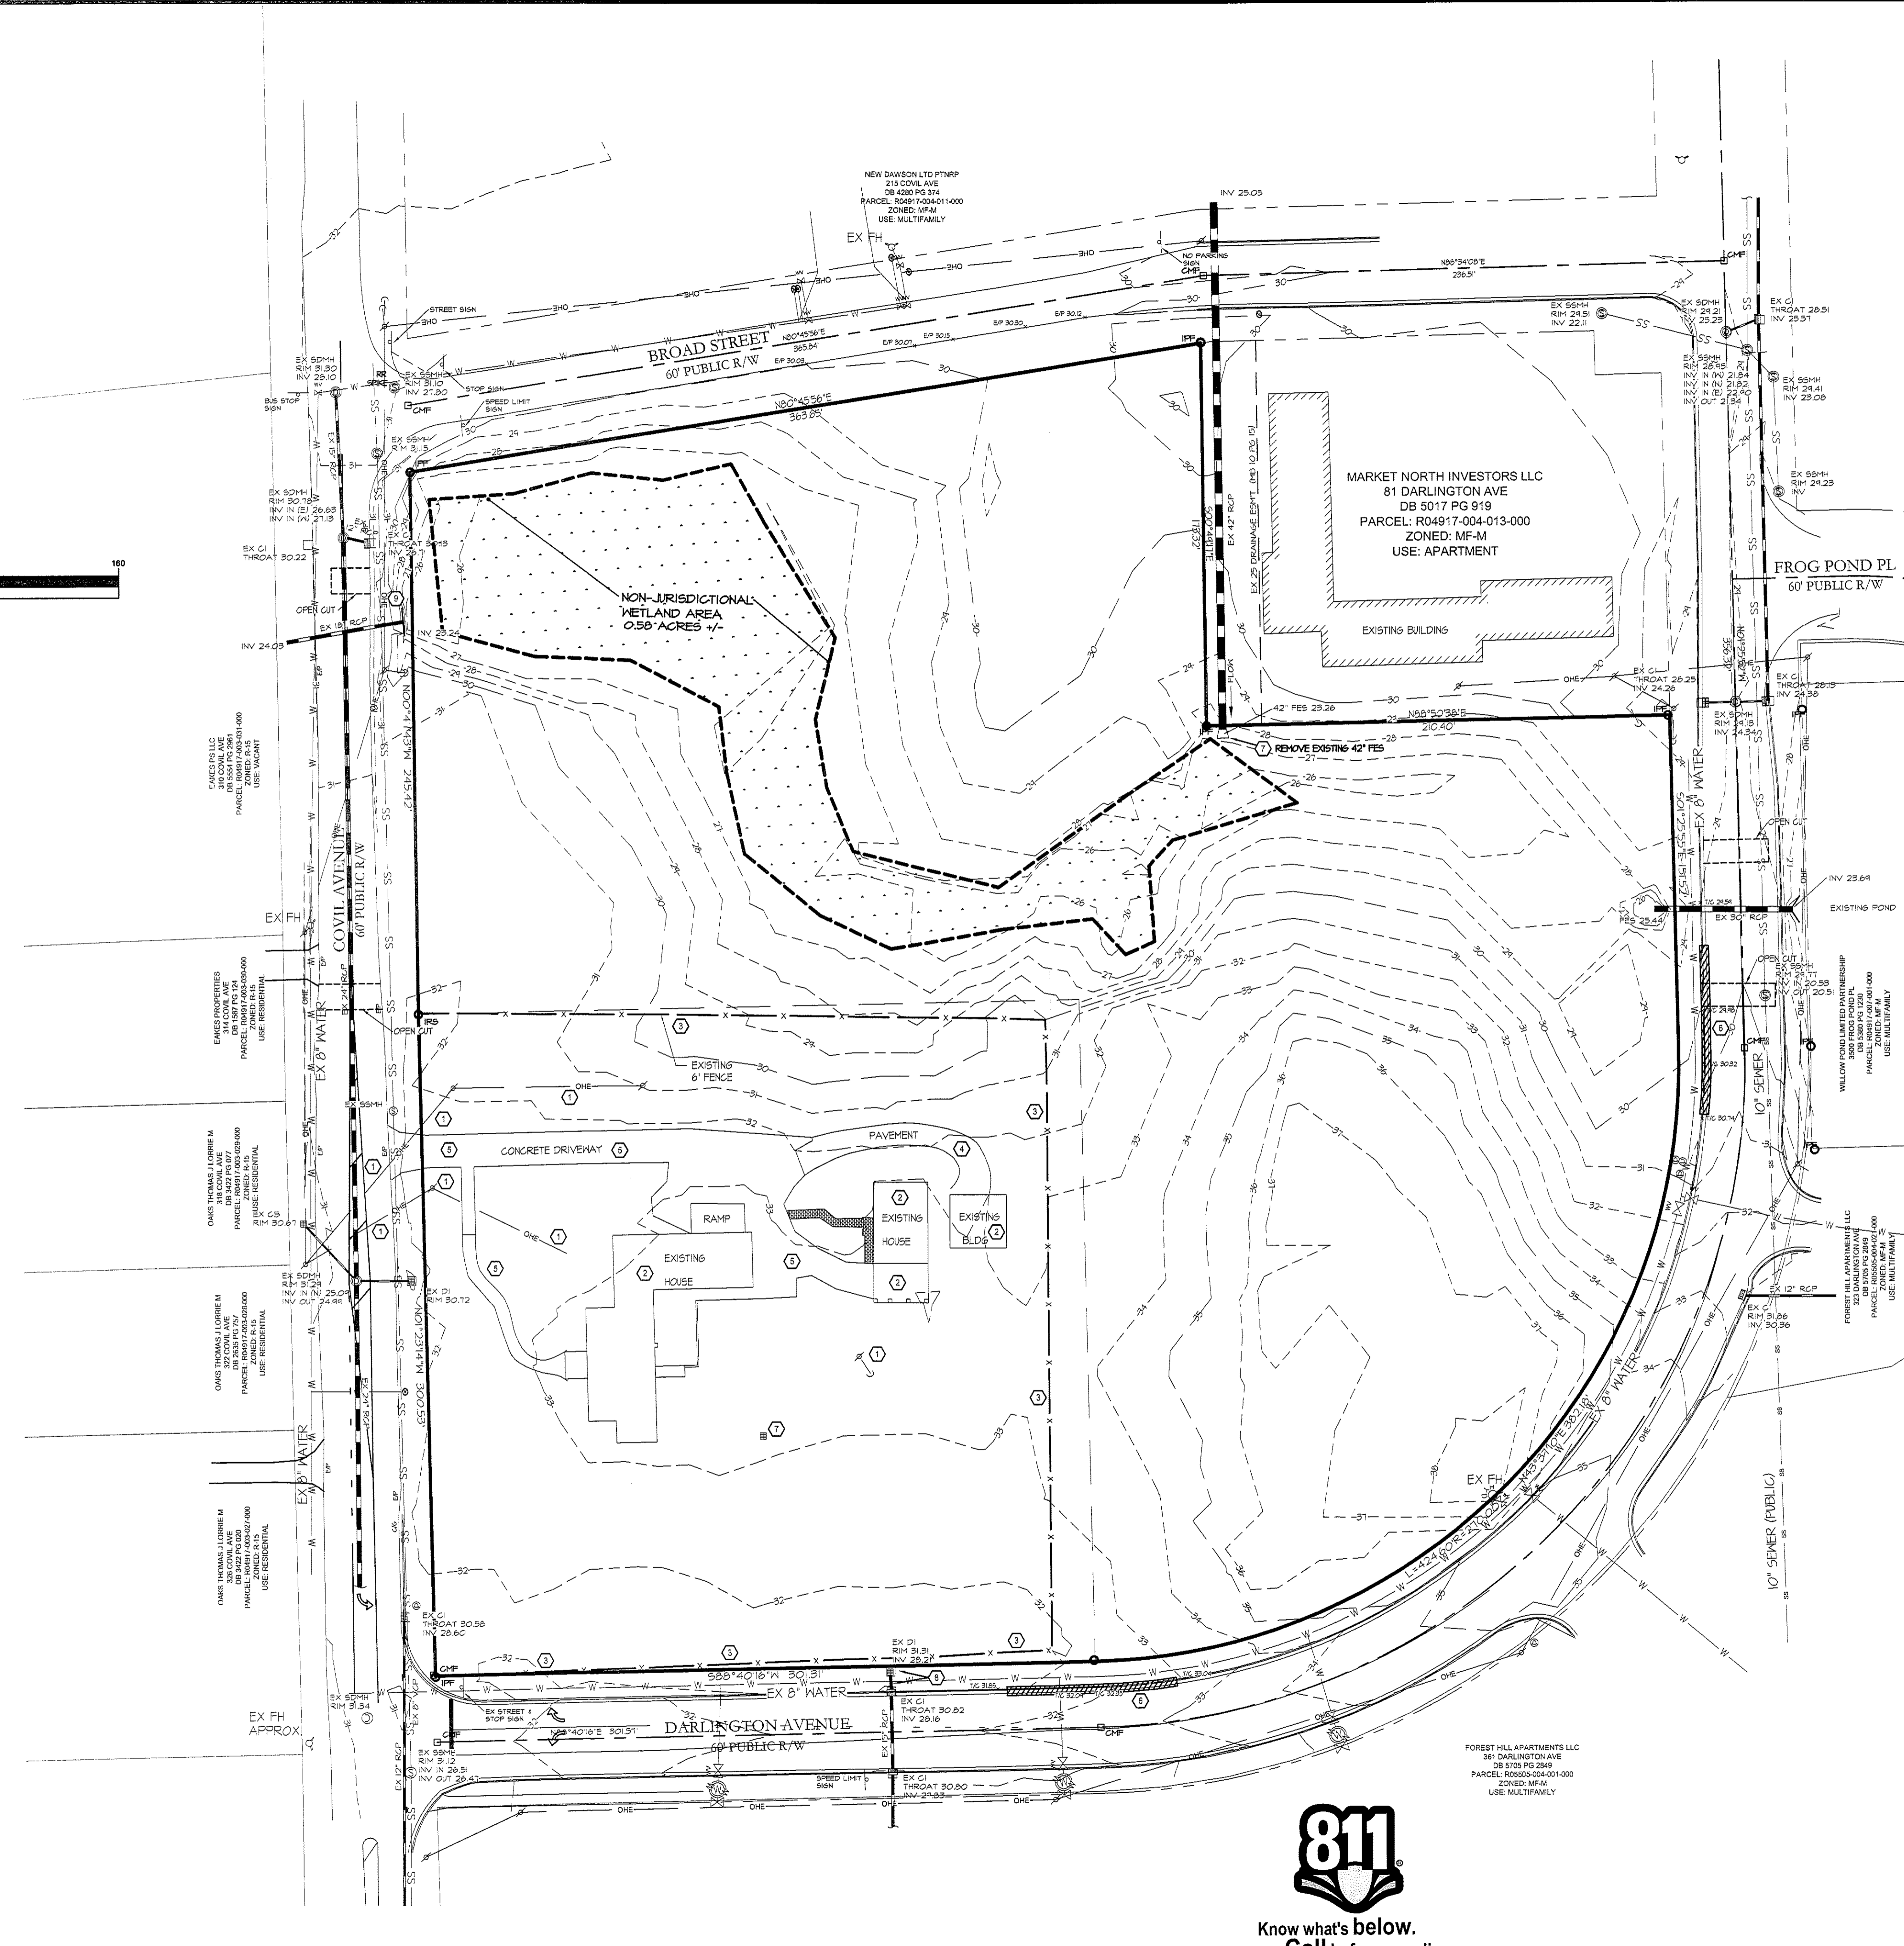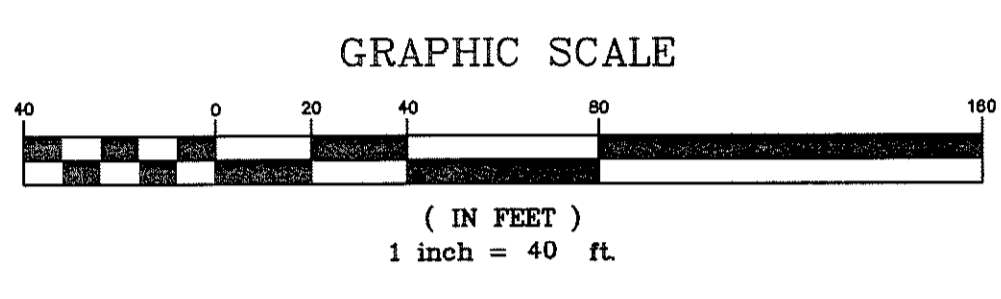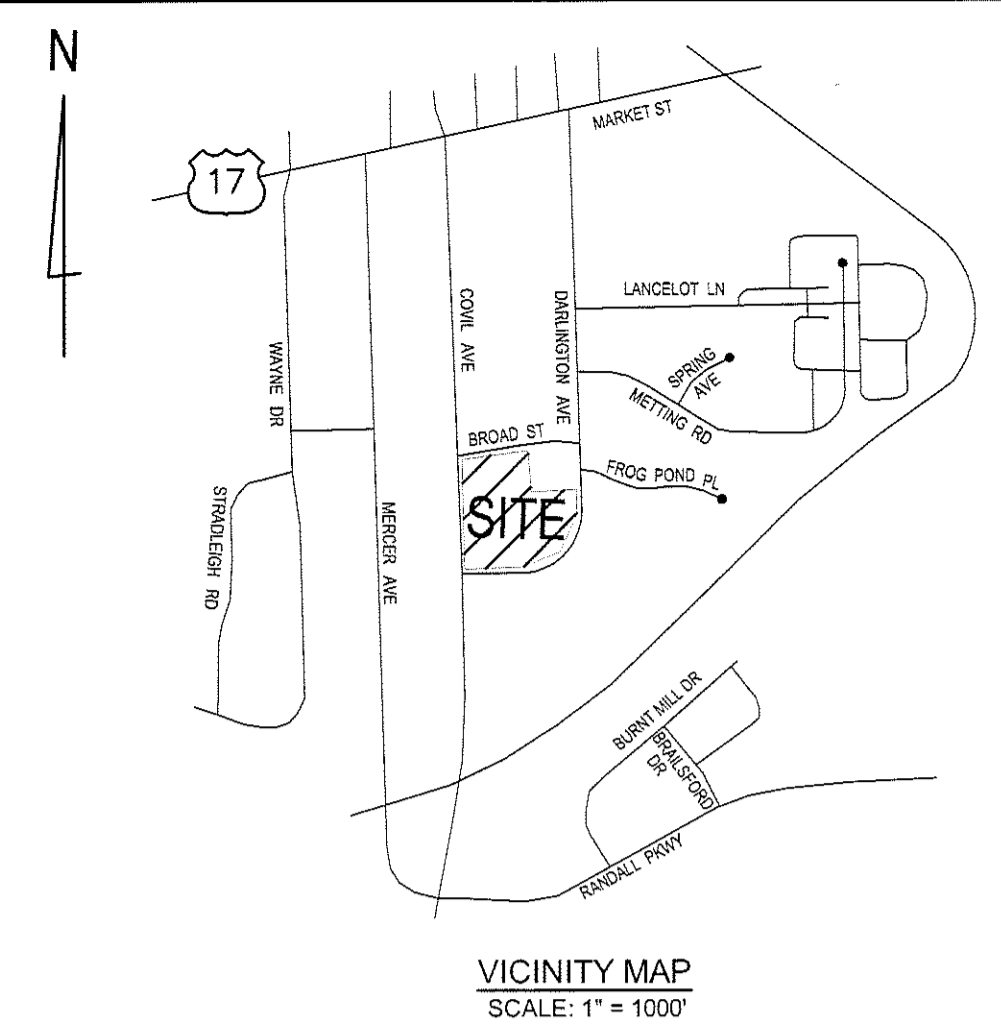

SEE SHEET C-10 FOR EXISTING TREE TO BE REMOVED

- LEGEND:**
- IFF IRON PIPE FOUND
  - IRP IRON ROD FOUND
  - IRS IRON ROD SET
  - PK NAIL SET
  - CONCRETE MONUMENT FOUND
  - ▽ SIGN
  - C46 CONCRETE CURB & GUTTER
  - EP EDGE OF PAVEMENT
  - ☆ LIGHT POLE
  - ↑ UTILITY POLE
  - ⊥ GUY ANCHOR
  - ⊠ TRANSFORMER
  - ⊙ TELEPHONE RISER
  - ⊗ WATER METER
  - ⊕ WATER VALVE
  - ⊘ FIRE HYDRANT
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  - ⊙ SANITARY SEWER MANHOLE
  - ⊙ STORM DRAINAGE MANHOLE
  - ⊙ CURB INLET
  - ⊙ CATCH BASIN
  - ⊙ GAS METER
  - OHE OVERHEAD UTILITIES
  - UGT BURIED TELEPHONE LINE
  - W W WATER LINE
  - SS SS SANITARY SEWER LINE
  - SD SD STORM DRAINAGE LINE
  - G G UNDERGROUND GAS LINE
  - CHAINLINK FENCE

- DEMOLITION KEY:**
- 1 CONTACT POWER COMPANY TO SCHEDULE TO HAVE THE EXISTING ELECTRICAL SERVICE TO THE BUILDINGS/SITE DISCONNECTED.
  - 2 DEMOLISH AND REMOVE EXISTING BUILDINGS AND FOUNDATIONS, CANOPIES, AND OTHER MISCELLANEOUS STRUCTURES.
  - 3 REMOVE EXISTING FENCE.
  - 4 REMOVE EXISTING PAVEMENT.
  - 5 REMOVE EXISTING CONCRETE.
  - 6 REMOVE EXISTING CURB AND GUTTER.
  - 7 REMOVE EXISTING INLETS AND STORM PIPES.
  - 8 REMOVE EXISTING DROP INLET AND EX STORM PIPE TO EX CURB INLET, PLUG EX CURB INLET LOCATED IN DARLINGTON AVE.
  - 9 REMOVE 8 LF OF 18" RCP AND HEADWALL.
- IF APPLICABLE  
 CONTACT GAS COMPANY TO SCHEDULE TO HAVE THE EXISTING GAS SERVICE TO THE BUILDINGS/SITE DISCONNECTED. CONTRACTOR TO REMOVE EXISTING GAS LINES ON-SITE.
- REMOVE EXISTING WATER SERVICE AND METER PER CITY STANDARDS.  
 CONTRACTOR TO REMOVE EXISTING WATER LINES ON-SITE.
- REMOVE EXISTING SANITARY SEWER SERVICE AND METER PER CITY STANDARDS.  
 CONTRACTOR TO REMOVE EXISTING SEWER LINES ON-SITE.
- REMOVE EXISTING CATV AND TELEPHONE.

**OWNER / DEVELOPER:**  
 BRC WILMINGTON LLC  
 5826 SAMET DRIVE, SUITE 105  
 HIGH POINT, NC 27265  
 PHONE: (336) 888-1512  
 FAX: (336) 888-1501



**ENGINEER:**  
 CRT ENGINEERING & SURVEYING, INC.  
 4400 TYNING STREET  
 HIGH POINT, NC 27265  
 CONTACT: CHUCK TRUBY, P.E.  
 PHONE: (336) 812-8800 ext.304  
 FAX: (336) 812-8780



JUN 28 2015 5:05 PM P:\1140-12\1140-12\_CIVIL\_BASEMAP.dwg Title Name: C3-DEM0

NO FIELD WORK HAS BEEN PERFORMED BY OPT ENGINEERING AND SURVEYING, INC.

Apr. 23, 2015 F:\Projects\1140-12\DWG\1140-12 CIVIL BASEMAP.dwg, Tab Name: C4-SITE INVENTORY MAP

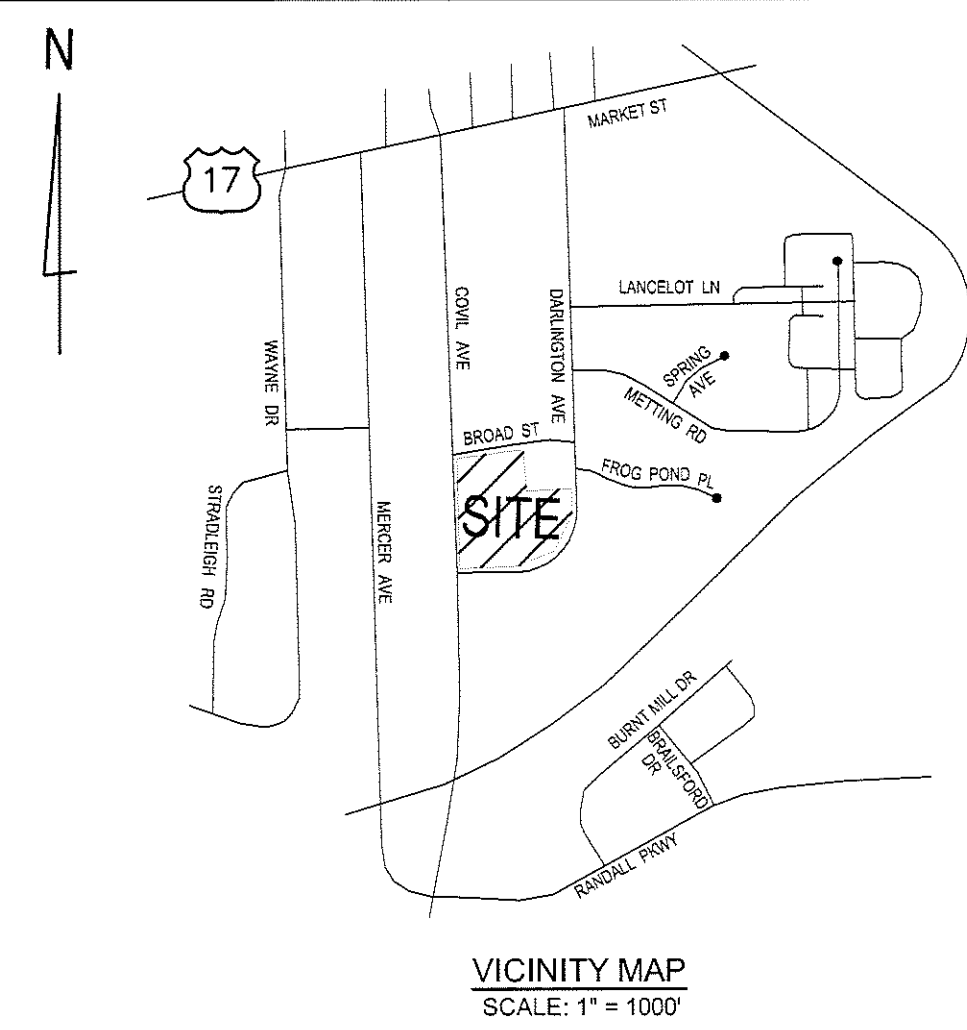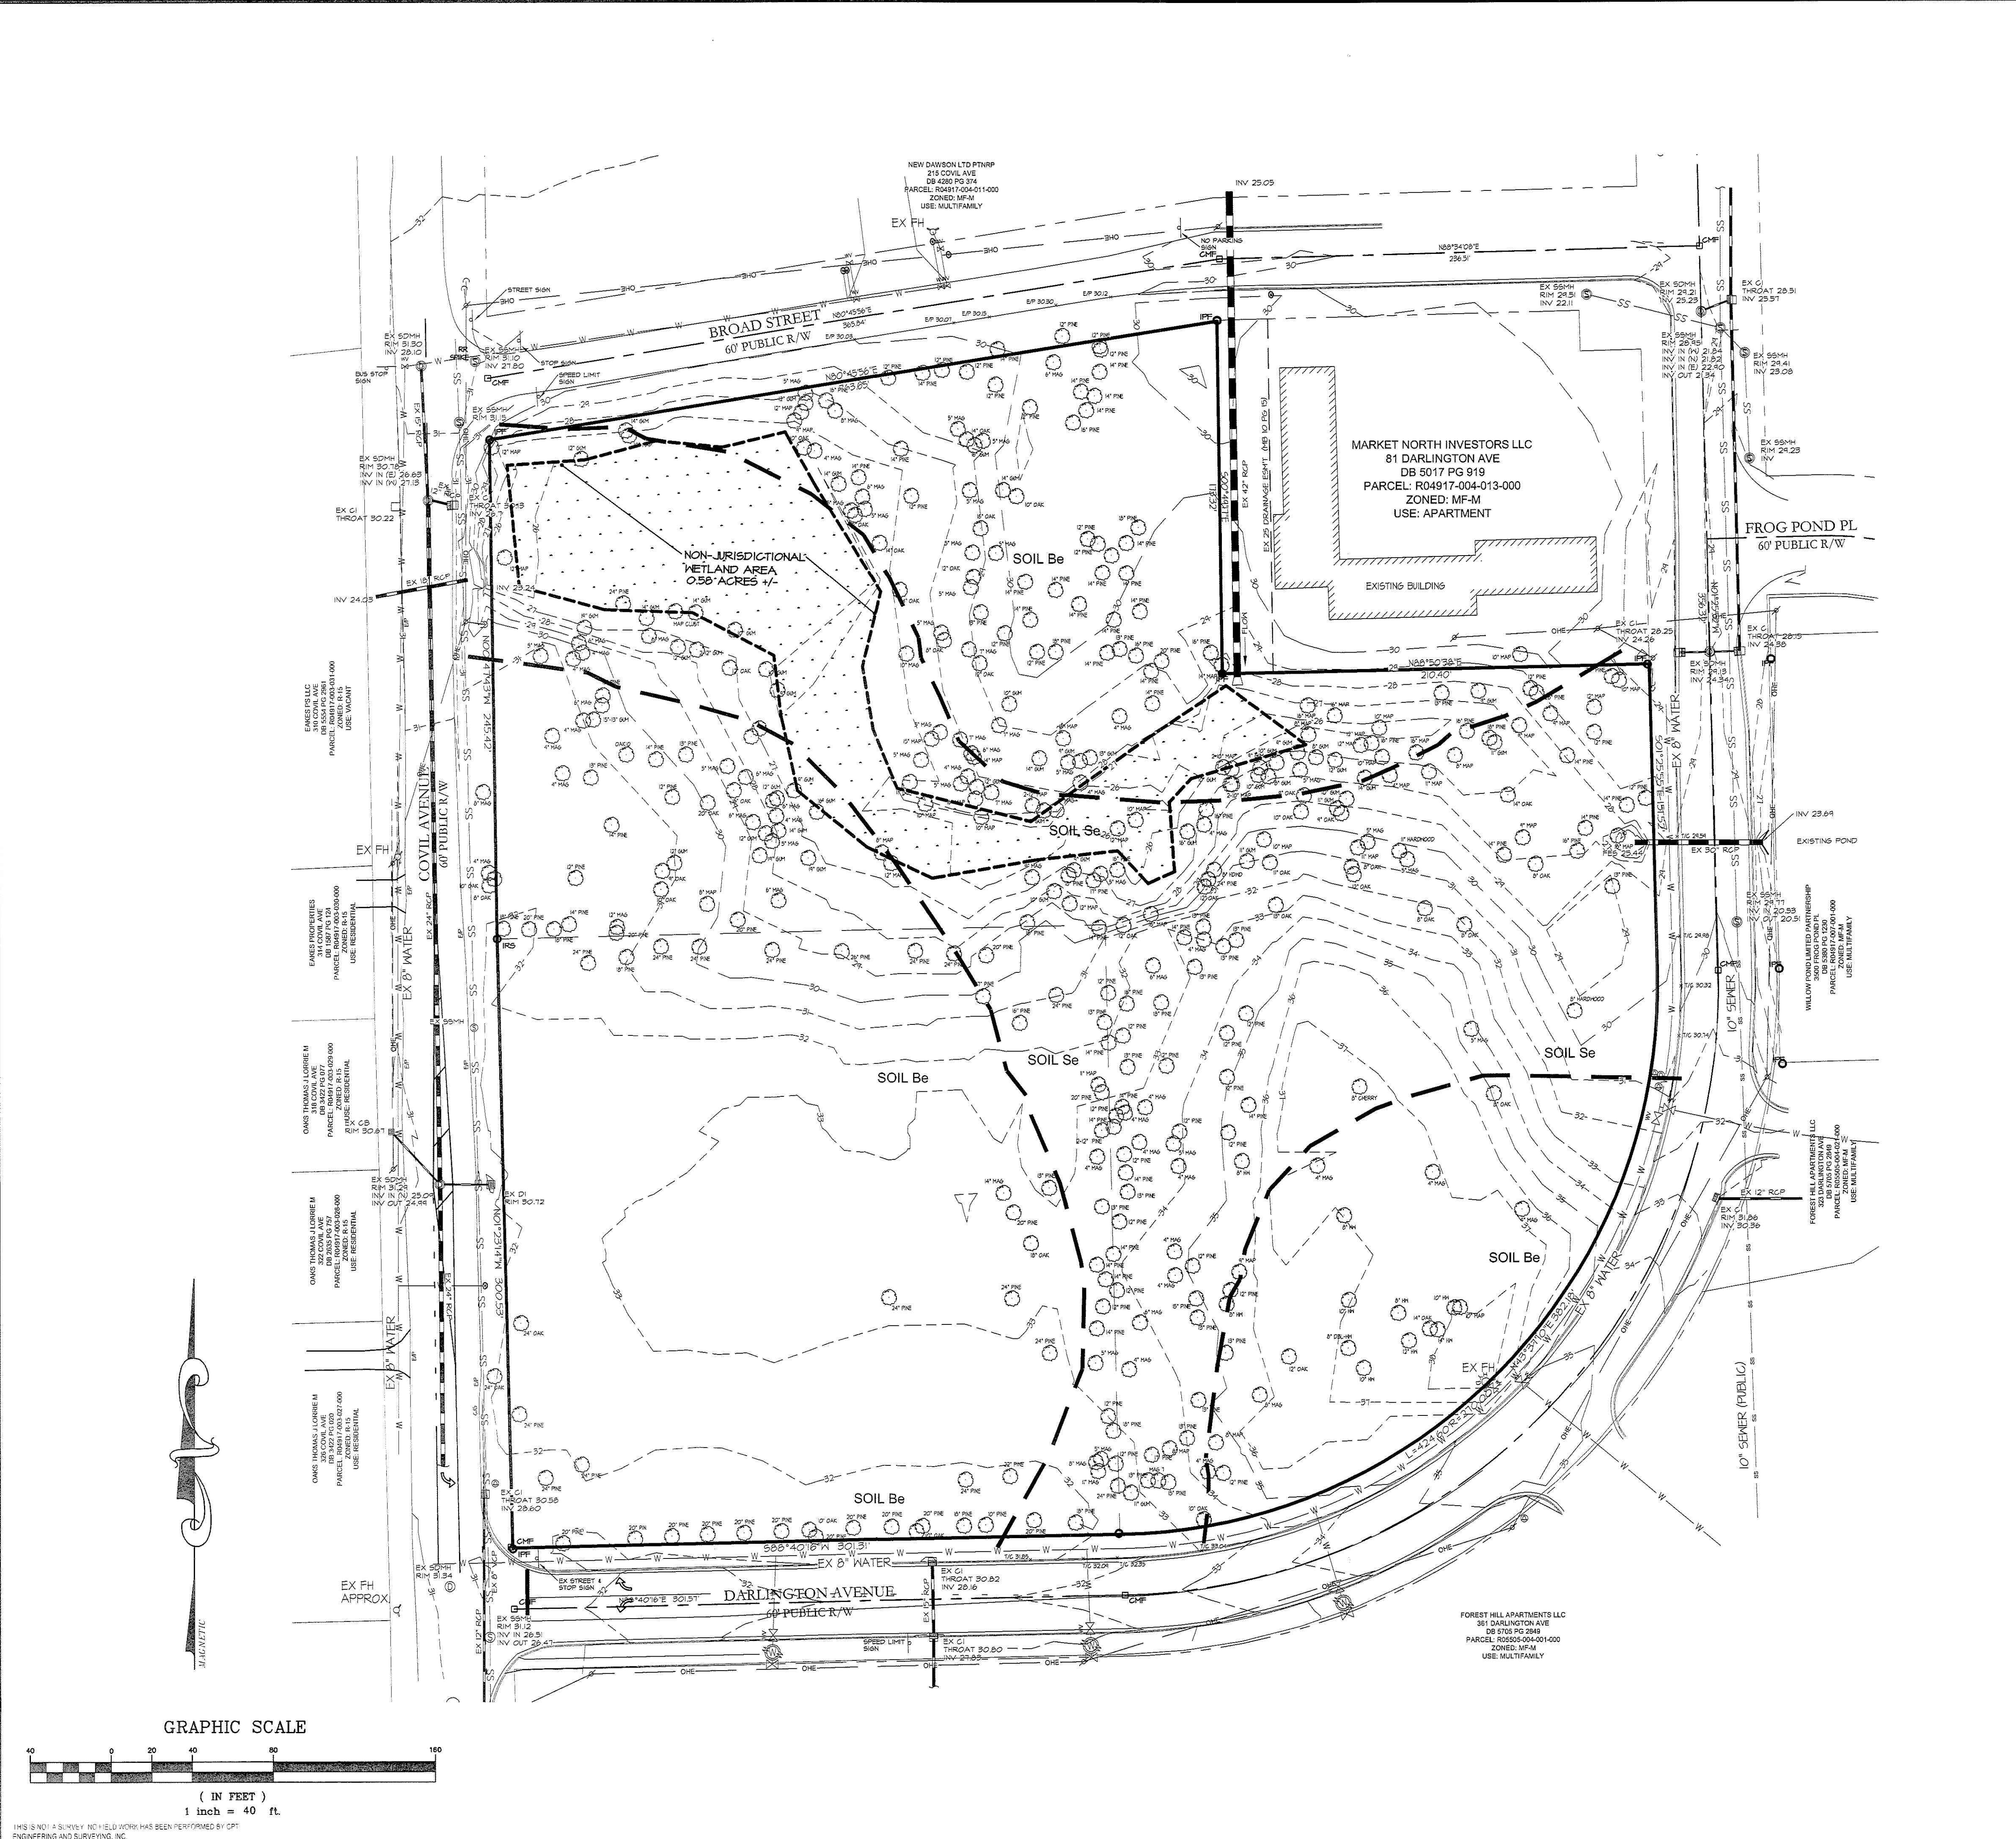

**SITE INFORMATION:**

SITE ACREAGE: 6.4± AC.  
 EXISTING ZONING: MF-MH (CD)  
 SITE ADDRESS: 315 & 323 COVIL AVE.  
 PARCEL ID: R05505-004-015-000 & R04917-004-012-000  
 DEED REFERENCE: DEED BOOK 5673, PAGE 2248  
 ACCORDING TO WWW.NCHISTORICSITES.ORG AND WWW.NATIONALREGISTEROFHISTORICPLACES.COM, THE SITE DOES NOT CONTAIN A RECOGNIZED STATE OR FEDERAL HISTORIC SITE.  
 ACCORDING TO WWW.NCGENWEB.US/NEWHANOVER/CEMETERIES3.HTML THERE ARE NO CEMETERIES, BURIAL SITES OR BURIAL GROUNDS LOCATED ON THE SITE.  
 ACCORDING TO WWW.FWS.GOV THERE ARE NO PROTECTED SPECIES HABITATES LOCATED ON THE SITE.  
 THERE ARE NO PROPOSED THOROUGHFARES, BIKE ROUTES, TRAILS OR TRANSIT FACILITIES LOCATED ON SITE.  
 CAMA LAND USE CLASSIFICATION: URBAN  
 SITE DRAINS TO EXISTING STORM LOCATED ON COVIL AVENUE


**TREE LEGEND:**

MAP = MAPLE  
 MAG = MAGNOLIA  
 HW = HARDWOOD  
 DBL = DOUBLE

**REVISIONS**

1	REV PER CITY COMMENTS
06-18-2015	

**ENGINEERING AND SURVEYING, INC.**  
 4400 TYNING STREET  
 HIGH POINT, NORTH CAROLINA 27345  
 PHONE: (858) 512-8800 ~ FAX: (858) 512-8780

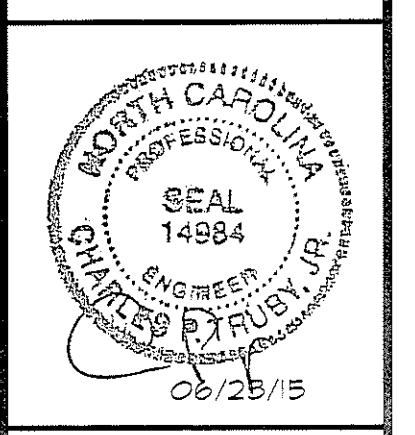


**SITE INVENTORY MAP**  
**ANNEXE AT THE RESERVE**  
 CITY OF WILMINGTON ~ WILMINGTON TOWNSHIP  
 NEW HANOVER COUNTY, NORTH CAROLINA

315 & 323 COVIL AVE.

**SITE INVENTORY MAP**

SCALE:	1" = 40'
DATE:	03/17/15
PROJECT:	1140-12
DRAWN BY:	TGL
SHEET	C-4

GRAPHIC SCALE

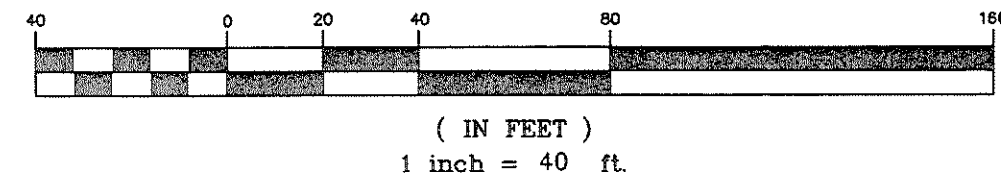

THIS IS NOT A SURVEY. NO FIELD WORK HAS BEEN PERFORMED BY CPT ENGINEERING AND SURVEYING, INC.



1. Prior to any clearing, grading or construction activity, tree protection fencing shall be installed around protected trees or groves of trees. No construction workers, tools, materials, or vehicles are permitted within the tree protection fencing.

2. Any tree or trees to be removed shall be properly documented with a tree removal permit and protected throughout construction to ensure that no clearing, grading or staging of materials will occur in those areas.

3. No equipment is allowed on site and all tree protection fencing and all fencing is installed and approved. Protective fencing is to be maintained throughout the duration of the project, and contractors shall maintain adequate instruction on the protection methods.

4. All personnel in public sight areas for conveyance are to be therapeutic and meet City and NCDOT standards.

5. Once streets are open to traffic, contact Traffic Engineering regarding the installation of traffic and street name signs. Proposed street names must be approved prior to installation of street name signs.

6. Traffic control devices (including signs and pavement markings) in areas open to public traffic are to meet MUTCD (Manual on Uniform Traffic Control Devices) standards.

7. Contact Traffic Engineering at 910-341-7888 to ensure that all traffic signs and equipment are shown on the plan.

8. Call Traffic Engineering at 910-341-7888 for any questions (888) hours prior to any excavation in the right-of-way.

9. Traffic Engineering must approve all pavement markings prior to installation.

10. All parking stall markings and line areas within the parking areas shall be white.

11. All traffic control signs and markings on the site shall be maintained by the property owner in accordance with MUTCD standards.

12. Stop signs and street signs to remain in place during construction.

13. Traffic warning signs shall be installed on all construction areas.

14. A utility cut permit is required for each open cut of a city street. Contact 341-5888 for more details.

15. Any broken or missing sidewalk panels, curbs, gutters and curbs will be replaced.

16. Contact Traffic Engineering at 910-341-7888 to discuss street lighting options.

17. Water and sewer lines shall be installed in accordance with City Public Utility (CPUL) plans and specifications.

18. Project shall comply with CPUL's Cross Connection Control requirements. Water meters cannot be released until all requirements are met and the State has given their final approval. Call 341-5888 for more information.

19. If the contractor desires CPUL water for construction, he shall apply in advance for this service and must provide a reduced pressure zone (RPZ) backflow prevention device on the developer's side of the water meter box.

20. Any irrigation system supplied by CPUL water shall comply with the CPUL's Cross Connection Control regulations. Call 341-5888 for information.

21. Any irrigation system shall be equipped with a rain and freeze sensor.

22. Any backflow prevention device required by the CPUL will need to be on the lot of approved devices. Call 341-5888 for information.

23. Contractor to field verify existing water and sewer service locations, sizes and materials prior to construction. Engineer to be notified of any conflicts.


24. Contractor shall maintain adequate access for emergency vehicles at all times during construction.

25. Underground fire lines must be permitted and inspected by the Wilmington Fire Department from the public right-of-way to the building.

26. No obstructions are permitted in the space between thirty (30) inches and ten (10) feet above the ground within the triangular sight distance.

27. Contact the North Carolina Dept. of Transportation at 1-800-622-4949 prior to doing any digging, clearing, or grading.

28. Contact the North Carolina Dept. of Transportation at 1-800-622-4949 prior to doing any digging, clearing, or grading.

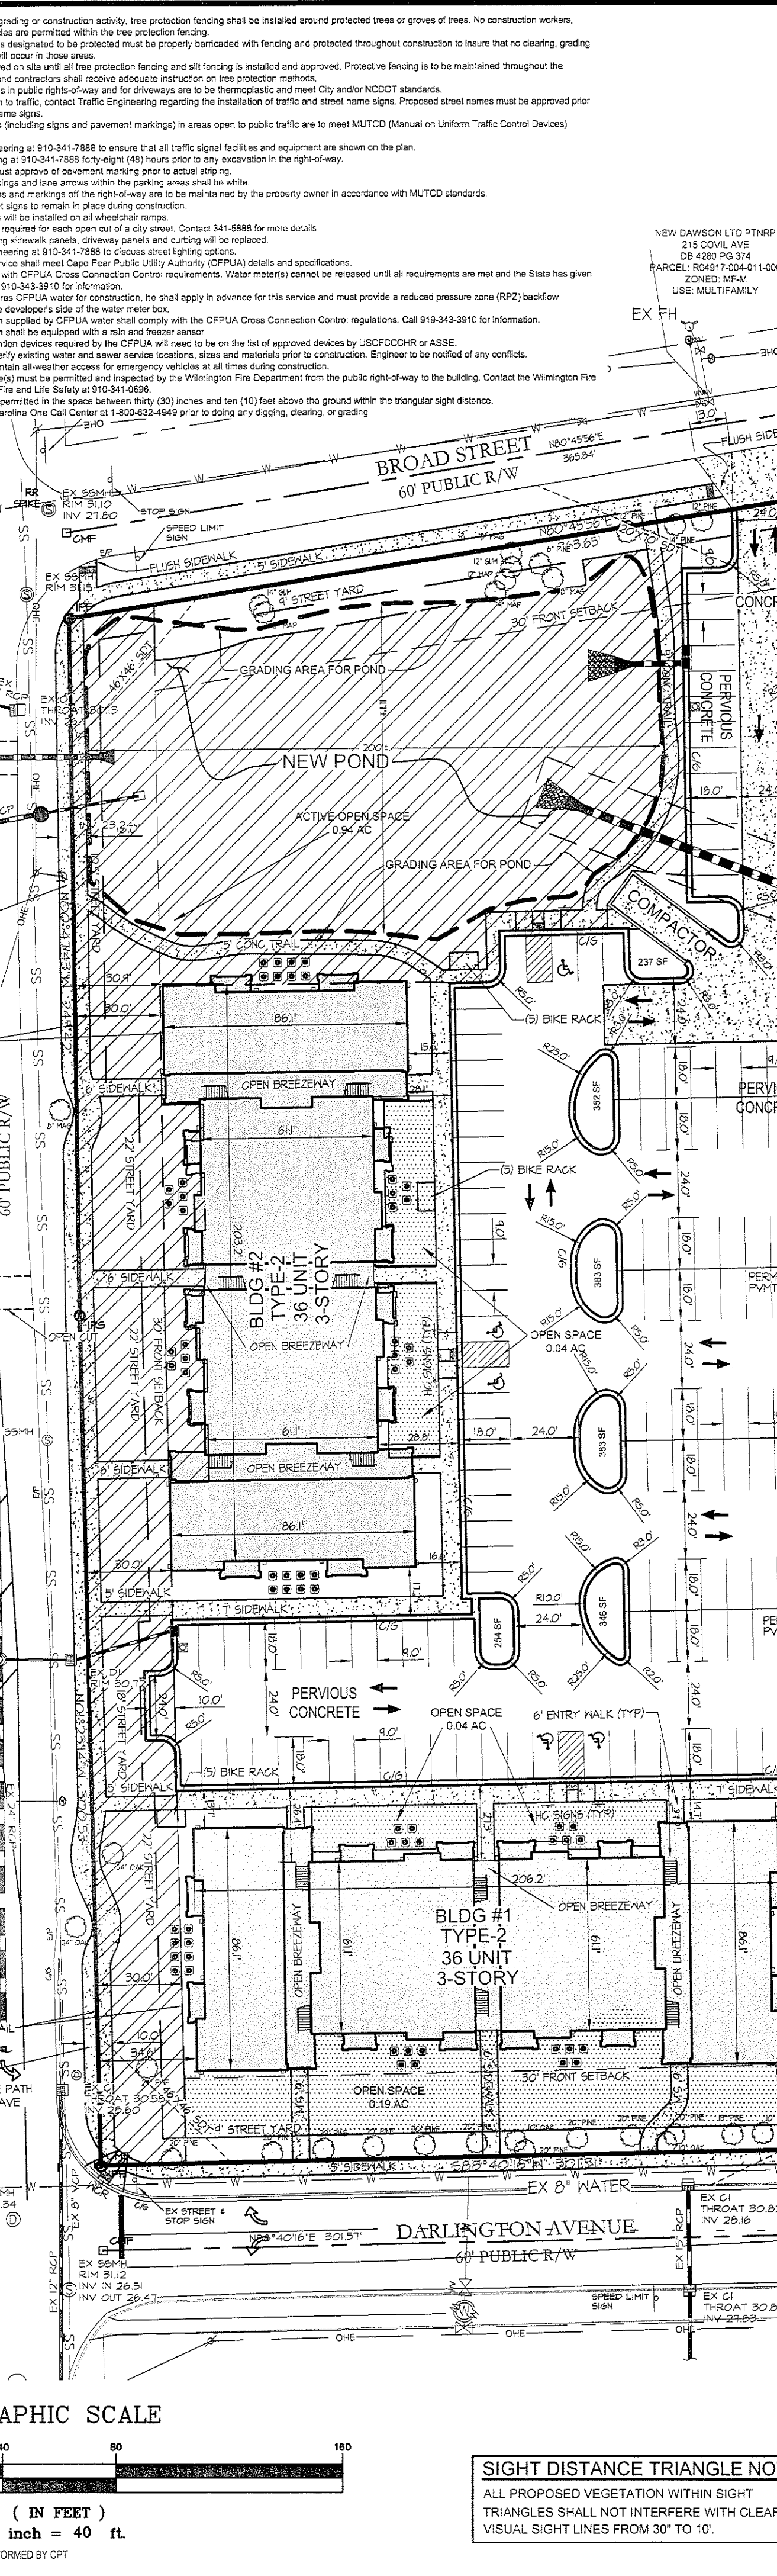

**GENERAL NOTES:**

A. ALL SIGNS AND PAVEMENT MARKINGS IN AREAS OPEN TO PUBLIC TRAFFIC ARE TO MEET MUTCD (MANUAL ON UNIFORM TRAFFIC CONTROL DEVICES) STANDARDS.

B. IT SHALL BE THE RESPONSIBILITY OF THE SUBDIVIDER TO ERECT OFFICIAL STREET NAME SIGNS AT ALL INTERSECTIONS ASSOCIATED WITH THE SUBDIVISION IN ACCORDANCE WITH THE TECHNICAL STANDARDS AND SPECIFICATIONS MANUAL. THE SUBDIVIDER MAY ACQUIRE AND ERECT OFFICIAL STREET NAME SIGNS OR MAY CHOOSE TO CONTRACT WITH THE CITY TO INSTALL THE STREET SIGNS AND THE SUBDIVIDER SHALL PAY THE COST OF SUCH INSTALLATION. CONTACT TRAFFIC ENGINEERING AT 341-7888 TO DISCUSS INSTALLATION OF TRAFFIC AND STREET NAME SIGNS. PROPOSED STREET NAMES MUST BE APPROVED PRIOR TO INSTALLATION OF STREET NAME SIGNS.

C. ANY FREESTANDING SIGN(S) ON THE SITE SHALL BE MONUMENT STYLE WITH LANDSCAPING AROUND THE BASE OF THE SIGN; NO POLE SIGNS SHALL BE PERMITTED AND INTERNAL ILLUMINATION SHALL BE PROHIBITED.

**HVAC EQUIPMENT, AIR CONDITIONING WINDOW UNITS, ELECTRIC EQUIPMENT, FIRE ESCAPES, SOLID WASTE FACILITIES AND OTHER UTILITY EQUIPMENT SHALL NOT BE LOCATED ALONG FACADES WITH STREET FRONTAGE.**

**MARKET NORTH INVESTORS LLC**  
81 DARLINGTON AVE  
DB 5017 PG 919  
PARCEL: R04917-004-013-000  
ZONED: MF-M  
USE: APARTMENT

**BLDG #1 TYPE-2 36 UNIT 3-STORY**

**BLDG #2 TYPE-2 36 UNIT 3-STORY**

**BLDG #3 TYPE-1 36 UNIT 3-STORY**

**BLDG #4 TYPE-1 36 UNIT 3-STORY**

**GRAPHIC SCALE**  
(IN FEET)  
1 inch = 40 ft

**SIGHT DISTANCE TRIANGLE NOTE:**  
ALL PROPOSED VEGETATION WITHIN SIGHT TRIANGLES SHALL NOT INTERFERE WITH CLEAR VISUAL SIGHT LINES FROM 30' TO 10'.

**CONSTRUCTION ACCESS NOTE:**  
THE USE OF COVIL AVE FOR DRIVEWAY ACCESS TO THE SITE BY COMMERCIAL VEHICLES DURING CONSTRUCTION SHALL BE PROHIBITED.

**NOTE:**  
SEE ARCHITECTURAL PLANS FOR TYPE "A" HANDICAP ACCESSIBLE UNIT LOCATIONS. THIS INFORMATION WILL BE LOCATED ON THE ARCHITECTURAL SITE PLAN.

**IMPERVIOUS SURFACE CALCULATIONS**

	PARKING/PARKING		IMPERVIOUS TOTALS	
	AREA # 1	AREA # 2	AREA # 3	AREA # 4
	ACRES / SQ. FT.	ACRES / SQ. FT.	ACRES / SQ. FT.	ACRES / SQ. FT.
BUILDINGS	0.195 AC / 8,403 SF	0.97 AC / 42,116 SF	0.177 AC / 7,711 SF	→ 88,230 SF
SIDEWALK	0.038 AC / 1,652 SF	0.234 AC / 10,188 SF	0.041 AC / 1,792 SF	→ 13,632 SF
CURB & GUTTER	0.014 AC / 610 SF	0.137 AC / 5,965 SF	0.014 AC / 610 SF	→ 7,185 SF
PERVIOUS CONCRETE	0.144 AC / 6,294 SF	0.570 AC / 24,636 SF	0.152 AC / 6,609 SF	→ 31,539 SF
REGULAR CONCRETE	0	0.217 AC / 9,472 SF	0	→ 9,472 SF
TOTAL BUA	0.386 AC / 16,829 SF	3.126 AC / 136,149 SF	0.384 AC / 16,717 SF	→ 169,695 SF
DRAINAGE AREA	0.443 AC / 19,212 SF	0.495 AC / 21,450 SF	0	→ 4.68 AC

\* TOTAL DRAINAGE AREA: 4.68 ACRES

**TREE LEGEND:**  
MAP = MAPLE  
MAG = MAGNOLIA  
HW = HARDWOOD  
DBL = DOUBLE

**SITE INFORMATION:**  
SITE ACREAGE: 6.43 AC  
EXISTING ZONING: MF-MH (CD)  
SITE ADDRESS: 315 & 323 COVIL AVE.  
PARCEL ID: R05505-004-015-000 & R04917-004-012-000  
DEED REFERENCE: DEED BOOK 5673, PAGE 2248  
TOTAL NUMBER OF BUILDINGS: 4 (3 STORY)  
TOTAL NUMBER OF UNITS: 144  
USE: APARTMENTS  
UNIT MIX:  
48 (1 BEDROOM)  
72 (2 BEDROOM)  
24 (3 BEDROOM)  
MAXIMUM DENSITY ALLOWED PER ZONING: 25 UNITS / AC  
DENSITY SHOWN: 22.5 UNITS / AC  
BUILDING HEIGHT: 45 FT

**PARKING CALCULATION:**  
PARKING REQUIRED:  
48 (1 BEDROOM) X 1.5 = 72  
72 (2 BEDROOM) X 2.0 = 144  
24 (3 BEDROOM) X 2.25 = 54  
TOTAL REQUIRED = 270

**ADA PARKING:**  
ADA PARKING REQUIRED:  
201 - 300 = 7 SPACES  
(1 REQUIRED TO BE VAN SPACE)  
TOTAL ADA SPACES PROVIDED: 9 SPACES

**BUILDING SETBACKS (MF-MH):**  
FRONT: 30 FT  
REAR: 25 FT  
INTERIOR SIDE: 20 FT  
ADDITIONAL REAR AND SIDE YARD SETBACKS FOR BLDG HEIGHT ABOVE 35 FEET:  
FIRST 10 FEET ABOVE 35 FEET: 4 FEET FOR EACH 10 FOOT INCREMENT, OR PORTION THEREOF  
10.1 FEET TO 30 FEET ABOVE 35 FEET: 6 FEET FOR EACH 10 FOOT INCREMENT  
30.1 FEET OR MORE ABOVE 35 FEET: 8 FEET FOR EACH 10 FOOT INCREMENT

**SETBACK TABLE:**  
BLDG #1 FRONT: 30' MIN. 30.7' ACTUAL (DARLINGTON) 34.6' (COVIL)  
BLDG #2 FRONT: 30' MIN. 30.0' - 30.9' ACTUAL (COVIL)  
BLDG #3 FRONT: 30' MIN. 31.1' ACTUAL (DARLINGTON)  
BLDG #4 FRONT: 30' MIN. 33.8' ACTUAL (DARLINGTON)  
INTERIOR SIDE: 20 + 4 = 24' MIN. 26.4' - 32.5' ACTUAL

**OPEN SPACE:**  
TOTAL OPEN SPACE REQUIRED: 6.4 X 0.35 = 2.24 AC  
REQUIRED ACTIVE OR PASSIVE: 2.24 X 0.5 = 1.12 AC  
REQUIRED ACTIVE, PASSIVE, OR OPEN SPACE: 2.24 X 0.5 = 1.12 AC  
PROVIDED (ACTIVE): 1.58 AC  
PROVIDED (OPEN SPACE): 0.44 AC  
TOTAL PROVIDED: 2.02 AC  
(THIS SITE IS 9,583 SF UNDER THE REQUIRED OPEN SPACE, FEE IN LIEU OF WILL BE REQUIRED)

**BUILT-UPON CALCULATION:**  
EXISTING BUA: 14,039 SF (TO BE REMOVED)  
PROPOSED:  
BUILDINGS: 58,230 SF (20.9% LOT COVERAGE)  
PARKING LOT AND DRIVES: 81,283 SF (PERVIOUS CONCRETE)  
SIDEWALKS & POOL: 38,339 SF  
TOTAL: 177,852 SF OR 7.69 AC  
(INCLUDES PERVIOUS CONCRETE)  
WITH PERVIOUS CONCRETE CREDIT:  
58,230 + 81,283 (0.25) + 38,339 SF = 116,899 SF OR 2.68 AC  
BUILT UPON AREA % = 2.68 AC / 6.4 AC = 41.87%

ALL THE NECESSARY APPROVALS HAVE BEEN OBTAINED FROM THE STATE/ CORPS FOR ANY WETLAND DISTURBANCE AND STREAM CROSSING/DISTURBANCE

**REVISIONS**

NO.	REV PER CITY COMMENTS	DATE
1	REV PER CITY COMMENTS	06-16-2015

**VICINITY MAP**  
SCALE: 1" = 1000'

**RETAINING WALL NOTES:**

- PROPOSED RETAINING WALLS ARE FOR ILLUSTRATION PURPOSES ONLY. DEPICTING CHANGE IN GRADE REQUIREMENTS. CPT ENGINEERING AND SURVEYING, INC. IS NOT RESPONSIBLE FOR RETAINING WALL DESIGNS.
- RETAINING WALL PERMITS WILL BE REQUIRED BY THE CITY OF WILMINGTON INSPECTIONS DEPARTMENT.
- ANY RETAINING WALL > 4' REQUIRE A BUILDING PERMIT FROM BUILDING INSPECTIONS.

**GENERAL H.C. ACCESSIBILITY NOTES:**

- LANDINGS OUTSIDE ALL DOORS SHALL BE SIZED PER NCBC, BE AT THE SAME ELEVATION AS THE FFE, AND SHALL HAVE A MAX. 2% SLOPE IN ANY DIRECTION INCLUDING IN THE DIAGONAL.
- THE SLOPES IN THE H.C. PARKING SPACE/ACCESS AISLE SHALL NOT EXCEED 2% IN ANY DIRECTION INCLUDING IN THE DIAGONAL.
- THERE SHALL BE NO DESIGNATED PEDESTRIAN ROUTES/SIDEWALKS WITHIN THE SITE, EXCEPT WHERE LABELED AS A RAMP WITH RAILS, WHICH EXCEED A 5% SLOPE IN THE DIRECTION OF TRAVEL AND A 2% CROSS-SLOPE.
- ALL PEDESTRIAN ROUTES > 5% (1:20), IF ANY, ARE LABELED AS 'RAMPS' SHOWING SLOPE, LEVEL LANDINGS AT TOP AND BOTTOM (MAX. 2% SLOPE IN ANY DIRECTION INCLUDING IN THE DIAGONAL), RAILINGS/GUARDRAILS, AND SHALL COMPLY WITH NCBC.
- THERE SHALL BE LEVEL TURNING AREAS (MAX. 2% SLOPE IN ANY DIRECTION INCLUDING IN THE DIAGONAL) ON ALL SIDEWALKS (INCLUDING SIDEWALKS ALONG STREETS) WHERE AN INTERSECTING SIDEWALK CONNECTS WITH IT.
- ALL STAIRS SHALL HAVE SLIGHTLY SLOPED LANDINGS (MAX. 2% SLOPE IN ANY DIRECTION INCLUDING IN THE DIAGONAL), AT THE TOP AND BOTTOM AND SHALL COMPLY WITH NCBC.
- STAIRS / STEPS WITH LESS THAN A 12" ELEVATION CHANGE SHALL COMPLY WITH NCBC 1003.5
- THE SLOPES AT THE PASSENGER LOADING ZONE AND ADJACENT VEHICLE PULL UP SPACE SHALL NOT EXCEED 2% IN ANY DIRECTION INCLUDING IN THE DIAGONAL.

**NOTE:**  
ALL FILL PLACED BETWEEN EXISTING GROUND AND BOTTOM OF STONE BEDDING IN PERVIOUS PARKING AREAS SHALL BE CLEAN SAND.

**MEDIA REQUIREMENTS NOTE:**  
ALL FILL MATERIAL PLACED WITHIN THE INFILTRATION BASINS OR UNDER PERVIOUS CONCRETE SHALL BE CLEANED, WASHED, COURSE MASONRY SAND SUCH AS ASTM C33. THE SAND PARTICLES SHALL BE LESS THAN 2 mm AVERAGE DIAMETER.

**BICYCLE PARKING:**  
EACH NEW COMMERCIAL OR OFFICE DEVELOPMENT REQUIRING 25 OR MORE AUTO PARKING SPACES SHALL MAKE PROVISIONS FOR PARKING A MINIMUM OF 5 BICYCLES. EACH ADDITIONAL 100 AUTO PARKING SPACES ABOVE THE MINIMUM 25 SPACES SHALL REQUIRE PROVISIONS FOR PARKING OF 5 ADDITIONAL BICYCLES UP TO A MAXIMUM OF 25 BICYCLES. BICYCLE PARKING FACILITIES SHALL BE PROVIDED WITHIN 20 FEET OF THE PRIMARY ENTRANCE TO THE FACILITY. (SEE LOCATIONS ON PLAN)

AUTO PARKING SPACES:	BICYCLES REQUIRED:
25	5
+100	5
+100	5
+100	5
+25	5
= 351 AUTO SPACES	= 25 MAX.

\*\* DUE TO A CONDITION ON THIS SITE, REQUIRED BICYCLE PARKING IS: 30 SPACES  
BICYCLE PARKING PROVIDED: 30 SPACES

**TYPICAL PARKING SPACE DETAIL**  
N.T.S.

**OWNER / DEVELOPER:**  
BRC WILMINGTON LLC  
5506 SAIKET DRIVE, SUITE 105  
HIGH POINT, NC 27285  
PHONE: (336) 888-1512  
FAX: (336) 889-1501

**ENGINEER:**  
CPT ENGINEERING & SURVEYING, INC.  
4400 TYNING STREET  
HIGH POINT, NC 27285  
CONTACT: CHUCK TRUBY, P.E.  
PHONE: (336) 812-8800 ext:304  
FAX: (336) 812-8780

**APPROVED CONSTRUCTION PLAN**

Name: \_\_\_\_\_ Date: \_\_\_\_\_

Planning: \_\_\_\_\_

Traffic: \_\_\_\_\_

Fire: \_\_\_\_\_

Date: \_\_\_\_\_ Permit # \_\_\_\_\_

Signed: \_\_\_\_\_

**ANNEXE AT THE RESERVE**  
CITY OF WILMINGTON ~ WILMINGTON TOWNSHIP  
NEW HANOVER COUNTY, NORTH CAROLINA

**SITE PLAN**  
315 & 323 COVIL AVE.

**SITE PLAN**

SCALE: 1" = 40'

DATE: 03/17/15

PROJECT: 1140-12



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SHEET C-5

**ENGINEERING AND SURVEYING, INC.**  
CPT ENGINEERING & SURVEYING, INC.  
CORPORATE LICENSE NUMBER: 01819  
4400 TYNING STREET  
HIGH POINT, NORTH CAROLINA 27285  
PHONE: (336) 812-8800 ~ FAX: (336) 812-8780

**SEAL**  
14984  
CHUCK TRUBY, P.E.  
06/25/15




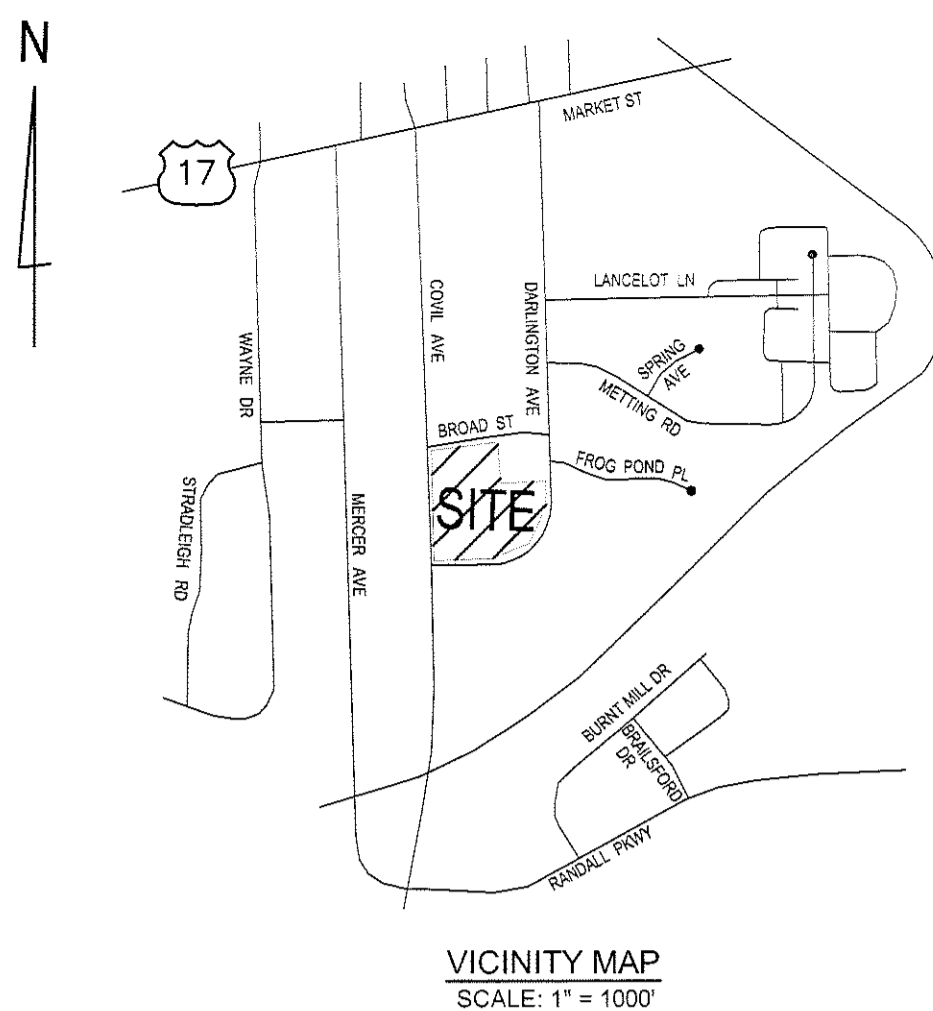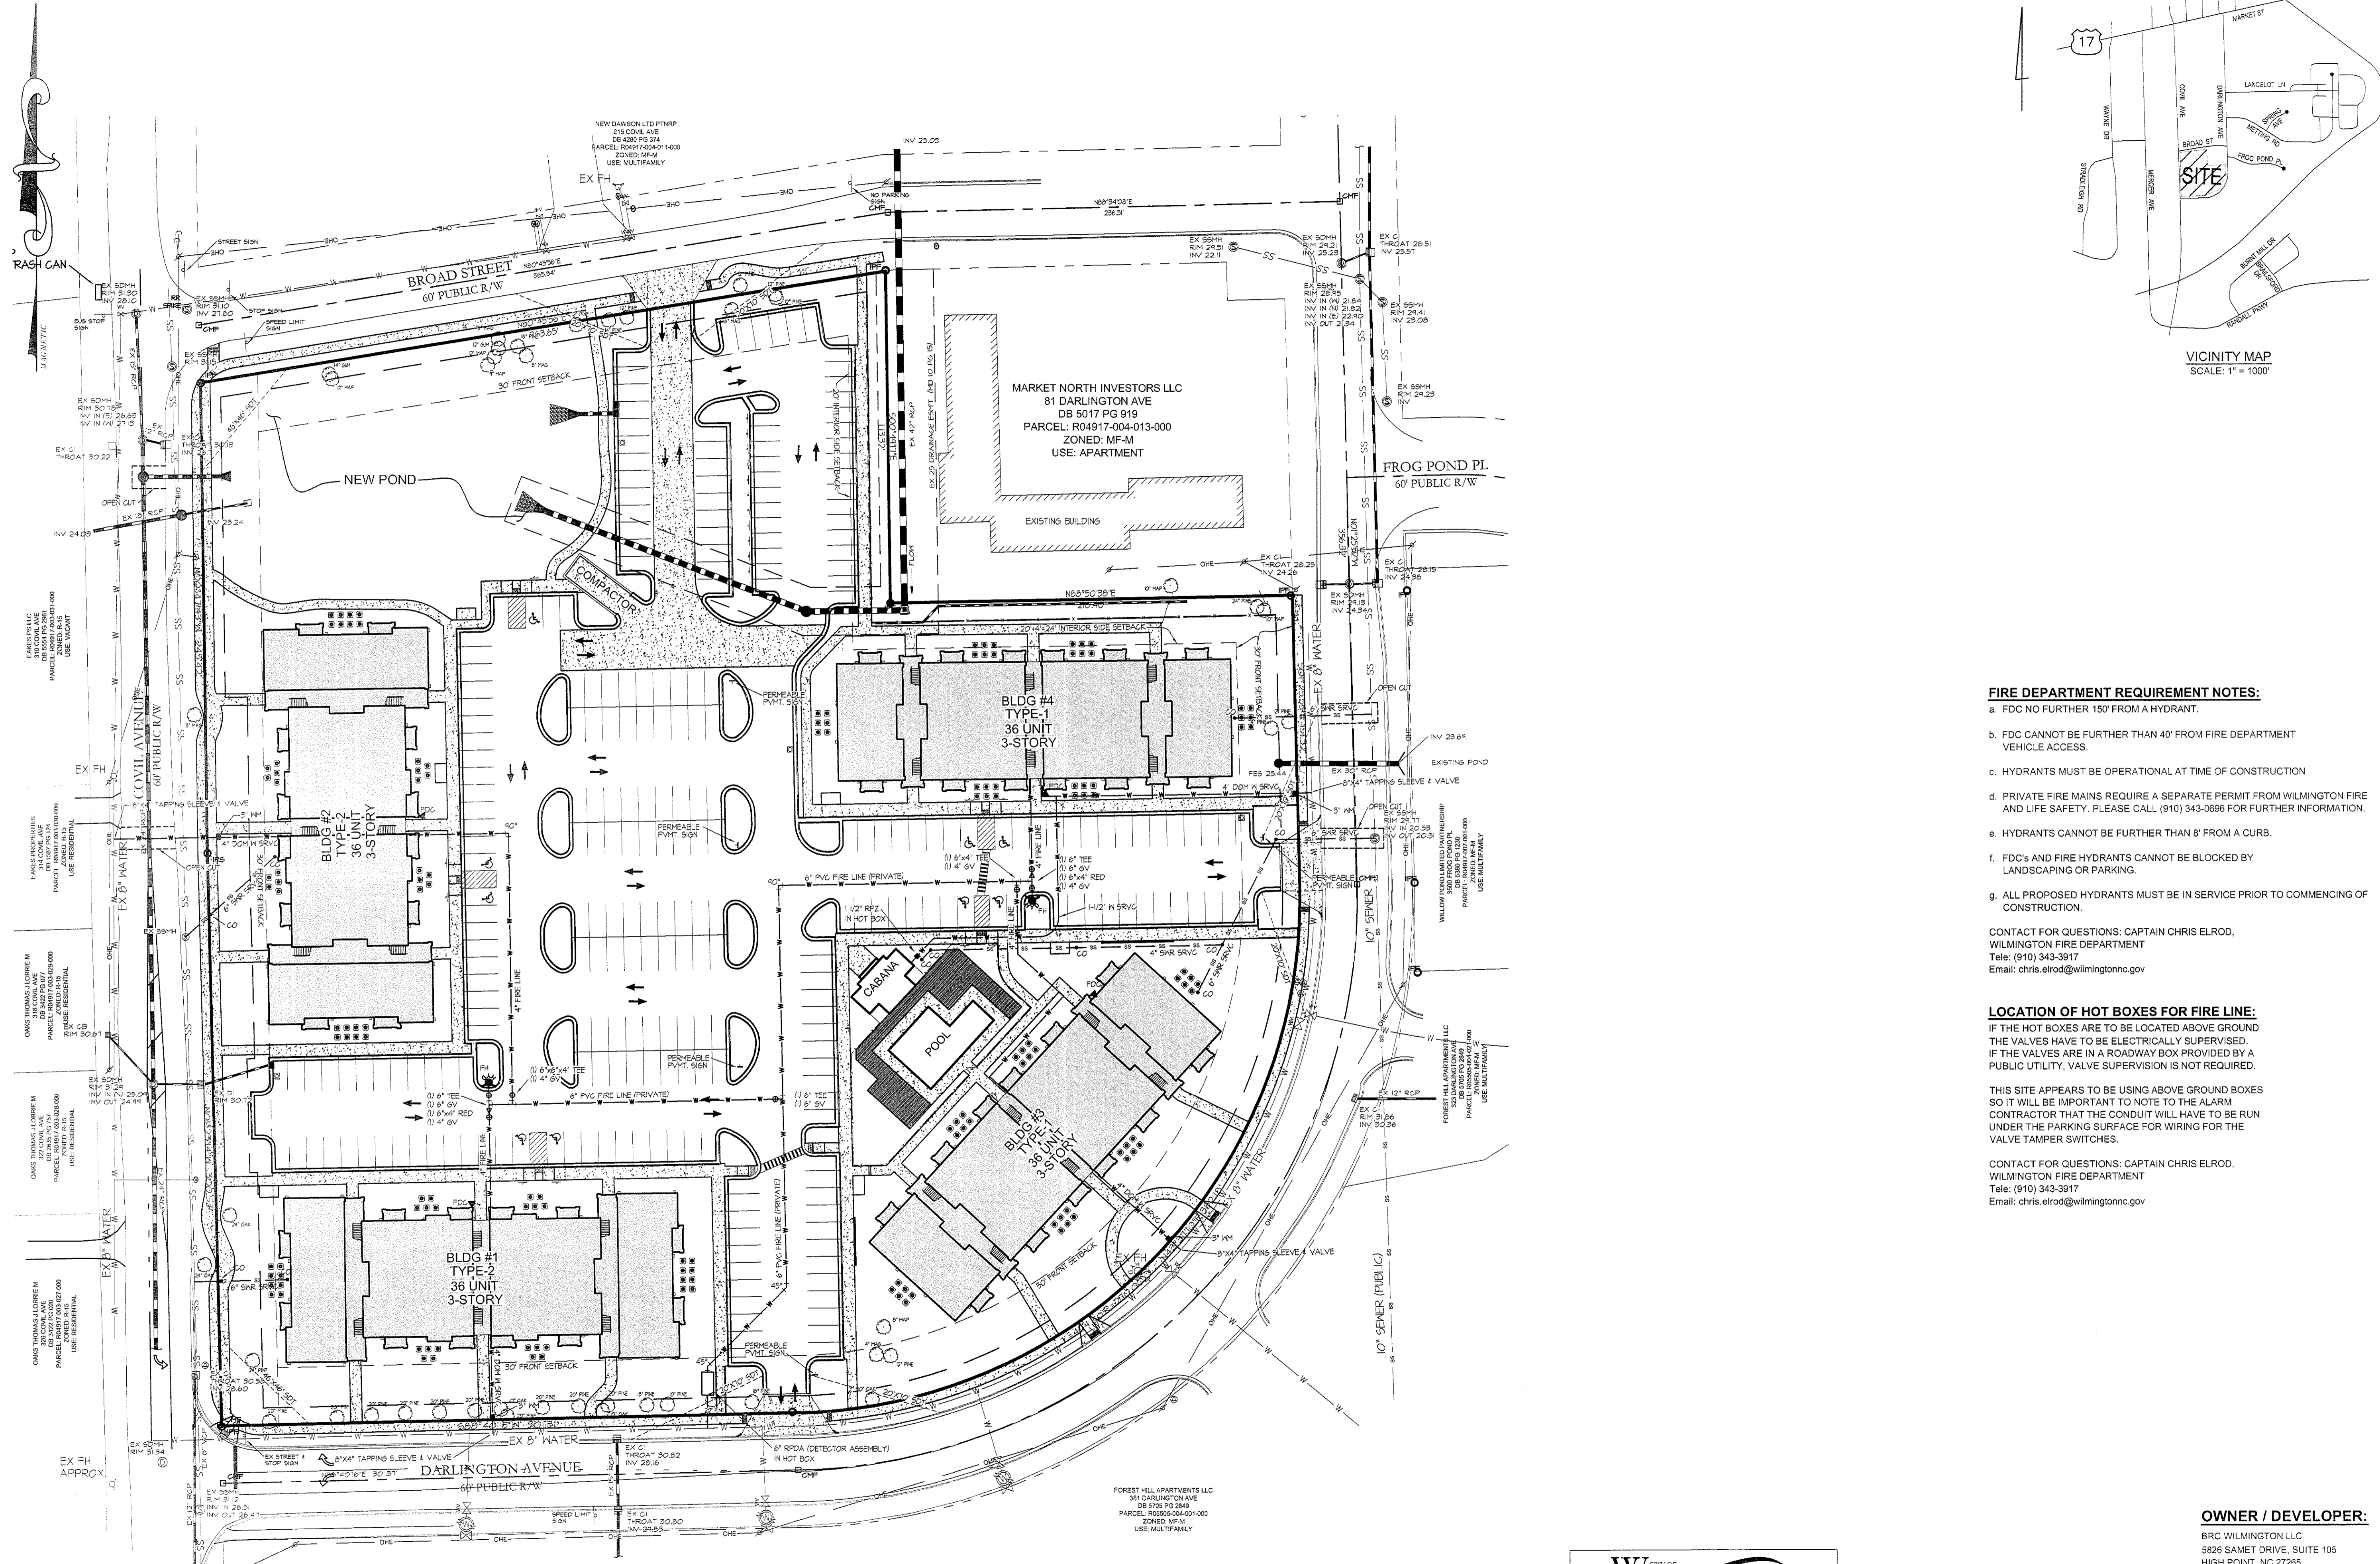

**REVISIONS**

REV	PER	CITY COMMENTS
02-18-2015		

**ENGINEERING AND SURVEYING, INC.**  
 LAND DEVELOPMENT CONSULTING  
 CORPORATE LICENSE NUMBER C-1515  
 4400 TYNING STREET  
 HIGH POINT, NORTH CAROLINA 27265  
 PHONE: (336) 812-8800 ~ FAX: (336) 812-8180

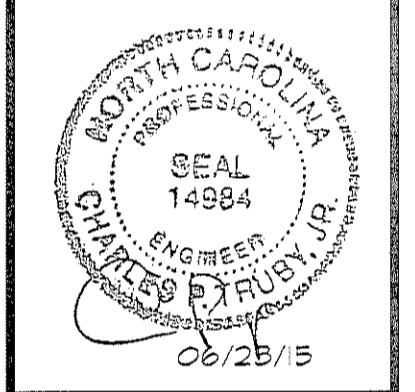

- FIRE DEPARTMENT REQUIREMENT NOTES:**
- FDC NO FURTHER 150' FROM A HYDRANT.
  - FDC CANNOT BE FURTHER THAN 40' FROM FIRE DEPARTMENT VEHICLE ACCESS.
  - HYDRANTS MUST BE OPERATIONAL AT TIME OF CONSTRUCTION
  - PRIVATE FIRE MAINS REQUIRE A SEPARATE PERMIT FROM WILMINGTON FIRE AND LIFE SAFETY. PLEASE CALL (910) 343-0896 FOR FURTHER INFORMATION.
  - HYDRANTS CANNOT BE FURTHER THAN 8' FROM A CURB.
  - FDC'S AND FIRE HYDRANTS CANNOT BE BLOCKED BY LANDSCAPING OR PARKING.
  - ALL PROPOSED HYDRANTS MUST BE IN SERVICE PRIOR TO COMMENCING OF CONSTRUCTION.

CONTACT FOR QUESTIONS: CAPTAIN CHRIS ELROD,  
 WILMINGTON FIRE DEPARTMENT  
 Tele: (910) 343-3917  
 Email: chris.elrod@wilmingtonnc.gov

**LOCATION OF HOT BOXES FOR FIRE LINE:**  
 IF THE HOT BOXES ARE TO BE LOCATED ABOVE GROUND THE VALVES HAVE TO BE ELECTRICALLY SUPERVISED. IF THE VALVES ARE IN A ROADWAY BOX PROVIDED BY A PUBLIC UTILITY, VALVE SUPERVISION IS NOT REQUIRED.

THIS SITE APPEARS TO BE USING ABOVE GROUND BOXES SO IT WILL BE IMPORTANT TO NOTE TO THE ALARM CONTRACTOR THAT THE CONDUIT WILL HAVE TO BE RUN UNDER THE PARKING SURFACE FOR WIRING FOR THE VALVE TAMPER SWITCHES.

CONTACT FOR QUESTIONS: CAPTAIN CHRIS ELROD,  
 WILMINGTON FIRE DEPARTMENT  
 Tele: (910) 343-3917  
 Email: chris.elrod@wilmingtonnc.gov

**UTILITY PLAN**  
**ANNEXE AT THE RESERVE**  
 CITY OF WILMINGTON ~ WILMINGTON TOWNSHIP  
 NEW HANOVER COUNTY, NORTH CAROLINA


915 & 928 COVIL AVE.

**UTILITY PLAN**

SCALE:	1" = 40'
DATE:	03/17/15
PROJECT:	1140-12
DRAWN BY:	TGL
SHEET	C-6

**OWNER / DEVELOPER:**  
 BRC WILMINGTON LLC  
 5826 SAMET DRIVE, SUITE 105  
 HIGH POINT, NC 27285  
 PHONE: (336) 888-1512  
 FAX: (336) 888-1501

**ENGINEER:**  
 CPT ENGINEERING & SURVEYING, INC.  
 4400 TYNING STREET  
 HIGH POINT, NC 27265  
 CONTACT: CHUCK TRUBY, P.E.  
 PHONE: (336) 812-8800 ext.304  
 FAX: (336) 812-8780

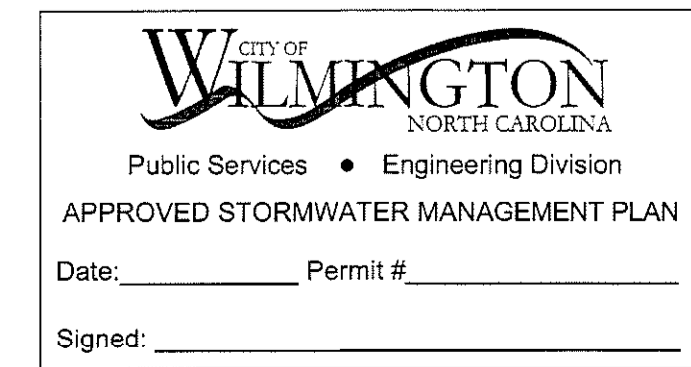

**Approved Construction Plan**

Name \_\_\_\_\_ Date \_\_\_\_\_


Planning \_\_\_\_\_

Traffic \_\_\_\_\_

Fire \_\_\_\_\_

Signed: \_\_\_\_\_

**CONSTRUCTION ACCESS NOTE:**  
 THE USE OF COVIL AVE FOR DRIVEWAY ACCESS TO THE SITE BY COMMERCIAL VEHICLES DURING CONSTRUCTION SHALL BE PROHIBITED.

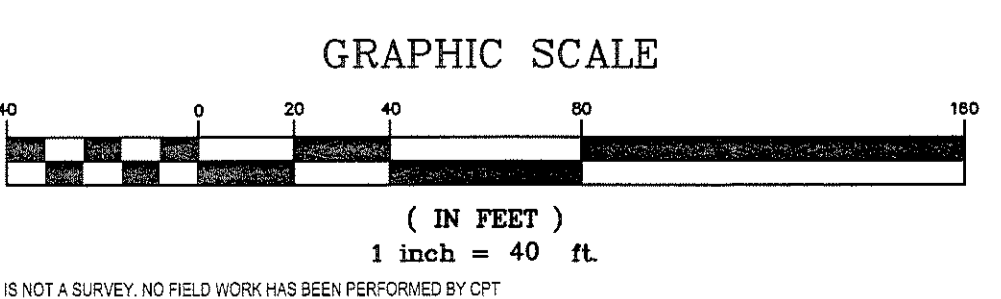

JUN 23, 2015 11:40 AM PROJECTS\1140-12 CIVIL BASEMAP.dwg Title Name: C6-UTILITY PLAN

THIS IS NOT A SURVEY. NO FIELD WORK HAS BEEN PERFORMED BY CPT ENGINEERING AND SURVEYING, INC.




DRAINAGE CALCULATIONS  
RATIONAL METHOD, Q = CIA (10 YEAR STORM)

PIPE #	AREA	TOTAL AREA	COEF.	RAINFALL	C X I	RUNOFF (CFS)	PIPE SIZE NEEDED	PIPE SIZE USED	PIPE SLOPE	PIPE LENGTH	NOTES
1	0.44	0.44	0.80	7.88	4.61	2.04	15"	15"	0.05	39'	RCP
2	0.43	0.87	0.45	7.88	3.45	61.08	42"	42"	0.80	33'	RCP
3	0.00	0.87	0.45	7.88	3.45	61.08	42"	42"	0.80	154'	RCP
4	3.74	3.74	0.80	7.88	4.61	17.24	24"	24"	2.00	25'	RCP

IMPERVIOUS SURFACE CALCULATIONS

	PARKING AREA #1	PARKING AREA #2	PARKING AREA #3	IMPERVIOUS TOTALS
BUILDINGS	0.193 AC / 8,403 SF	0.97 AC / 42,116 SF	0.177 AC / 7,711 SF	1.34 AC / 58,230 SF
PERVIOUS CONCRETE	0.035 AC / 1,522 SF	0.234 AC / 10,189 SF	0.041 AC / 1,792 SF	0.31 AC / 13,503 SF
CURB & GUTTER	0.014 AC / 610 SF	0.137 AC / 6,014 SF	0.014 AC / 605 SF	0.165 AC / 7,195 SF
REGULAR CONCRETE	0.144 AC / 6,294 SF	0.144 AC / 6,380 SF	0.152 AC / 6,809 SF	0.44 AC / 19,483 SF
TOTAL BUA	0.386 AC / 16,829 SF	1.338 AC / 58,230 SF	0.384 AC / 16,717 SF	2.108 AC / 89,776 SF
DRAINAGE AREA	0.443 AC	3.740 AC	0.495 AC	4.68 AC


\* TOTAL DRAINAGE AREA: 4.68 ACRES

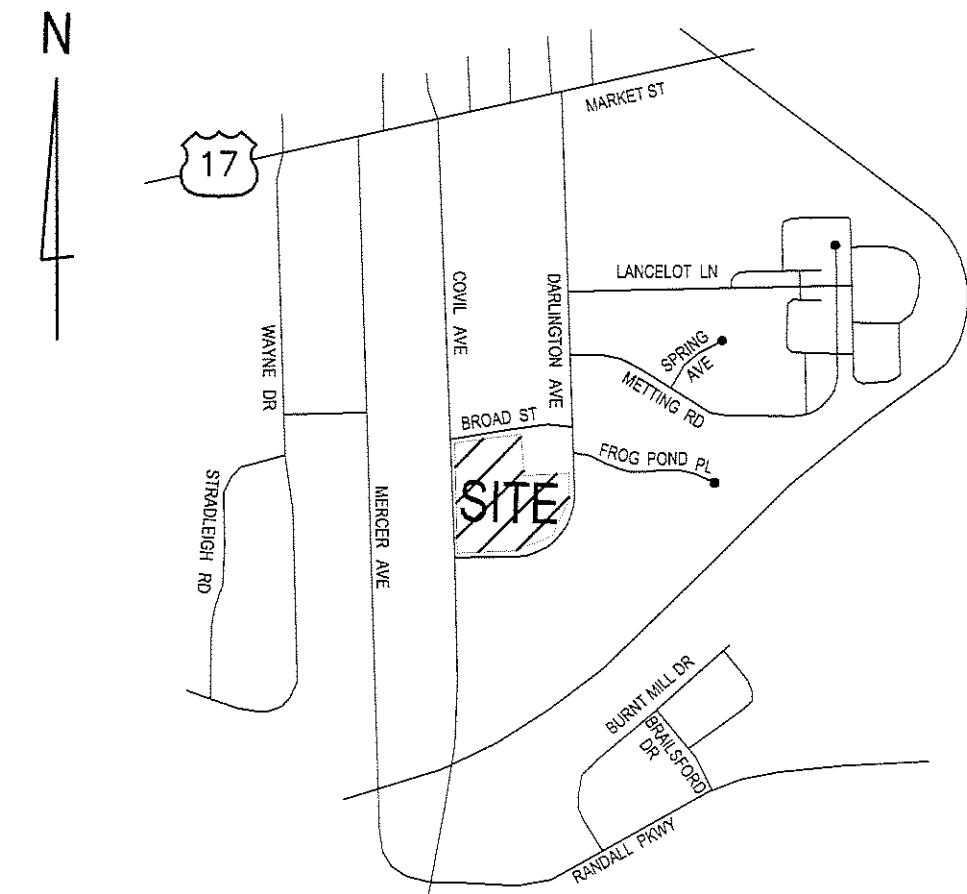

REVISIONS


NO.	DATE	DESCRIPTION
1	REV PER CITY COMMENTS	02-18-2015

ENGINEERING AND SURVEYING, INC.  
LAND DEVELOPMENT CONSULTING  
CORPORATE LICENSE NUMBER C-1875  
4400 TYNING STREET  
HIGH POINT, NORTH CAROLINA 27265  
PHONE: (336) 812-8800 FAX: (336) 812-8780

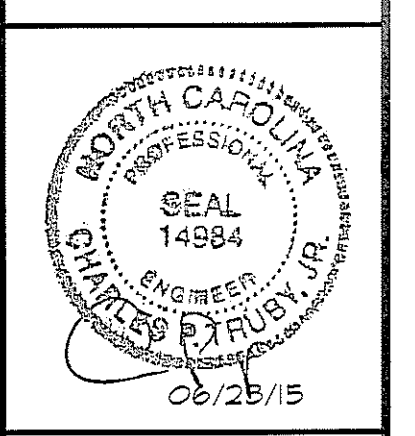

GRADING PLAN  
ANNEXE AT THE RESERVE  
CITY OF WILMINGTON ~ WILMINGTON TOWNSHIP  
NEW HANOVER COUNTY, NORTH CAROLINA

315 & 323 COVIL AVE.  
GRADING PLAN  
SCALE: 1" = 40'  
DATE: 03/17/15  
PROJECT: 1140-12  
DRAWN BY: TGL  
SHEET C-7

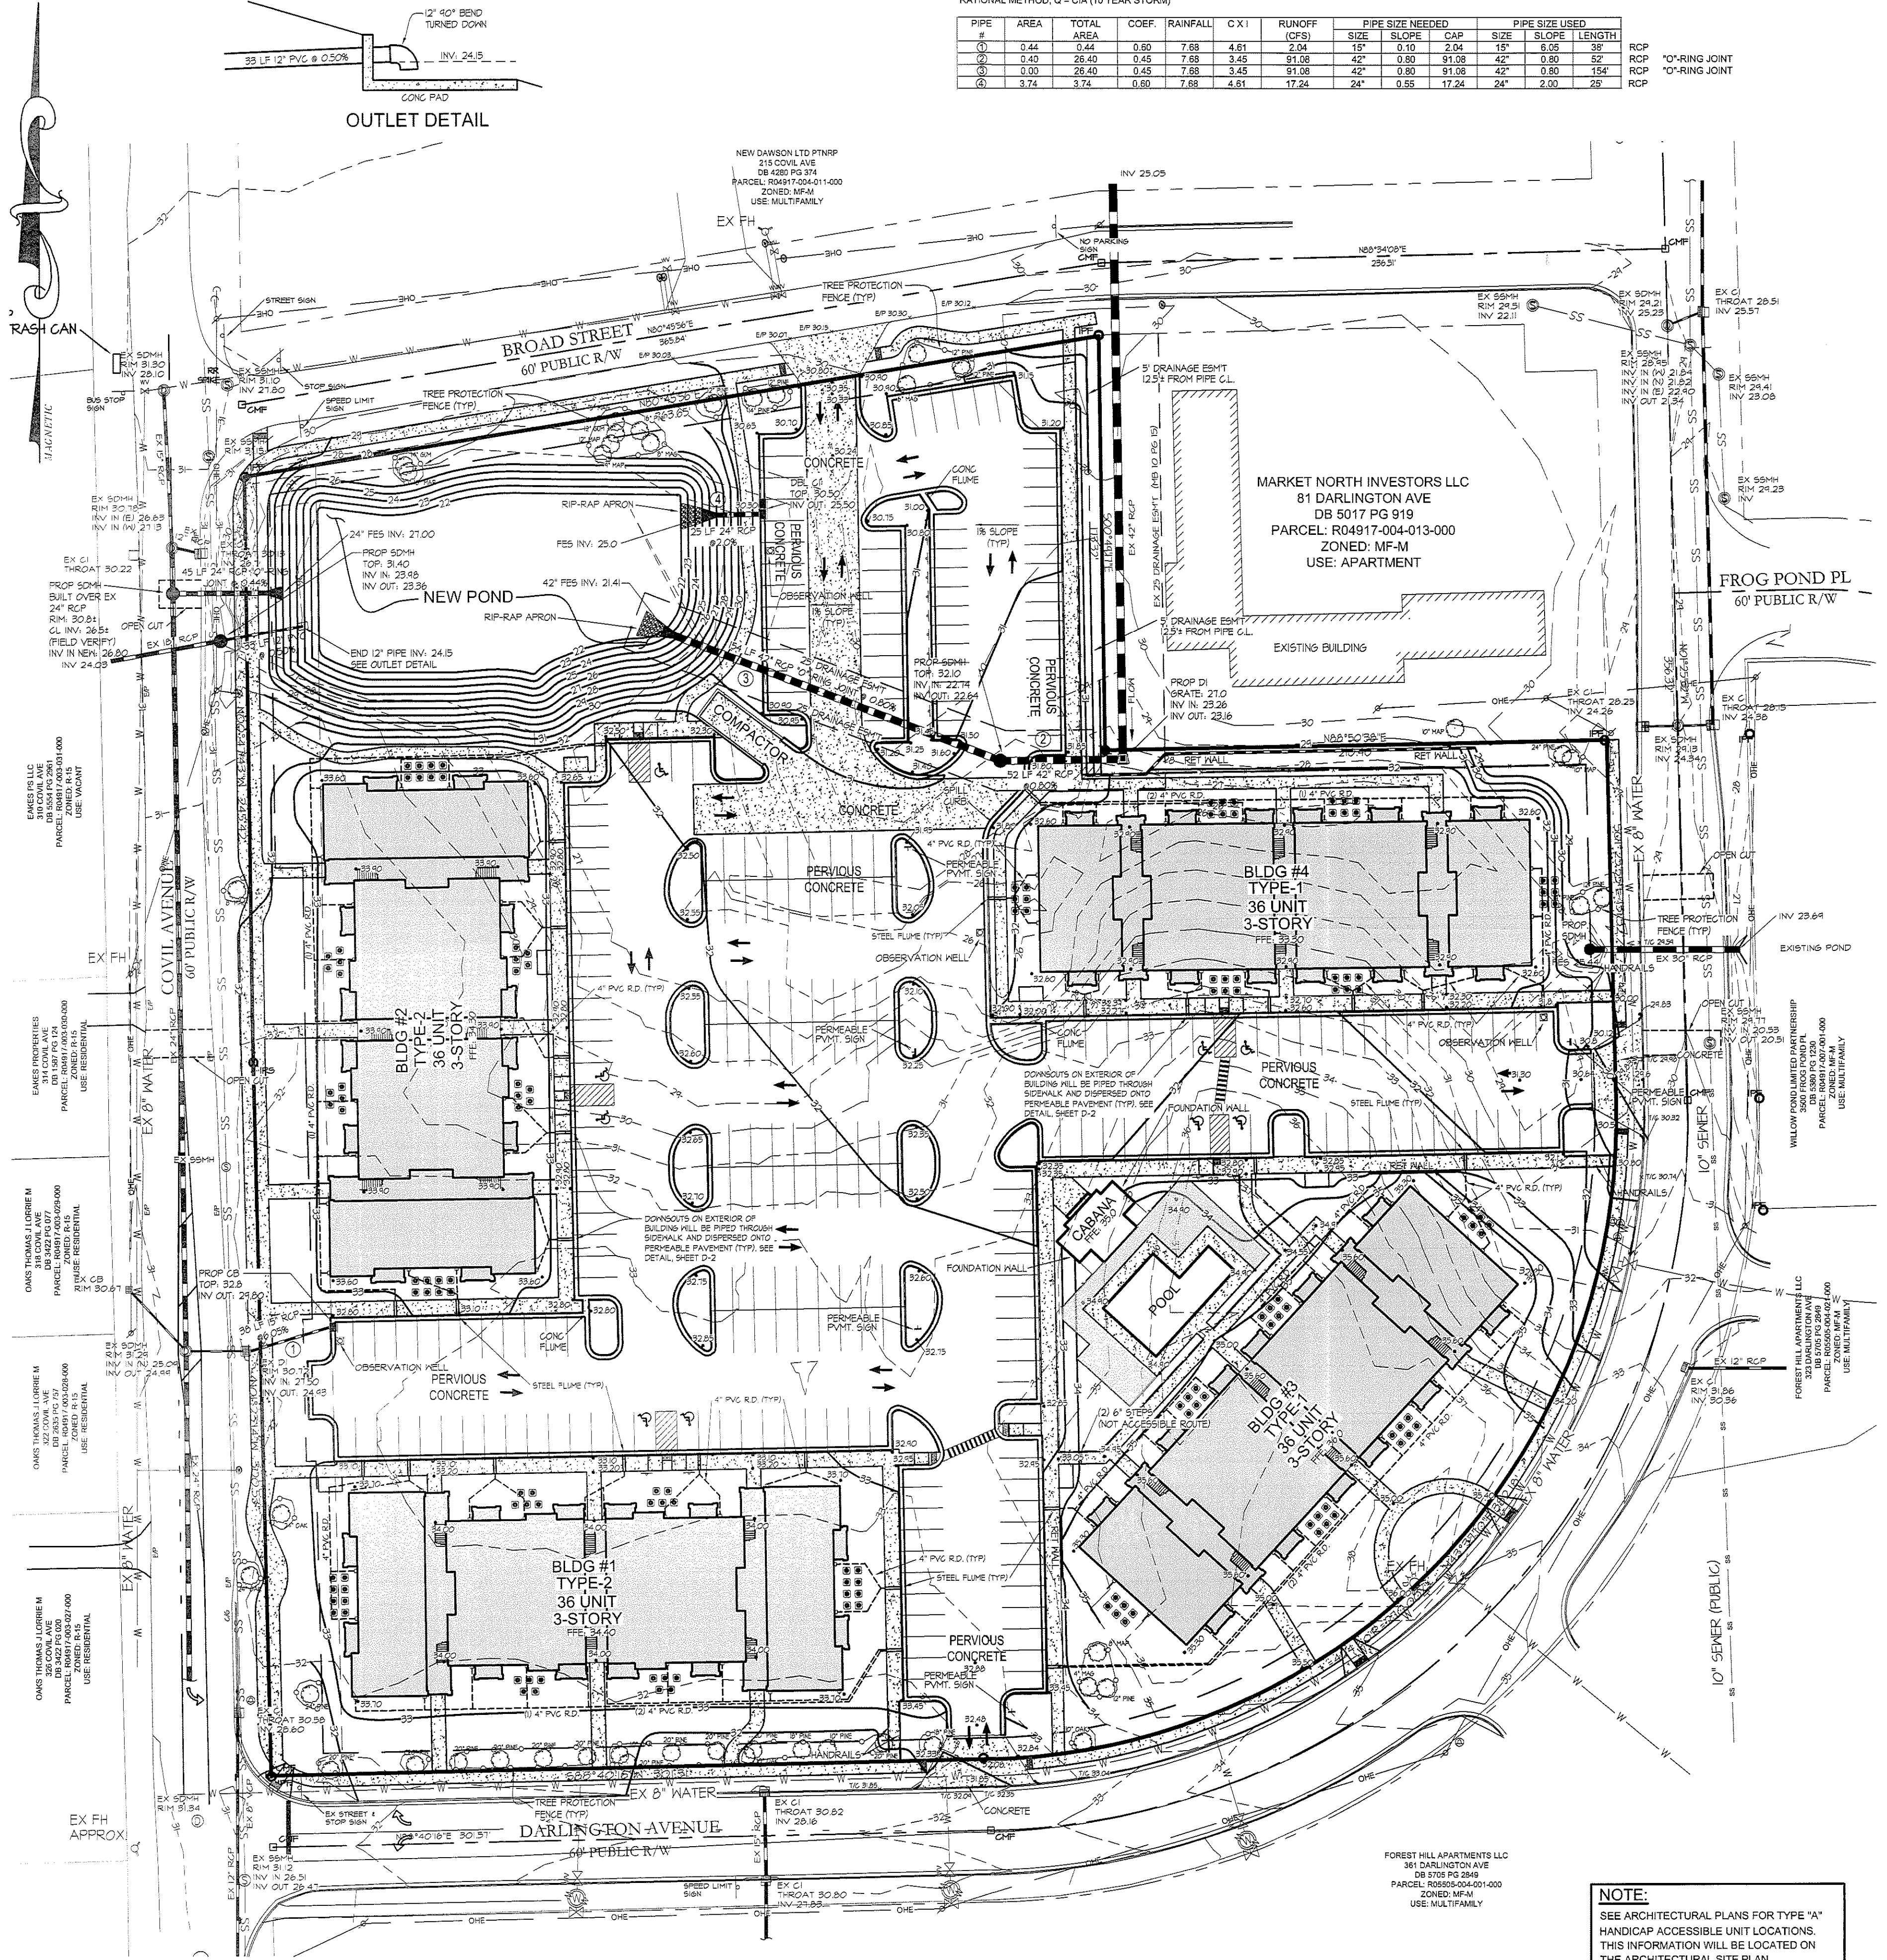

**TREE LEGEND:**  
MAP = MAPLE  
MAG = MAGNOLIA  
HW = HARDWOOD  
DBL = DOUBLE

**SITE INFORMATION:**  
SITE ACREAGE: 6.42 AC.  
EXISTING ZONING: MF-MH (CD)  
SITE ADDRESS: 315 & 323 COVIL AVE.  
PARCEL ID: R05505-004-015-000 & R04917-004-012-000

DEED REFERENCE: DEED BOOK 5673, PAGE 2248  
TOTAL NUMBER OF BUILDINGS: 4 (3 STORY)  
TOTAL NUMBER OF UNITS: 144  
USE: APARTMENTS

UNIT MIX:  
48 (1 BEDROOM)  
72 (2 BEDROOM)  
24 (3 BEDROOM)

MAXIMUM DENSITY ALLOWED PER ZONING: 25 UNITS / AC  
DENSITY SHOWN: 22.5 UNITS / AC  
BUILDING HEIGHT: 45 FT

**PARKING CALCULATION:**  
PARKING REQUIRED:  
48 (1 BEDROOM) X 1.5 = 72  
72 (2 BEDROOM) X 2.0 = 144  
24 (3 BEDROOM) X 2.25 = 54  
TOTAL REQUIRED = 270

**ADA PARKING:**  
ADA PARKING REQUIRED:  
201 - 300 = 7 SPACES  
(1 REQUIRED TO BE VAN SPACE)  
TOTAL ADA SPACES PROVIDED: 9 SPACES

TOTAL PARKING SPACES PROVIDED = 274  
(INCLUDES 9 HC SPACES)

**BUILDING SETBACKS (MF-MH):**  
FRONT: 30 FT  
REAR: 25 FT  
INTERIOR SIDE: 20 FT

**ADDITIONAL REAR AND SIDE YARD SETBACKS FOR BLDG HEIGHT ABOVE 35 FEET**  
FIRST 10 FEET ABOVE 35 FEET: 4 FEET FOR EACH 10 FOOT INCREMENT, OR PORTION THEREOF  
10.1 FEET TO 30 FEET ABOVE 35 FEET: 6 FEET FOR EACH 10 FOOT INCREMENT  
30.1 FEET OR MORE ABOVE 35 FEET: 8 FEET FOR EACH 10 FOOT INCREMENT


**OPEN SPACE:**  
TOTAL OPEN SPACE REQUIRED: 6.4 X 0.35 = 2.24 AC  
REQUIRED ACTIVE OR PASSIVE: 2.24 X 0.5 = 1.12 AC  
REQUIRED ACTIVE, PASSIVE, OR OPEN SPACE: 2.24 X 0.5 = 1.12 AC

PROVIDED (ACTIVE): 1.58 AC  
PROVIDED (OPEN SPACE): 0.44 AC  
TOTAL PROVIDED: 2.02 AC  
(THIS SITE IS 9,583 SF UNDER THE REQUIRED OPEN SPACE. FEE IN LIEU OF WILL BE REQUIRED)

**BUILT-UPON CALCULATION:**  
EXISTING BUA: 14,039 SF (TO BE REMOVED)  
PROPOSED:  
BUILDINGS: 58,230 SF (20.9% LOT COVERAGE)  
PARKING LOT AND DRIVES: 81,283 SF (PERVIOUS CONCRETE)  
SIDEWALKS & POOL: 38,339 SF  
TOTAL: 177,852 SF OR 4.08 AC  
(INCLUDES PERVIOUS CONCRETE)

WITH PERVIOUS CONCRETE CREDIT:  
58,230 + 81,283 (0.25) + 38,339 SF = 116,890 SF OR 2.68 AC  
BUILT UPON AREA % = 2.68 AC / 6.4 AC = 41.87%


ALL THE NECESSARY APPROVALS HAVE BEEN / WILL BE OBTAINED FROM THE STATE/ CORPS FOR ANY WETLAND DISTURBANCE AND STREAM CROSSING/DISTURBANCE

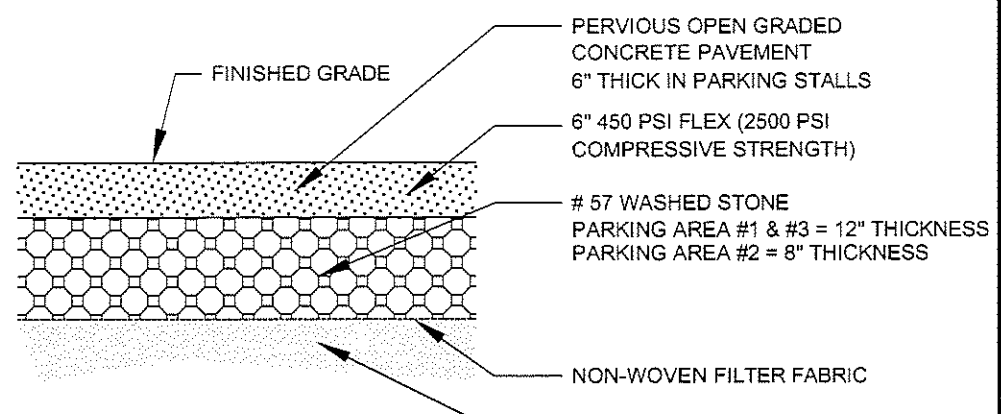

**TREE PROTECTION NOTE:**  
TREE PROTECTION FENCING SHALL BE INSTALLED ALONG ALL PROTECTED TREES WITH SIGNAGE OF NO MATERIAL STORAGE IN ENGLISH AND SPANISH THROUGHOUT CONSTRUCTION.  
SEE SHEET C-10 FOR TREE PROTECTIONS DETAILS

**OWNER / DEVELOPER:**  
BRC WILMINGTON LLC  
5926 SAMET DRIVE, SUITE 105  
HIGH POINT, NC 27285  
PHONE: (336) 888-1512  
FAX: (336) 888-1501

**ENGINEER:**  
CPT ENGINEERING & SURVEYING, INC.  
4400 TYNING STREET  
HIGH POINT, NC 27285  
CONTACT: CHUCK TRUBY, P.E.  
PHONE: (336) 812-8800 ext.304  
FAX: (336) 812-8780

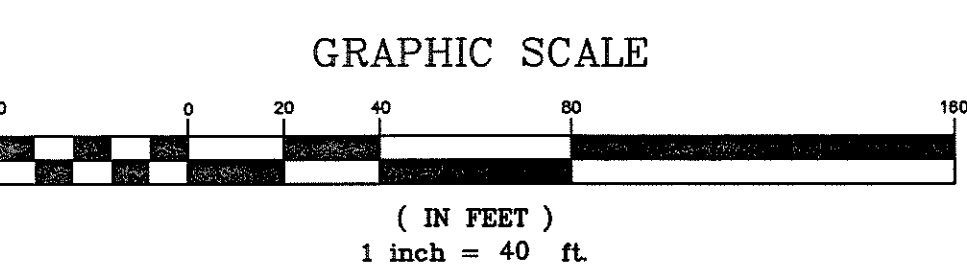

**ACCESSIBLE ROUTE NOTE:**  
ALL SIDEWALKS WITHIN THIS DEVELOPMENT ARE ACCESSIBLE ROUTES UNLESS OTHERWISE NOTED ON PLAN.

**CONSTRUCTION ACCESS NOTE:**  
THE USE OF COVIL AVE FOR DRIVEWAY ACCESS TO THE SITE BY COMMERCIAL VEHICLES DURING CONSTRUCTION SHALL BE PROHIBITED.

**NOTE:**  
SEE ARCHITECTURAL PLANS FOR TYPE "A" HANDICAP ACCESSIBLE UNIT LOCATIONS. THIS INFORMATION WILL BE LOCATED ON THE ARCHITECTURAL SITE PLAN.

City of WILMINGTON, NORTH CAROLINA  
Public Services • Engineering Division  
APPROVED STORMWATER MANAGEMENT PLAN  
Date: \_\_\_\_\_ Permit # \_\_\_\_\_  
Signed: \_\_\_\_\_

Approved Construction Plan  
Name: \_\_\_\_\_ Date: \_\_\_\_\_  
Planning: \_\_\_\_\_  
Traffic: \_\_\_\_\_  
Fire: \_\_\_\_\_




**DRAINAGE CALCULATIONS**  
RATIONAL METHOD, Q = CIA (10 YEAR STORM)

PIPE #	AREA	TOTAL AREA	COEF.	RAINFALL	C X I	RUNOFF (CFS)	PIPE SIZE NEEDED			PIPE SIZE USED		
							SIZE	SLOPE	CAP	SIZE	SLOPE	LENGTH
①	0.44	0.44	0.60	7.68	4.81	2.04	15"	0.10	2.04	15"	6.05	38'
②	0.40	28.40	0.45	7.68	3.45	91.08	42"	0.80	91.08	42"	0.80	52'
③	0.50	28.40	0.45	7.68	3.45	91.08	42"	0.80	91.08	42"	0.80	154'
④	3.74	3.74	0.60	7.68	4.81	17.24	24"	0.55	17.24	24"	2.00	29'

**IMPERVIOUS SURFACE CALCULATIONS**


	PARKING AREA #1	PARKING AREA #2	PARKING AREA #3	IMPERVIOUS TOTALS
	ACRES / SQ FT	ACRES / SQ FT	ACRES / SQ FT	ACRES / SQ FT
BUILDINGS	0.196 AC / 8,403 SF	0.97 AC / 42,116 SF	0.177 AC / 7,711 SF	1.34 AC / 58,230 SF
SIDEWALK	0.035 AC / 1,522 SF	0.234 AC / 10,189 SF	0.041 AC / 1,792 SF	0.31 AC / 13,511 SF
CURB & GUTTER	0.014 AC / 610 SF	0.137 AC / 5,983 SF	0.014 AC / 610 SF	0.165 AC / 7,198 SF
PERVIOUS CONCRETE	0.144 AC / 6,284 SF	1.370 AC / 60,880 SF	0.152 AC / 6,808 SF	1.666 AC / 73,972 SF
REGULAR CONCRETE	0	0.217 AC / 9,472 SF	0	0.217 AC / 9,472 SF
TOTAL BUA	0.386 AC / 16,829 SF	3.126 AC / 136,149 SF	0.384 AC / 16,717 SF	3.90 AC / 169,695 SF
DRAINAGE AREA	0.443 AC, 3,740 AC, 0.495 AC			4.68 AC

\* TOTAL DRAINAGE AREA: 4.68 ACRES

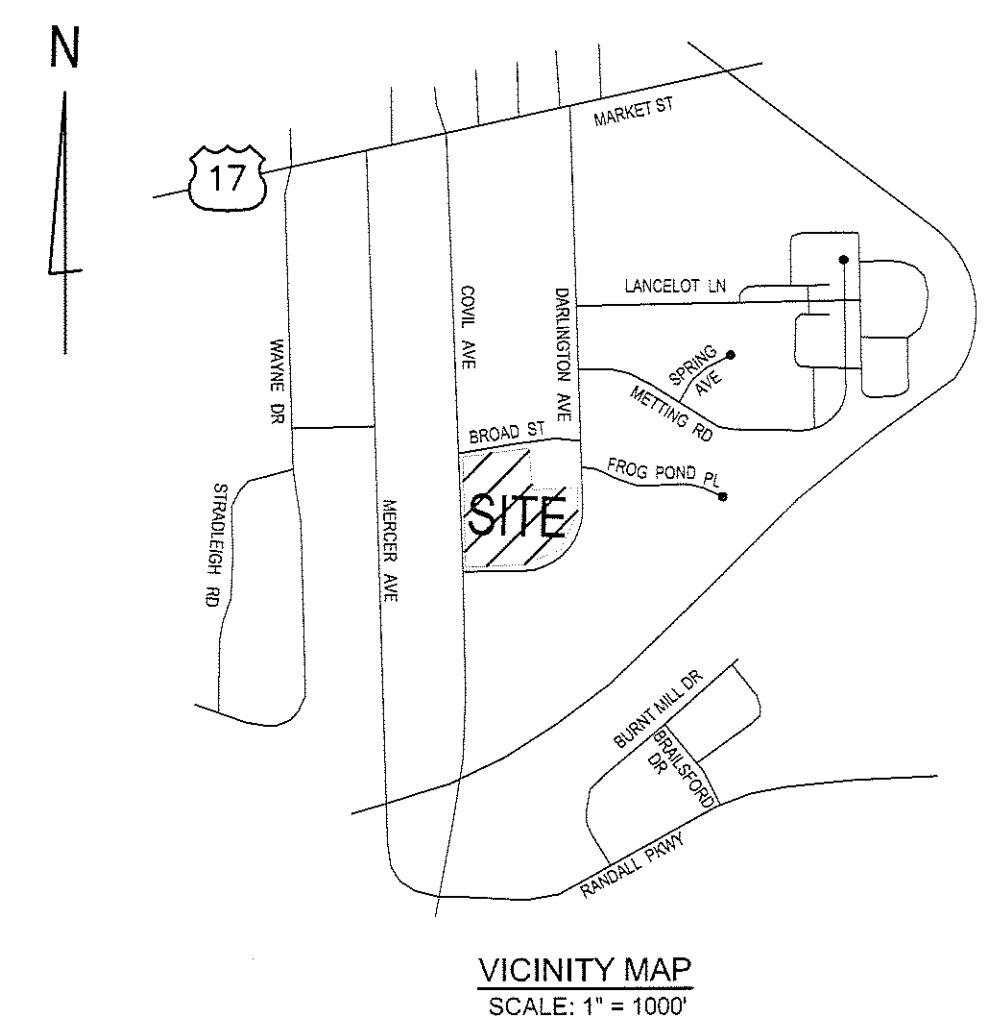

**REVISIONS**

REV. NO.	DATE	DESCRIPTION
1	02-16-2015	PER CITY COMMENTS

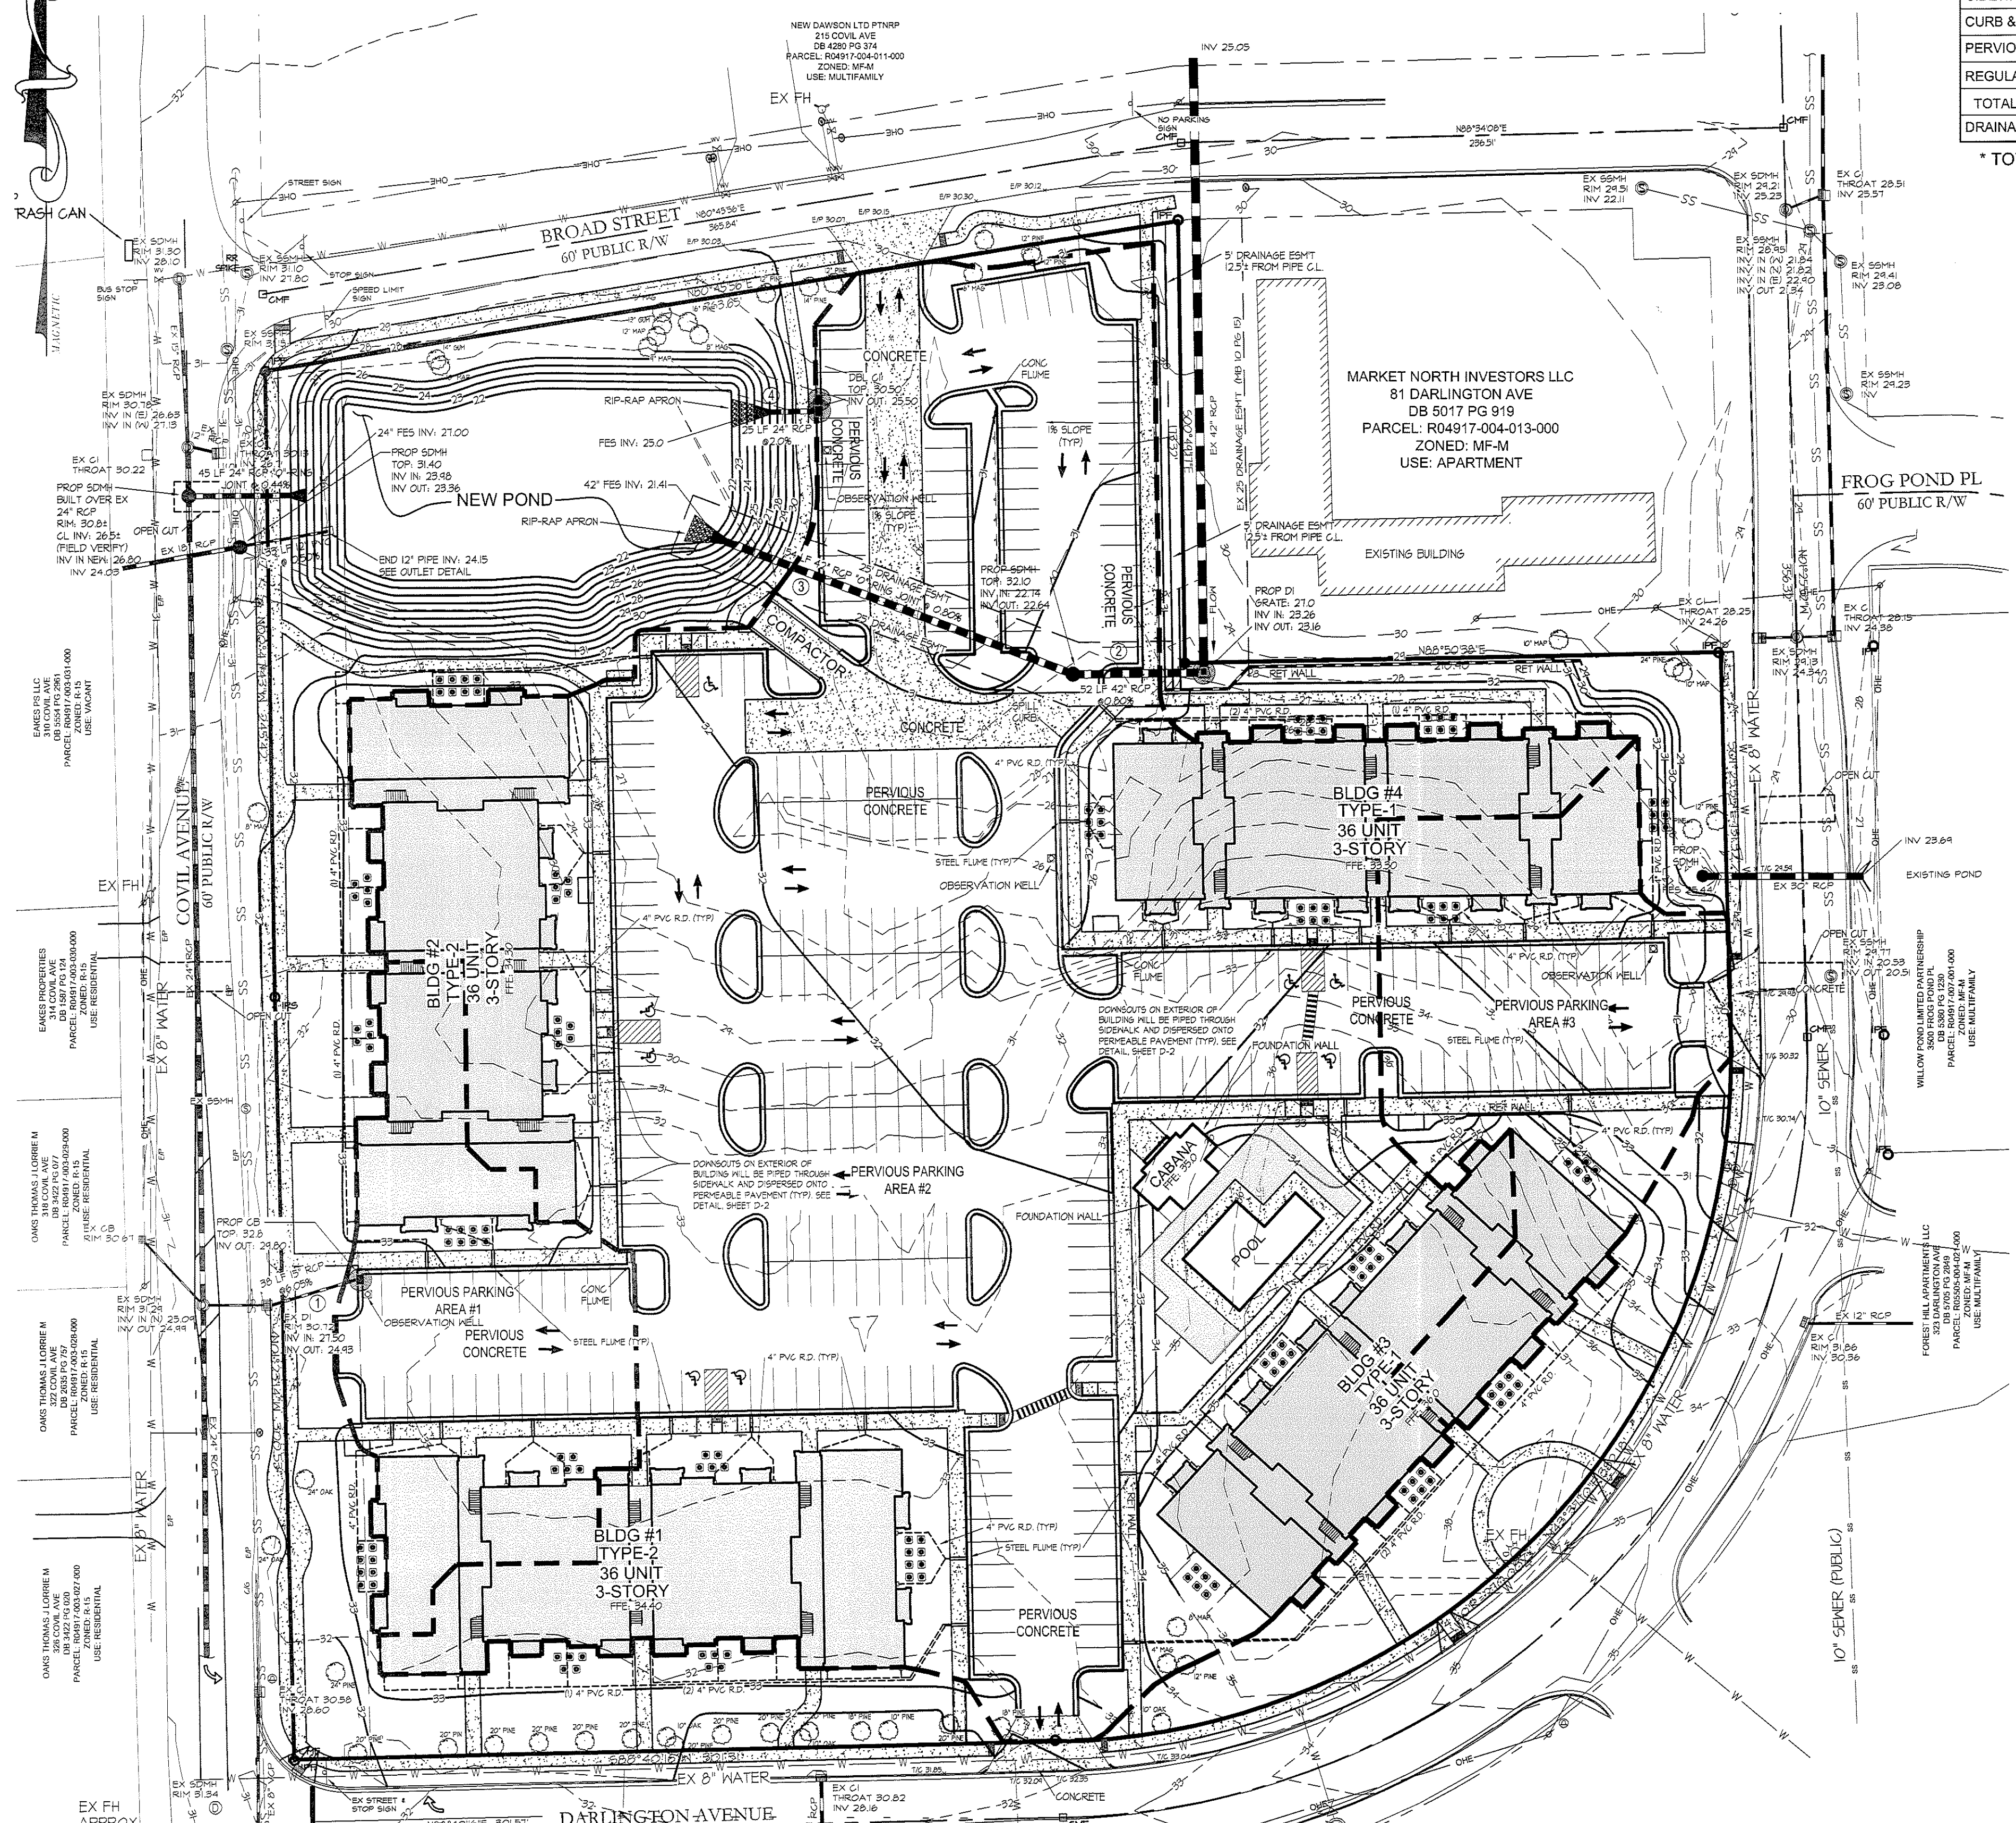

**TREE LEGEND:**  
MAP = MAPLE  
MAG = MAGNOLIA  
HW = HARDWOOD  
DBL = DOUBLE

**SITE INFORMATION:**  
SITE ACREAGE: 6.4± AC.  
EXISTING ZONING: MF-MH (CD)  
SITE ADDRESS: 315 & 323 COVIL AVE.  
PARCEL ID: R05505-004-015-000 & R04917-004-012-000  
DEED REFERENCE: DEED BOOK 5673, PAGE 2248  
TOTAL NUMBER OF BUILDINGS: 4 (3 STORY)  
TOTAL NUMBER OF UNITS: 144  
USE: APARTMENTS  
UNIT MIX:  
48 (1 BEDROOM)  
72 (2 BEDROOM)  
24 (3 BEDROOM)  
MAXIMUM DENSITY ALLOWED PER ZONING: 25 UNITS / AC  
DENSITY SHOWN: 22.5 UNITS / AC  
BUILDING HEIGHT: 45 FT

**PARKING CALCULATION:**  
PARKING REQUIRED:  
48 (1 BEDROOM) X 1.5 = 72  
72 (2 BEDROOM) X 2.0 = 144  
24 (3 BEDROOM) X 2.25 = 54  
TOTAL REQUIRED = 270  
TOTAL PARKING SPACES PROVIDED = 274 (INCLUDES 9 HC SPACES)

**ADA PARKING:**  
ADA PARKING REQUIRED:  
201 - 300 = 7 SPACES  
(1 REQUIRED TO BE VAN SPACE)  
TOTAL ADA SPACES PROVIDED: 9 SPACES

**BUILDING SETBACKS (MF-MH):**  
FRONT: 30 FT  
REAR: 25 FT  
INTERIOR SIDE: 20 FT  
ADDITIONAL REAR AND SIDE YARD SETBACKS FOR BLDG HEIGHT ABOVE 35 FEET  
FIRST 10 FEET ABOVE 35 FEET: 4 FEET FOR EACH 10 FOOT INCREMENT, OR PORTION THEREOF  
10.1 FEET TO 30 FEET ABOVE 35 FEET: 6 FEET FOR EACH 10 FOOT INCREMENT  
30.1 FEET OR MORE ABOVE 35 FEET: 8 FEET FOR EACH 10 FOOT INCREMENT

**OPEN SPACE:**  
TOTAL OPEN SPACE REQUIRED: 6.4 X 0.35 = 2.24 AC  
REQUIRED ACTIVE OR PASSIVE: 2.24 X 0.5 = 1.12 AC  
REQUIRED ACTIVE, PASSIVE, OR OPEN SPACE: 2.24 X 0.5 = 1.12 AC

PROVIDED (ACTIVE): 1.58 AC  
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(THIS SITE IS 9,583 SF UNDER THE REQUIRED OPEN SPACE, FEE IN LIEU OF WILL BE REQUIRED)


**BUILT-UPON CALCULATION:**  
EXISTING BUA: 14,039 SF (TO BE REMOVED)

PROPOSED:  
BUILDINGS: 58,230 SF (20.9% LOT COVERAGE)  
PARKING LOT AND DRIVES: 81,283 SF (PERVIOUS CONCRETE)  
SIDEWALKS & POOL: 38,339 SF  
TOTAL: 177,852 SF OR 4.08 AC (INCLUDES PERVIOUS CONCRETE)

WITH PERVIOUS CONCRETE CREDIT:  
58,230 + 81,283 (0.25) + 38,339 SF = 116,890 SF OR 2.68 AC  
BUILT UPON AREA % = 2.68 AC / 6.4 AC = 41.8%

ALL THE NECESSARY APPROVALS HAVE BEEN / WILL BE OBTAINED FROM THE STATE/ CORPS FOR ANY WETLAND DISTURBANCE AND STREAM CROSSING/DISTURBANCE

**NOTE:**  
SEE ARCHITECTURAL PLANS FOR TYPE "A" HANDICAP ACCESSIBLE UNIT LOCATIONS. THIS INFORMATION WILL BE LOCATED ON THE ARCHITECTURAL SITE PLAN.

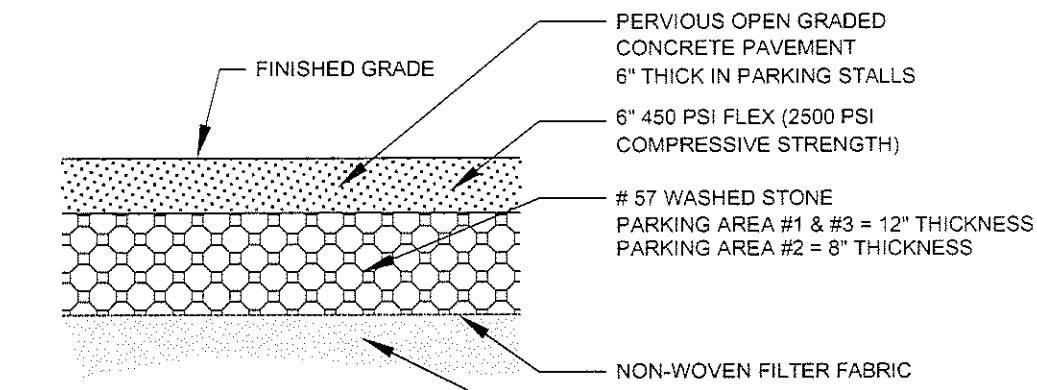


**TYPICAL CONCRETE PERVIOUS PAVEMENT SECTION FOR PASSENGER VEHICLE PARKING AREAS**

**OWNER / DEVELOPER:**  
BRC WILMINGTON LLC  
5826 SAMET DRIVE, SUITE 105  
HIGH POINT, NC 27285  
PHONE: (336) 889-1512  
FAX: (336) 889-1501

**ENGINEER:**  
CPT ENGINEERING & SURVEYING, INC.  
4400 TYNING STREET  
HIGH POINT, NC 27285  
CONTACT: CHUCK TRUBY, P.E.  
PHONE: (336) 812-8800 ext.304  
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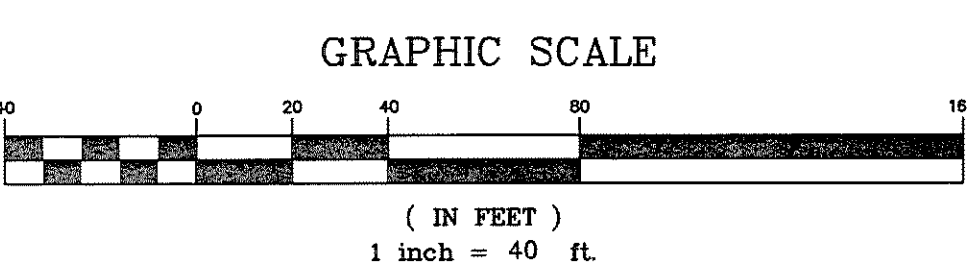
**ENGINEERING AND SURVEYING, INC.**  
LAND DEVELOPMENT CONSULTING  
CORPORATE LICENSE NUMBER C-1515  
4400 TYNING STREET  
HIGH POINT, NORTH CAROLINA 27285  
PHONE: (336) 812-8800 ~ FAX: (336) 812-8780

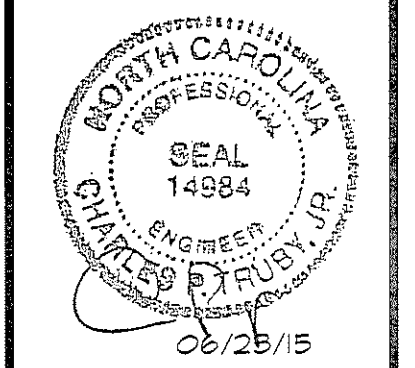

**DRAINAGE AREA PLAN**  
**ANNEXE AT THE RESERVE**  
CITY OF WILMINGTON ~ WILMINGTON TOWNSHIP  
NEW HANOVER COUNTY, NORTH CAROLINA

315 & 323 COVIL AVE.  
**DRAINAGE AREA PLAN**

SCALE: 1" = 40'  
DATE: 03/17/15  
PROJECT: 1140-12  
DRAWN BY: TGL  
SHEET C-8



**WILMINGTON**  
NORTH CAROLINA  
Public Services • Engineering Division  
APPROVED STORMWATER MANAGEMENT PLAN  
Date: \_\_\_\_\_ Permit # \_\_\_\_\_  
Signed: \_\_\_\_\_

**Approved Construction Plan**

Name: \_\_\_\_\_ Date: \_\_\_\_\_

Planning: \_\_\_\_\_

Traffic: \_\_\_\_\_

Fire: \_\_\_\_\_




**DRAINAGE CALCULATIONS**  
RATIONAL METHOD, Q = CIA (10 YEAR STORM)

PIPE #	AREA	TOTAL AREA	CDEF	RAINFALL	C X I	RUNOFF (CFS)	PIPE SIZE NEEDED	PIPE SIZE USED	PIPE SIZE LENGTH	RCP			
							SIZE	SLOPE	CAP	SIZE	SLOPE	LENGTH	
(1)	0.44	0.44	0.60	7.98	4.81	2.04	15"	0.10	2.04	15"	0.05	38'	RCP
(2)	0.40	26.40	0.45	7.68	3.45	81.08	42"	0.80	81.08	42"	0.80	62'	RCP
(3)	0.00	26.40	0.45	7.68	3.45	81.08	42"	0.80	81.08	42"	0.80	154'	RCP
(4)	3.74	3.74	0.60	7.68	4.81	17.24	24"	0.55	17.24	24"	2.00	25'	RCP

**IMPERVIOUS SURFACE CALCULATIONS**

	PARKING AREA #1	PARKING AREA #2	PARKING AREA #3	IMPERVIOUS TOTALS
	ACRES / SQ. FT.	ACRES / SQ. FT.	ACRES / SQ. FT.	ACRES / SQ. FT.
BUILDINGS	0.193 AC / 8,403 SF	0.97 AC / 42,118 SF	0.177 AC / 7,711 SF	1.34 AC / 58,230 SF
SIDEWALK	0.035 AC / 1,522 SF	0.234 AC / 10,189 SF	0.041 AC / 1,792 SF	0.31 AC / 13,512 SF
CURB & GUTTER	0.014 AC / 610 SF	0.137 AC / 5,983 SF	0.014 AC / 605 SF	0.165 AC / 7,198 SF
PERVIOUS CONCRETE	0.144 AC / 6,294 SF	1.570 AC / 68,380 SF	0.152 AC / 6,609 SF	1.866 AC / 81,283 SF
REGULAR CONCRETE	0	0.217 AC / 9,472 SF	0	0.217 AC / 9,472 SF
TOTAL BUA	0.386 AC / 16,829 SF	3.128 AC / 136,149 SF	0.384 AC / 16,717 SF	3.90 AC / 169,695 SF
DRAINAGE AREA	0.443 AC	3.740 AC	0.495 AC	4.68 AC


\* TOTAL DRAINAGE AREA: 4.68 ACRES

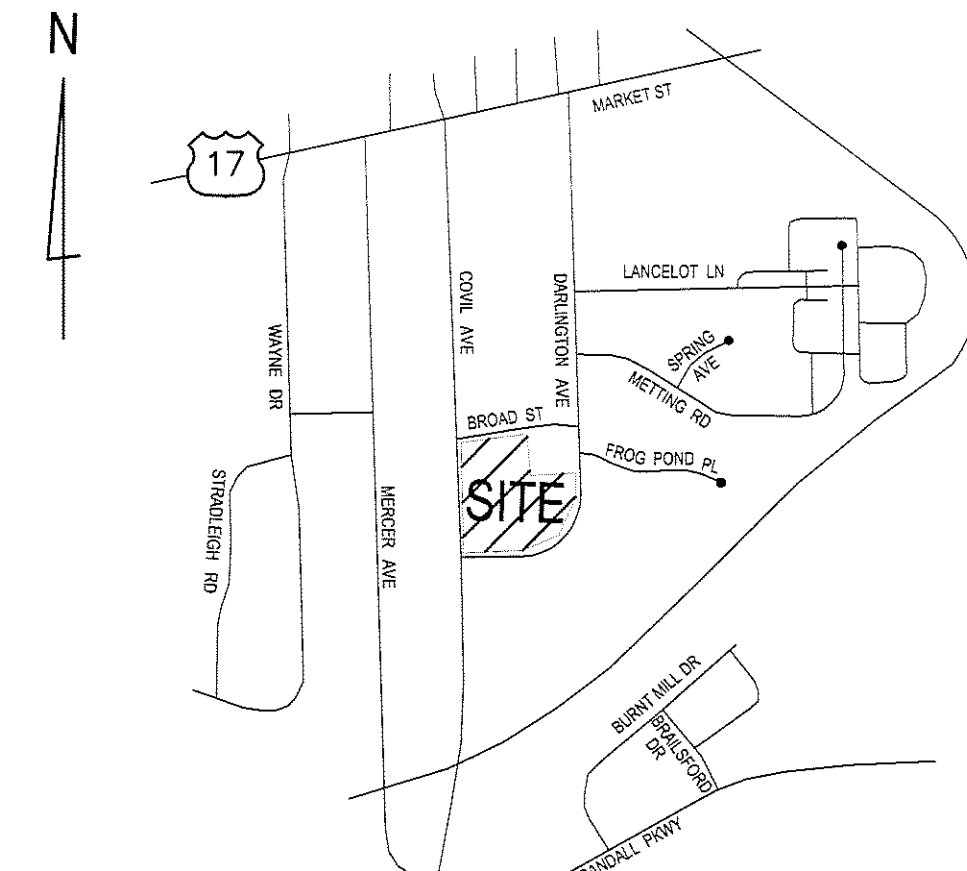

**REVISIONS**



REV	REV PER CITY COMMENTS
02-15-2015	

**ENGINEERING AND SURVEYING, INC.**  
LAND DEVELOPMENT CONSULTING  
CORPORATE LICENSE NUMBER C-1515  
4400 TYNING STREET  
HIGH POINT, NORTH CAROLINA 27265  
PHONE: (336) 812-8800 ~ FAX: (336) 812-6180

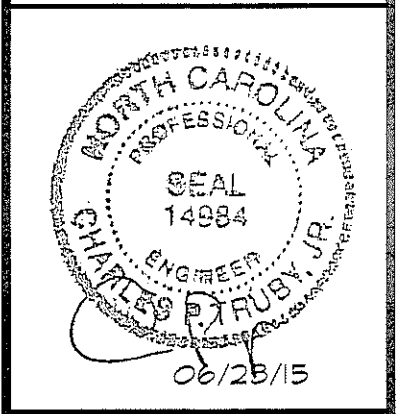

**STORMWATER MANAGEMENT PLAN**  
**ANNEXE AT THE RESERVE**  
CITY OF WILMINGTON ~ WILMINGTON TOWNSHIP  
NEW HANOVER COUNTY, NORTH CAROLINA

315 & 323 COVIL AVE.  
**STORMWATER MANAGEMENT PLAN**  
SCALE: 1" = 40'  
DATE: 03/17/15  
PROJECT: 1140-12  
DRAWN BY: TGL  
SHEET: C-9

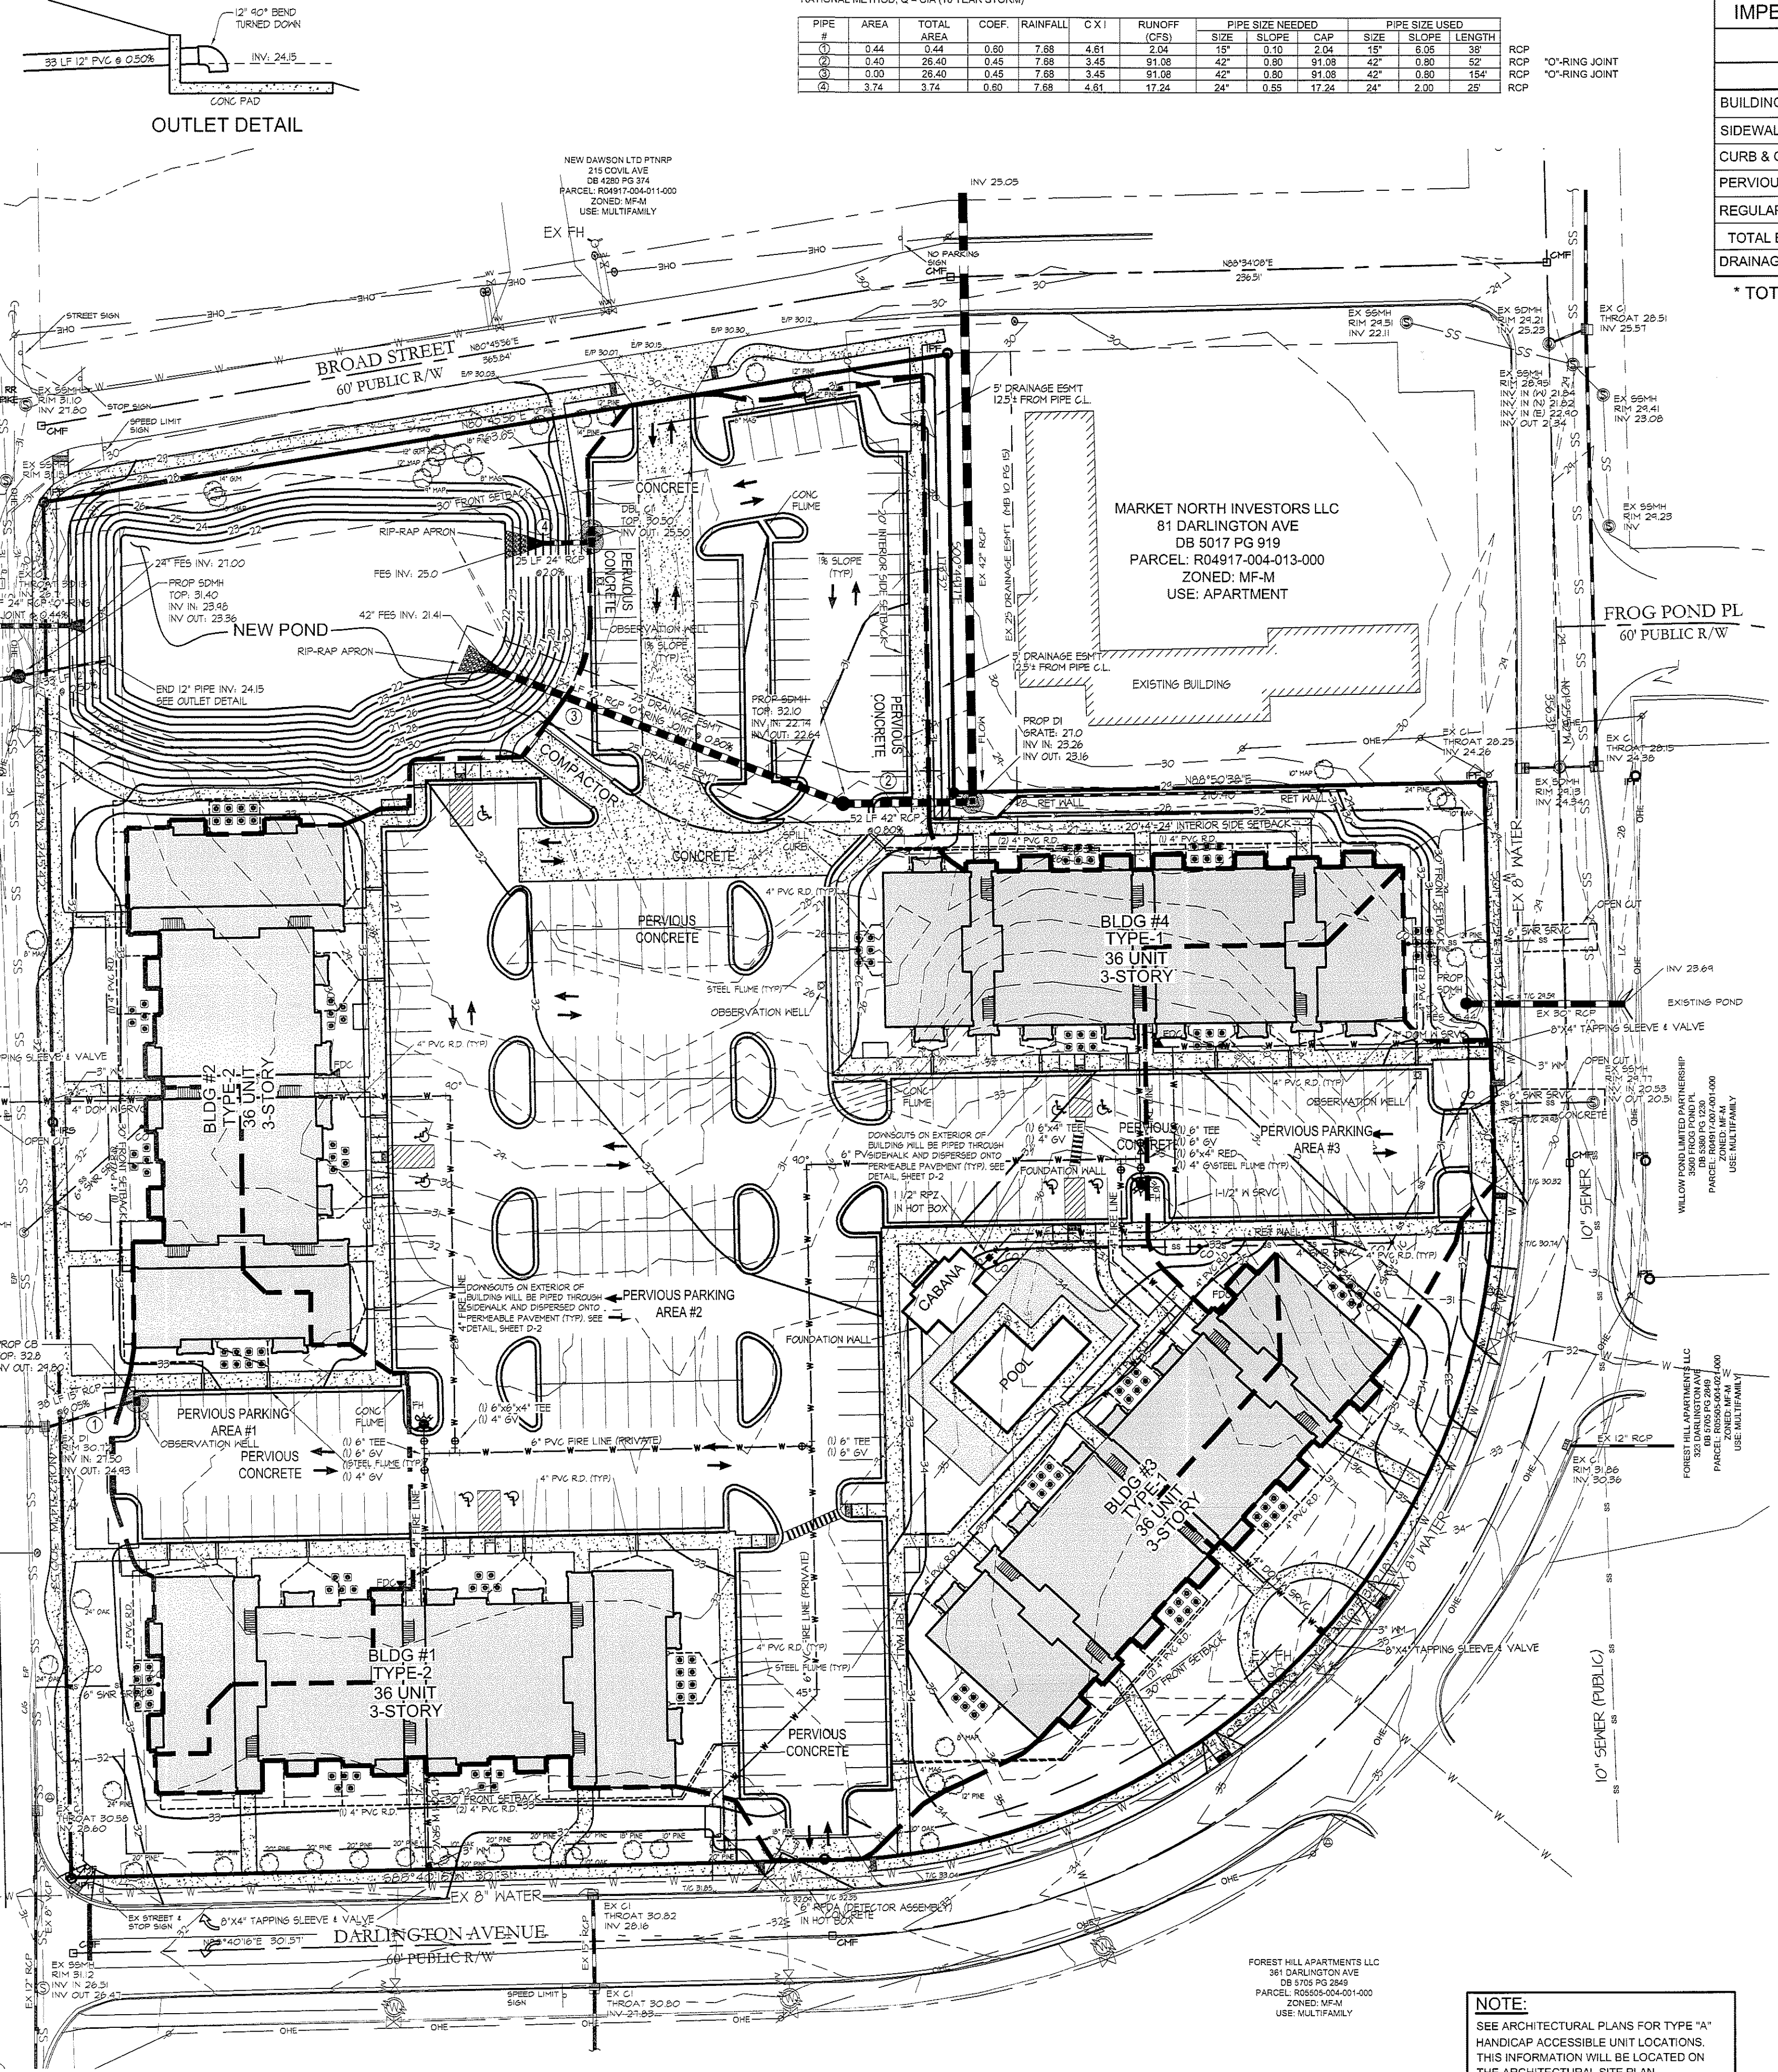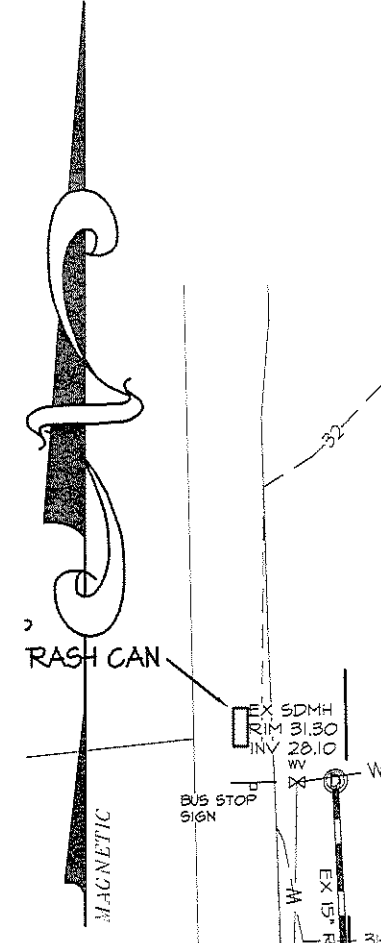

**TREE LEGEND:**  
MAP = MAPLE  
MAG = MAGNOLIA  
HW = HARDWOOD  
DBL = DOUBLE

**SITE INFORMATION:**  
SITE ACREAGE: 6.42 AC.  
EXISTING ZONING: MF-MH (CD)  
SITE ADDRESS: 315 & 323 COVIL AVE.  
PARCEL ID: R05505-004-015-000 & R04917-004-012-000  
DEED REFERENCE: DEED BOOK 5673, PAGE 2248  
TOTAL NUMBER OF BUILDINGS: 4 (3 STORY)  
TOTAL NUMBER OF UNITS: 144  
USE: APARTMENTS  
UNIT MIX:  
48 (1 BEDROOM)  
72 (2 BEDROOM)  
24 (3 BEDROOM)  
MAXIMUM DENSITY ALLOWED PER ZONING: 25 UNITS / AC  
DENSITY SHOWN: 22.5 UNITS / AC  
BUILDING HEIGHT: 45 FT

**PARKING CALCULATION:**  
PARKING REQUIRED:  
48 (1 BEDROOM) X 1.5 = 72  
72 (2 BEDROOM) X 2.0 = 144  
24 (3 BEDROOM) X 2.25 = 54  
TOTAL REQUIRED = 270  
TOTAL PARKING SPACES PROVIDED = 274 (INCLUDES 9 HC SPACES)

**ADA PARKING:**  
ADA PARKING REQUIRED:  
201 - 300 = 7 SPACES  
(1 REQUIRED TO BE VAN SPACE)  
TOTAL ADA SPACES PROVIDED: 9 SPACES

**BUILDING SETBACKS (MF-MH):**  
FRONT: 30 FT  
REAR: 25 FT  
INTERIOR SIDE: 20 FT  
ADDITIONAL REAR AND SIDE YARD SETBACKS FOR BLDG HEIGHT ABOVE 35 FEET:  
FIRST 10 FEET ABOVE 35 FEET: 4 FEET FOR EACH 10 FOOT INCREMENT, OR PORTION THEREOF  
10.1 FEET TO 30 FEET ABOVE 35 FEET: 6 FEET FOR EACH 10 FOOT INCREMENT  
30.1 FEET OR MORE ABOVE 35 FEET: 8 FEET FOR EACH 10 FOOT INCREMENT

**OPEN SPACE:**  
TOTAL OPEN SPACE REQUIRED: 6.4 X 0.35 = 2.24 AC  
REQUIRED ACTIVE OR PASSIVE: 2.24 X 0.5 = 1.12 AC  
REQUIRED ACTIVE, PASSIVE, OR OPEN SPACE: 2.24 X 0.5 = 1.12 AC  
PROVIDED (ACTIVE): 1.58 AC  
PROVIDED (OPEN SPACE): 0.44 AC  
TOTAL PROVIDED: 2.02 AC  
(THIS SITE IS 9,583 SF UNDER THE REQUIRED OPEN SPACE, FEE IN LIEU OF WILL BE REQUIRED)

**BUILT-UPON CALCULATION:**  
EXISTING BUA: 14,039 SF (TO BE REMOVED)  
PROPOSED:  
BUILDINGS: 58,230 SF (20.9% LOT COVERAGE)  
PARKING LOT AND DRIVES: 81,283 SF (PERVIOUS CONCRETE)  
SIDEWALKS & POOL: 38,339 SF  
TOTAL: 177,852 SF OR 4.08 AC  
(INCLUDES PERVIOUS CONCRETE)  
WITH PERVIOUS CONCRETE CREDIT:  
58,230 + 81,283 (0.25) + 38,339 SF = 116,890 SF OR 2.68 AC  
BUILT UPON AREA % = 2.68 AC / 6.4 AC = 41.87%


ALL THE NECESSARY APPROVALS HAVE BEEN/ WILL BE OBTAINED FROM THE STATE/ CORPS FOR ANY WETLAND DISTURBANCE AND STREAM CROSSING/DISTURBANCE

**NOTE:**  
SEE ARCHITECTURAL PLANS FOR TYPE "A" HANDICAP ACCESSIBLE UNIT LOCATIONS. THIS INFORMATION WILL BE LOCATED ON THE ARCHITECTURAL SITE PLAN.

**CITY OF WILMINGTON**  
Public Services • Engineering Division  
APPROVED STORMWATER MANAGEMENT PLAN  
Date: \_\_\_\_\_ Permit # \_\_\_\_\_  
Signed: \_\_\_\_\_

**Approved Construction Plan**  
Name \_\_\_\_\_ Date \_\_\_\_\_  
Planning \_\_\_\_\_  
Traffic \_\_\_\_\_  
Fire \_\_\_\_\_






**OWNER / DEVELOPER:**  
BRC WILMINGTON LLC  
5826 SAMET DRIVE, SUITE 105  
HIGH POINT, NC 27265  
PHONE: (336) 889-1512  
FAX: (336) 889-1501  
**ENGINEER:**  
CPT ENGINEERING & SURVEYING, INC.  
4400 TYNING STREET  
HIGH POINT, NC 27265  
CONTACT: CHUCK TRUHY, P.E.  
PHONE: (336) 812-8800 ext.304  
FAX: (336) 812-8780

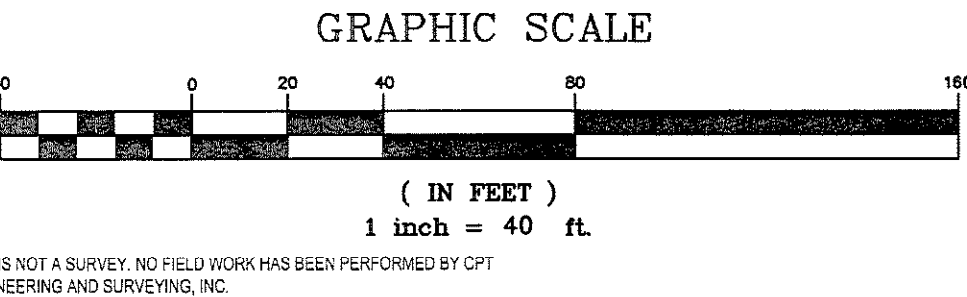

Jan 23, 2015 F:\Projects\1140-12\DWG\1140-12 CIVIL BASEMAP.dwg Tab Name: C5-510RHWATER MAN PLAN

THIS IS NOT A SURVEY. NO FIELD WORK HAS BEEN PERFORMED BY CPT ENGINEERING AND SURVEYING, INC.



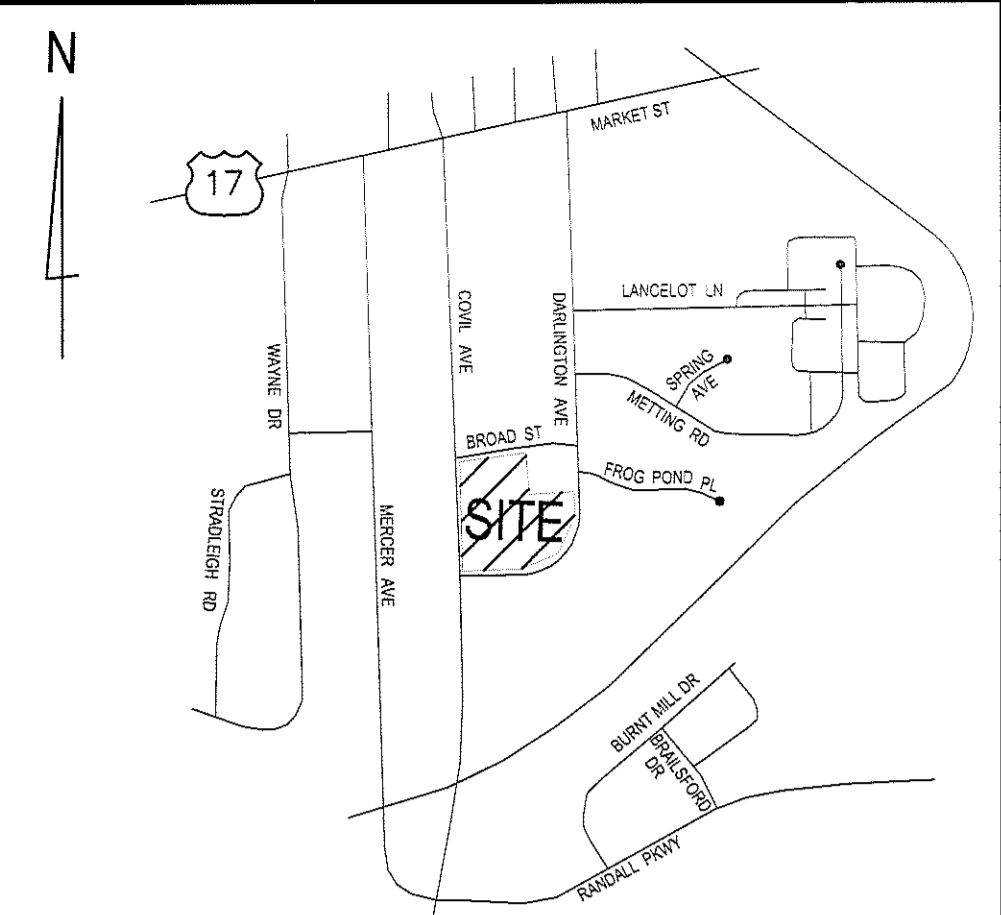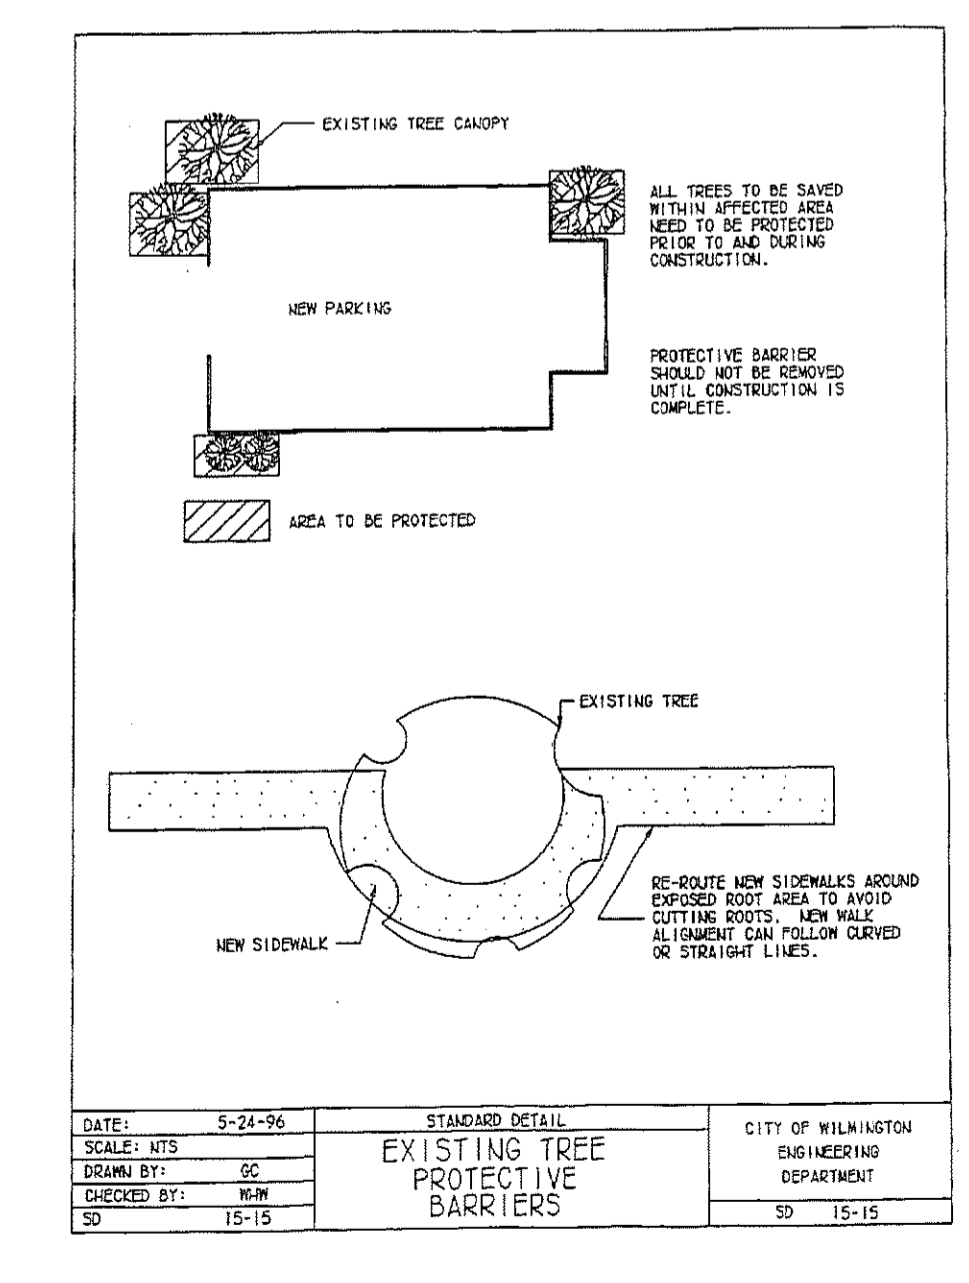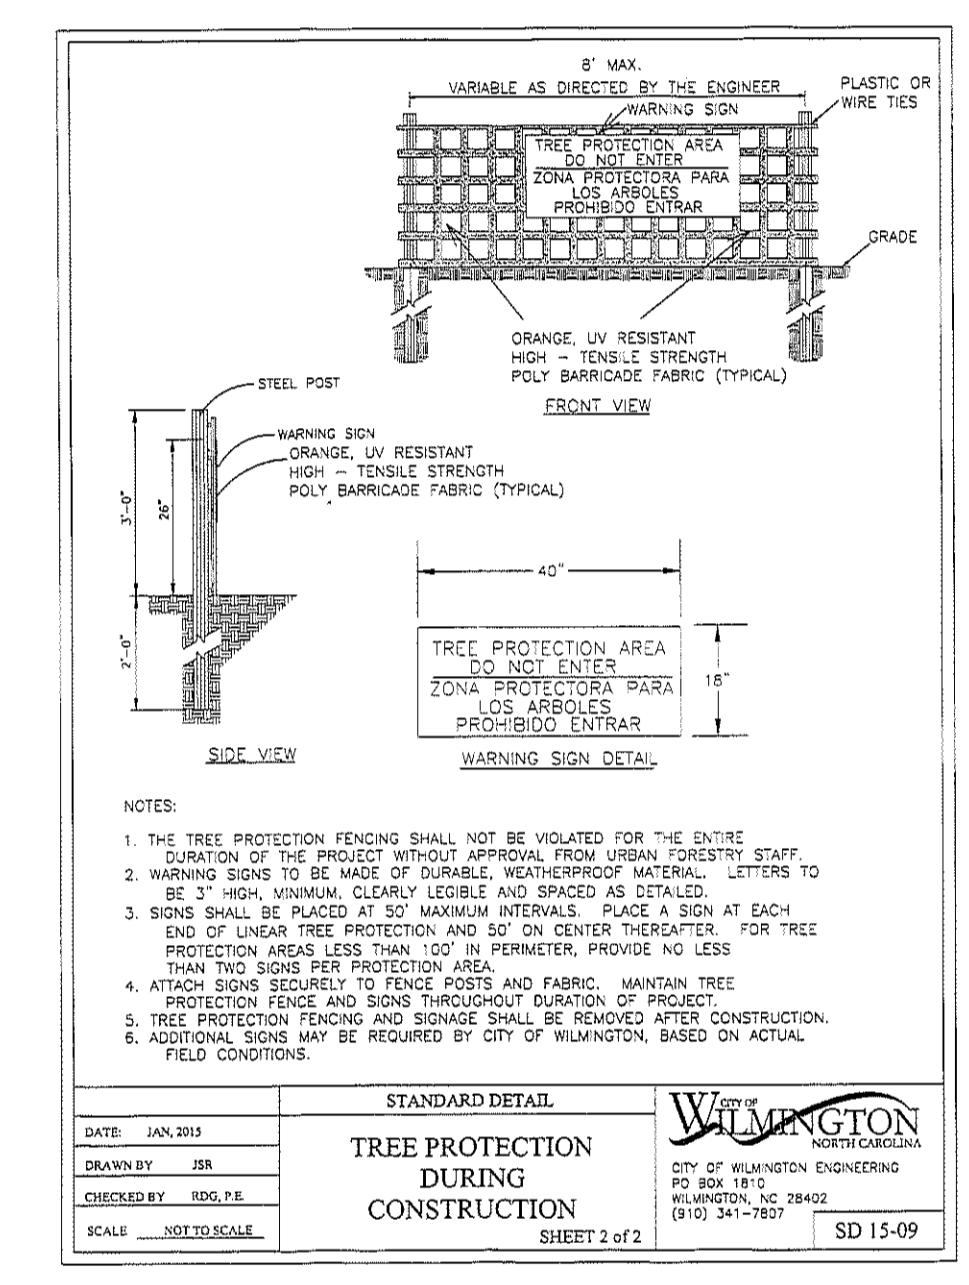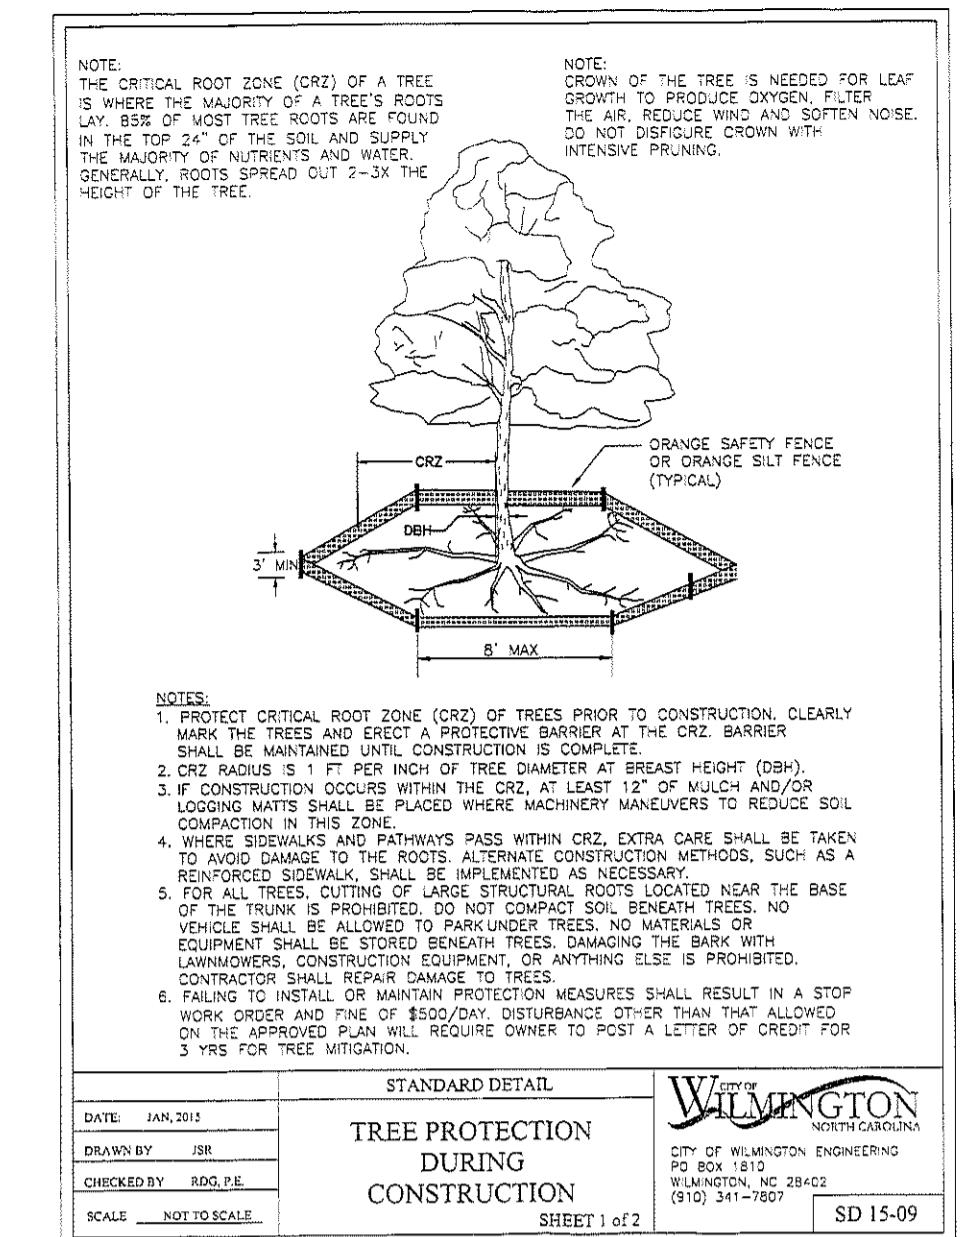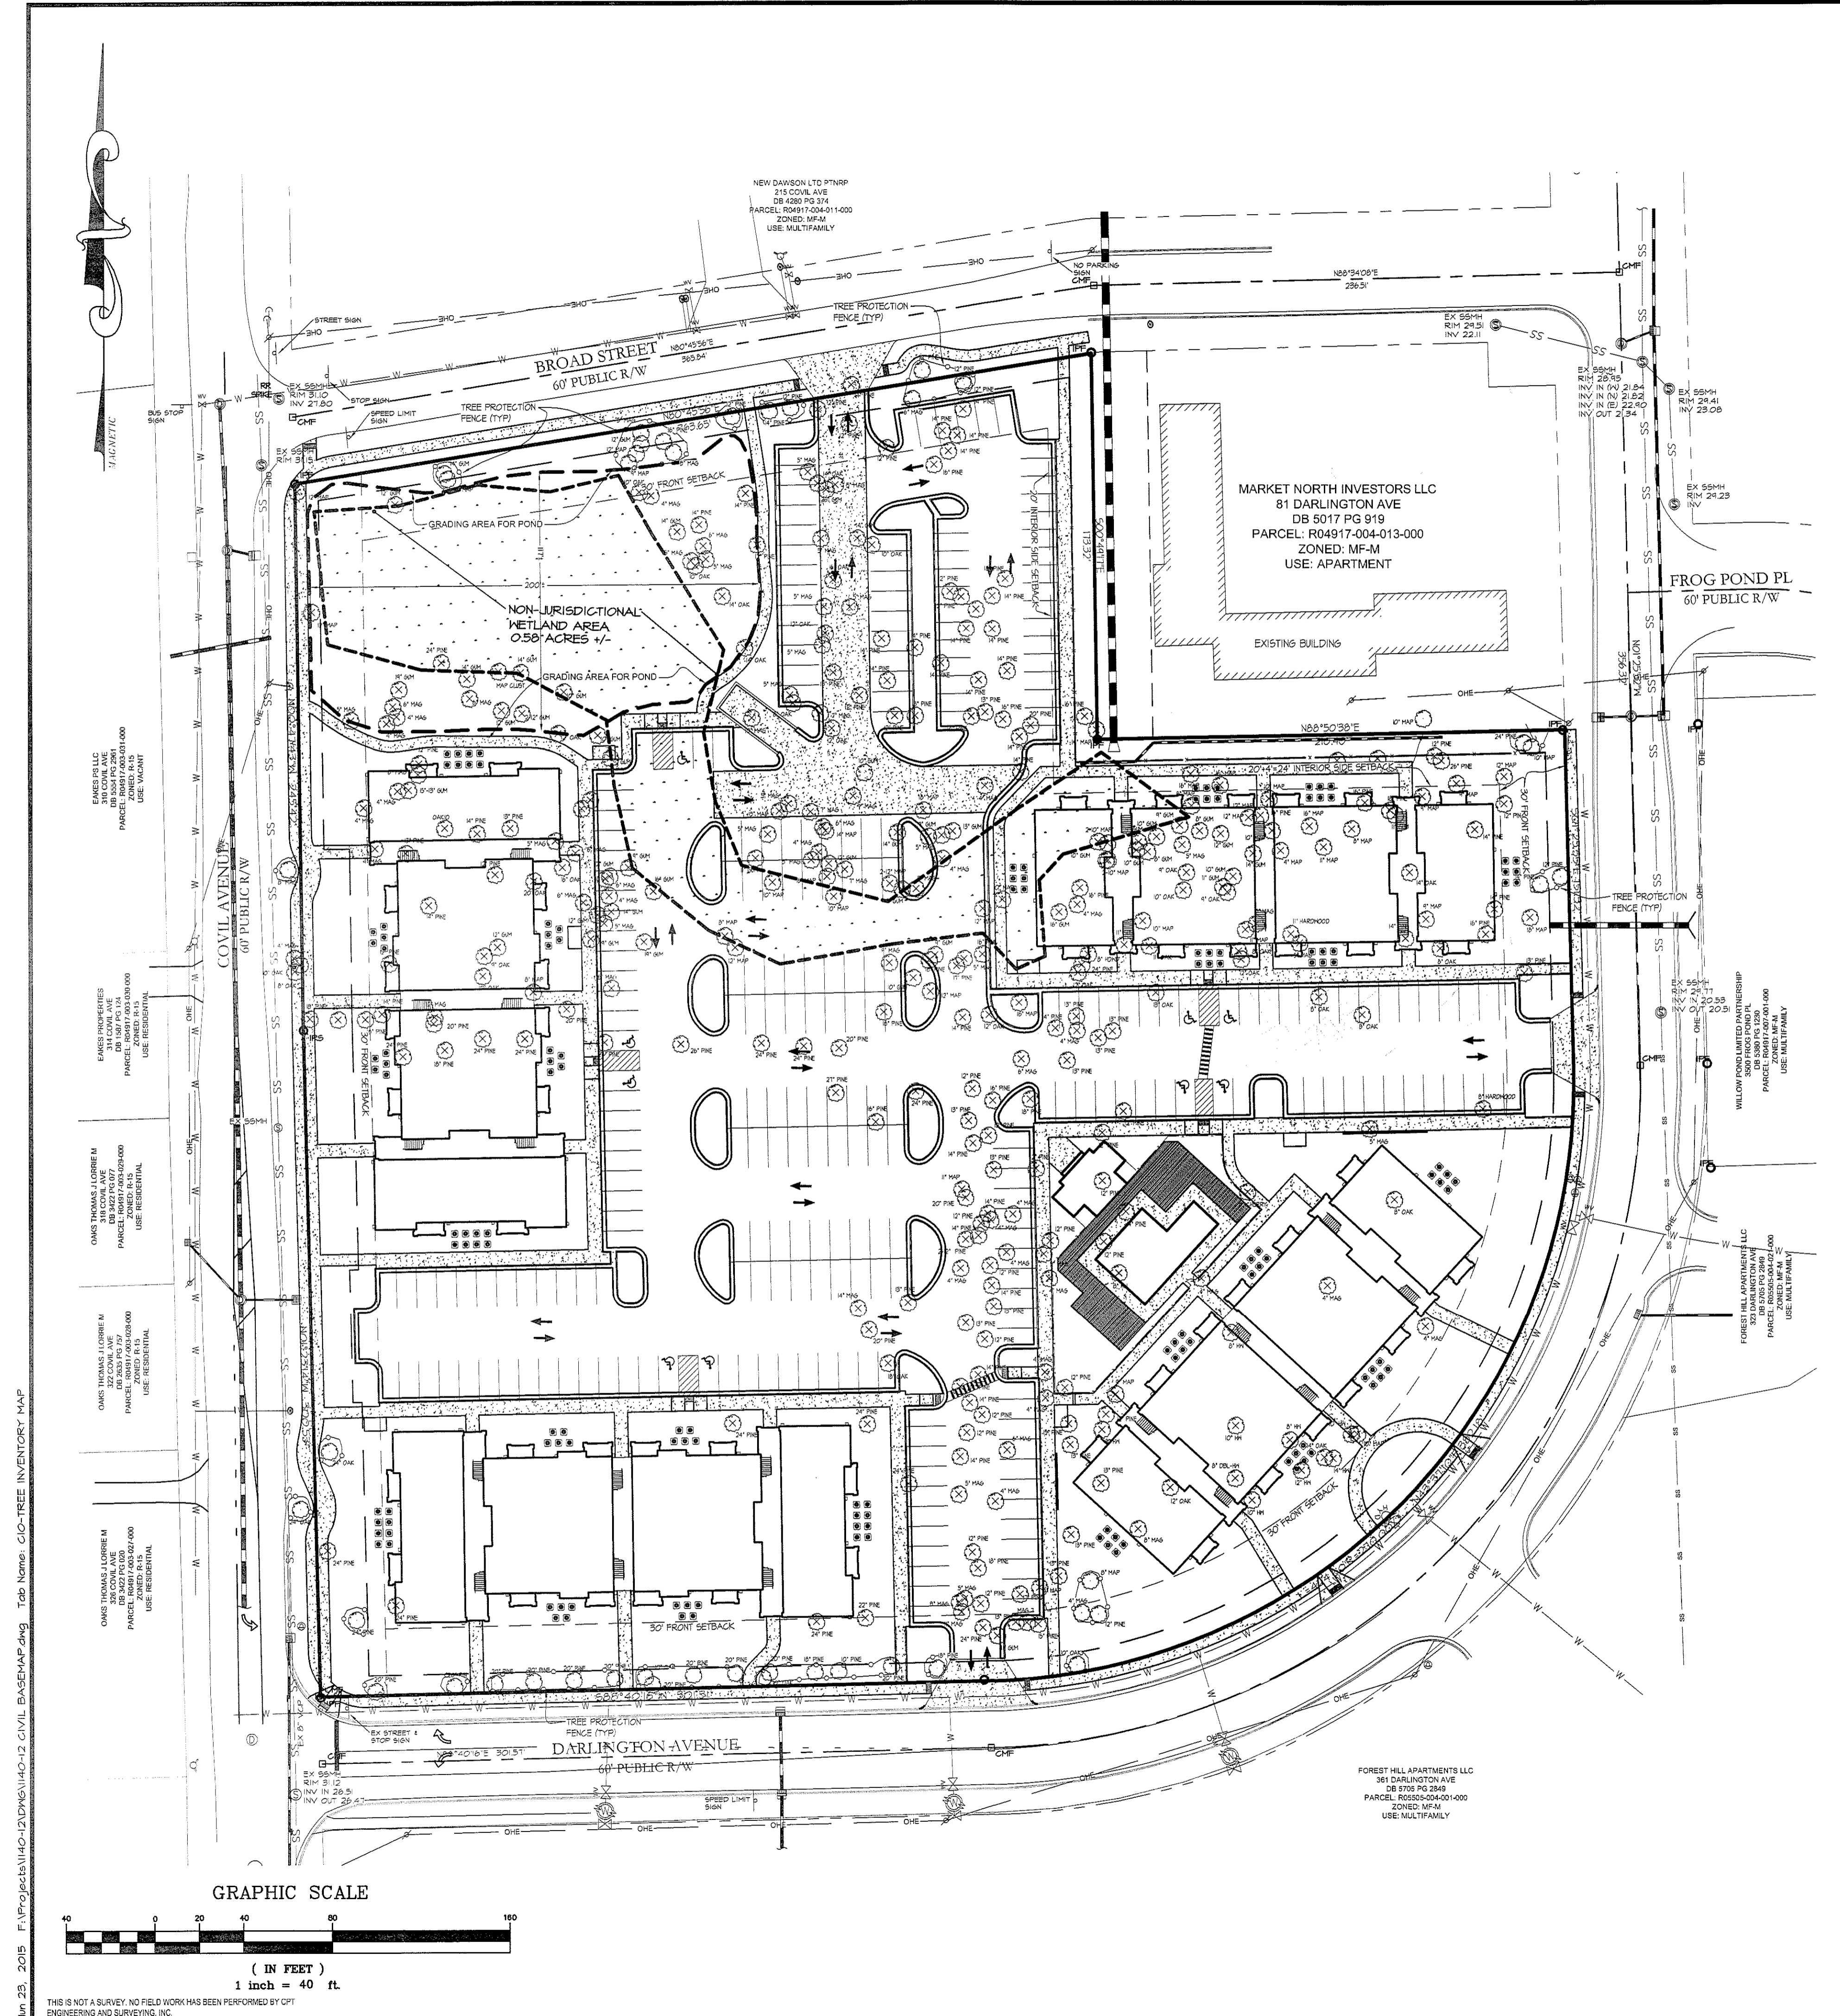

**TREE LEGEND:**  
 MAP = MAPLE  
 MAG = MAGNOLIA  
 HW = HARDWOOD  
 DBL = DOUBLE

EX TREE  
 EX TREE (TO BE REMOVED)  
 TREE PROTECTION FENCE


**TREE PROTECTION NOTE:**  
 TREE PROTECTION FENCING SHALL BE INSTALLED ALONG ALL PROTECTED TREES WITH SIGNAGE OF NO MATERIAL STORAGE IN ENGLISH AND SPANISH THROUGHOUT CONSTRUCTION.

A TREE PRESERVATION / REMOVAL PERMIT IS REQUIRED.

**REVISIONS**

REV	PER	CITY COMMENTS
02	16	2025

**ENGINEERING AND SURVEYING, INC.**  
 LAND DEVELOPMENT CONSULTING  
 CORPORATE OFFICE NUMBER: 01515  
 4400 TYNING STREET  
 HIGH POINT, NORTH CAROLINA 27285  
 PHONE: (856) 812-8800 ~ FAX: (856) 812-6180

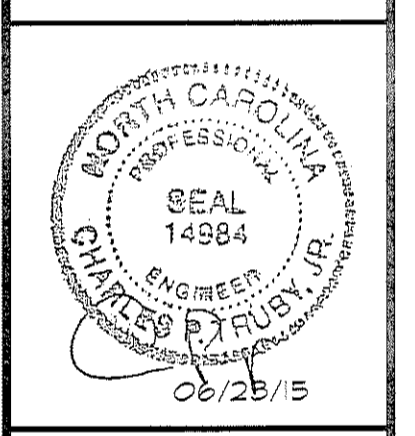

**TREE INVENTORY MAP**  
**ANNEXE AT THE RESERVE**  
 CITY OF WILMINGTON ~ WILMINGTON TOWNSHIP  
 NEW HANOVER COUNTY, NORTH CAROLINA

315 & 323 COVIL AVE.

**TREE INVENTORY MAP**

SCALE: 1" = 40'

DATE: 03/17/15

PROJECT: 1140-12

DRAWN BY: TGL

SHEET **C-10**

**OWNER / DEVELOPER:**  
 BRC WILMINGTON LLC  
 5826 SAMET DRIVE, SUITE 105  
 HIGH POINT, NC 27285  
 PHONE: (336) 889-1512  
 FAX: (336) 889-1501

**ENGINEER:**  
 CPT ENGINEERING & SURVEYING, INC.  
 4400 TYNING STREET  
 HIGH POINT, NC 27285  
 CONTACT: CHUCK TRUBY, P.E.  
 PHONE: (336) 812-8800 ext:304  
 FAX: (336) 812-8780

**CITY OF WILMINGTON**  
 NORTH CAROLINA  
 Public Services • Engineering Division  
 APPROVED STORMWATER MANAGEMENT PLAN

Date: \_\_\_\_\_ Permit # \_\_\_\_\_  
 Signed: \_\_\_\_\_


**Approved Construction Plan**

Name \_\_\_\_\_ Date \_\_\_\_\_

Planning \_\_\_\_\_

Traffic \_\_\_\_\_

Fire \_\_\_\_\_


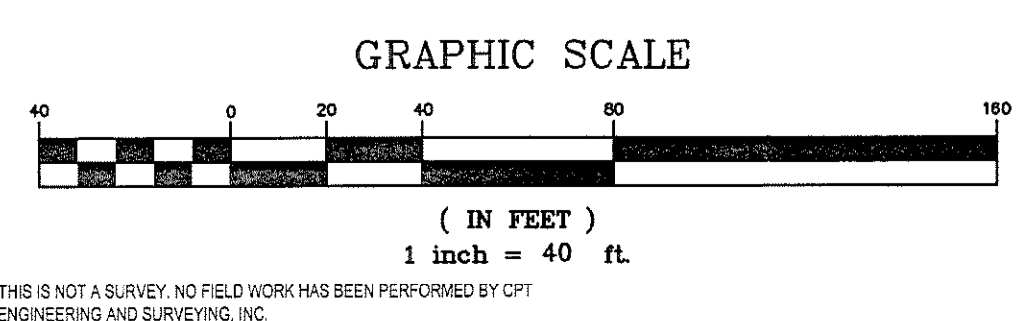


JAN 25, 2015 F:\Projects\1140-12\DWG\1140-12\_CIVIL\_BASEMAP.dwg Top Name: CO-TREE INVENTORY MAP

THIS IS NOT A SURVEY. NO FIELD WORK HAS BEEN PERFORMED BY CPT ENGINEERING AND SURVEYING, INC.




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**REVISIONS**

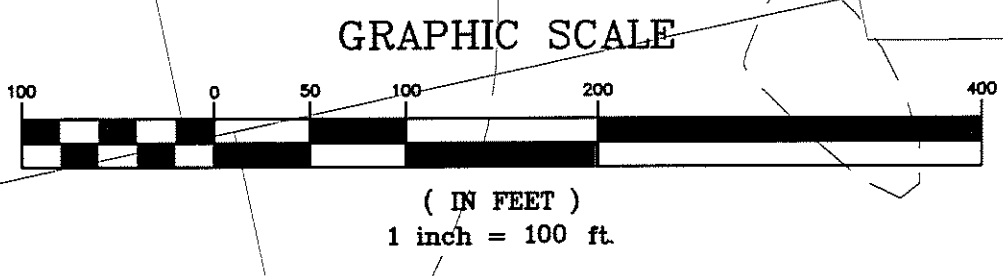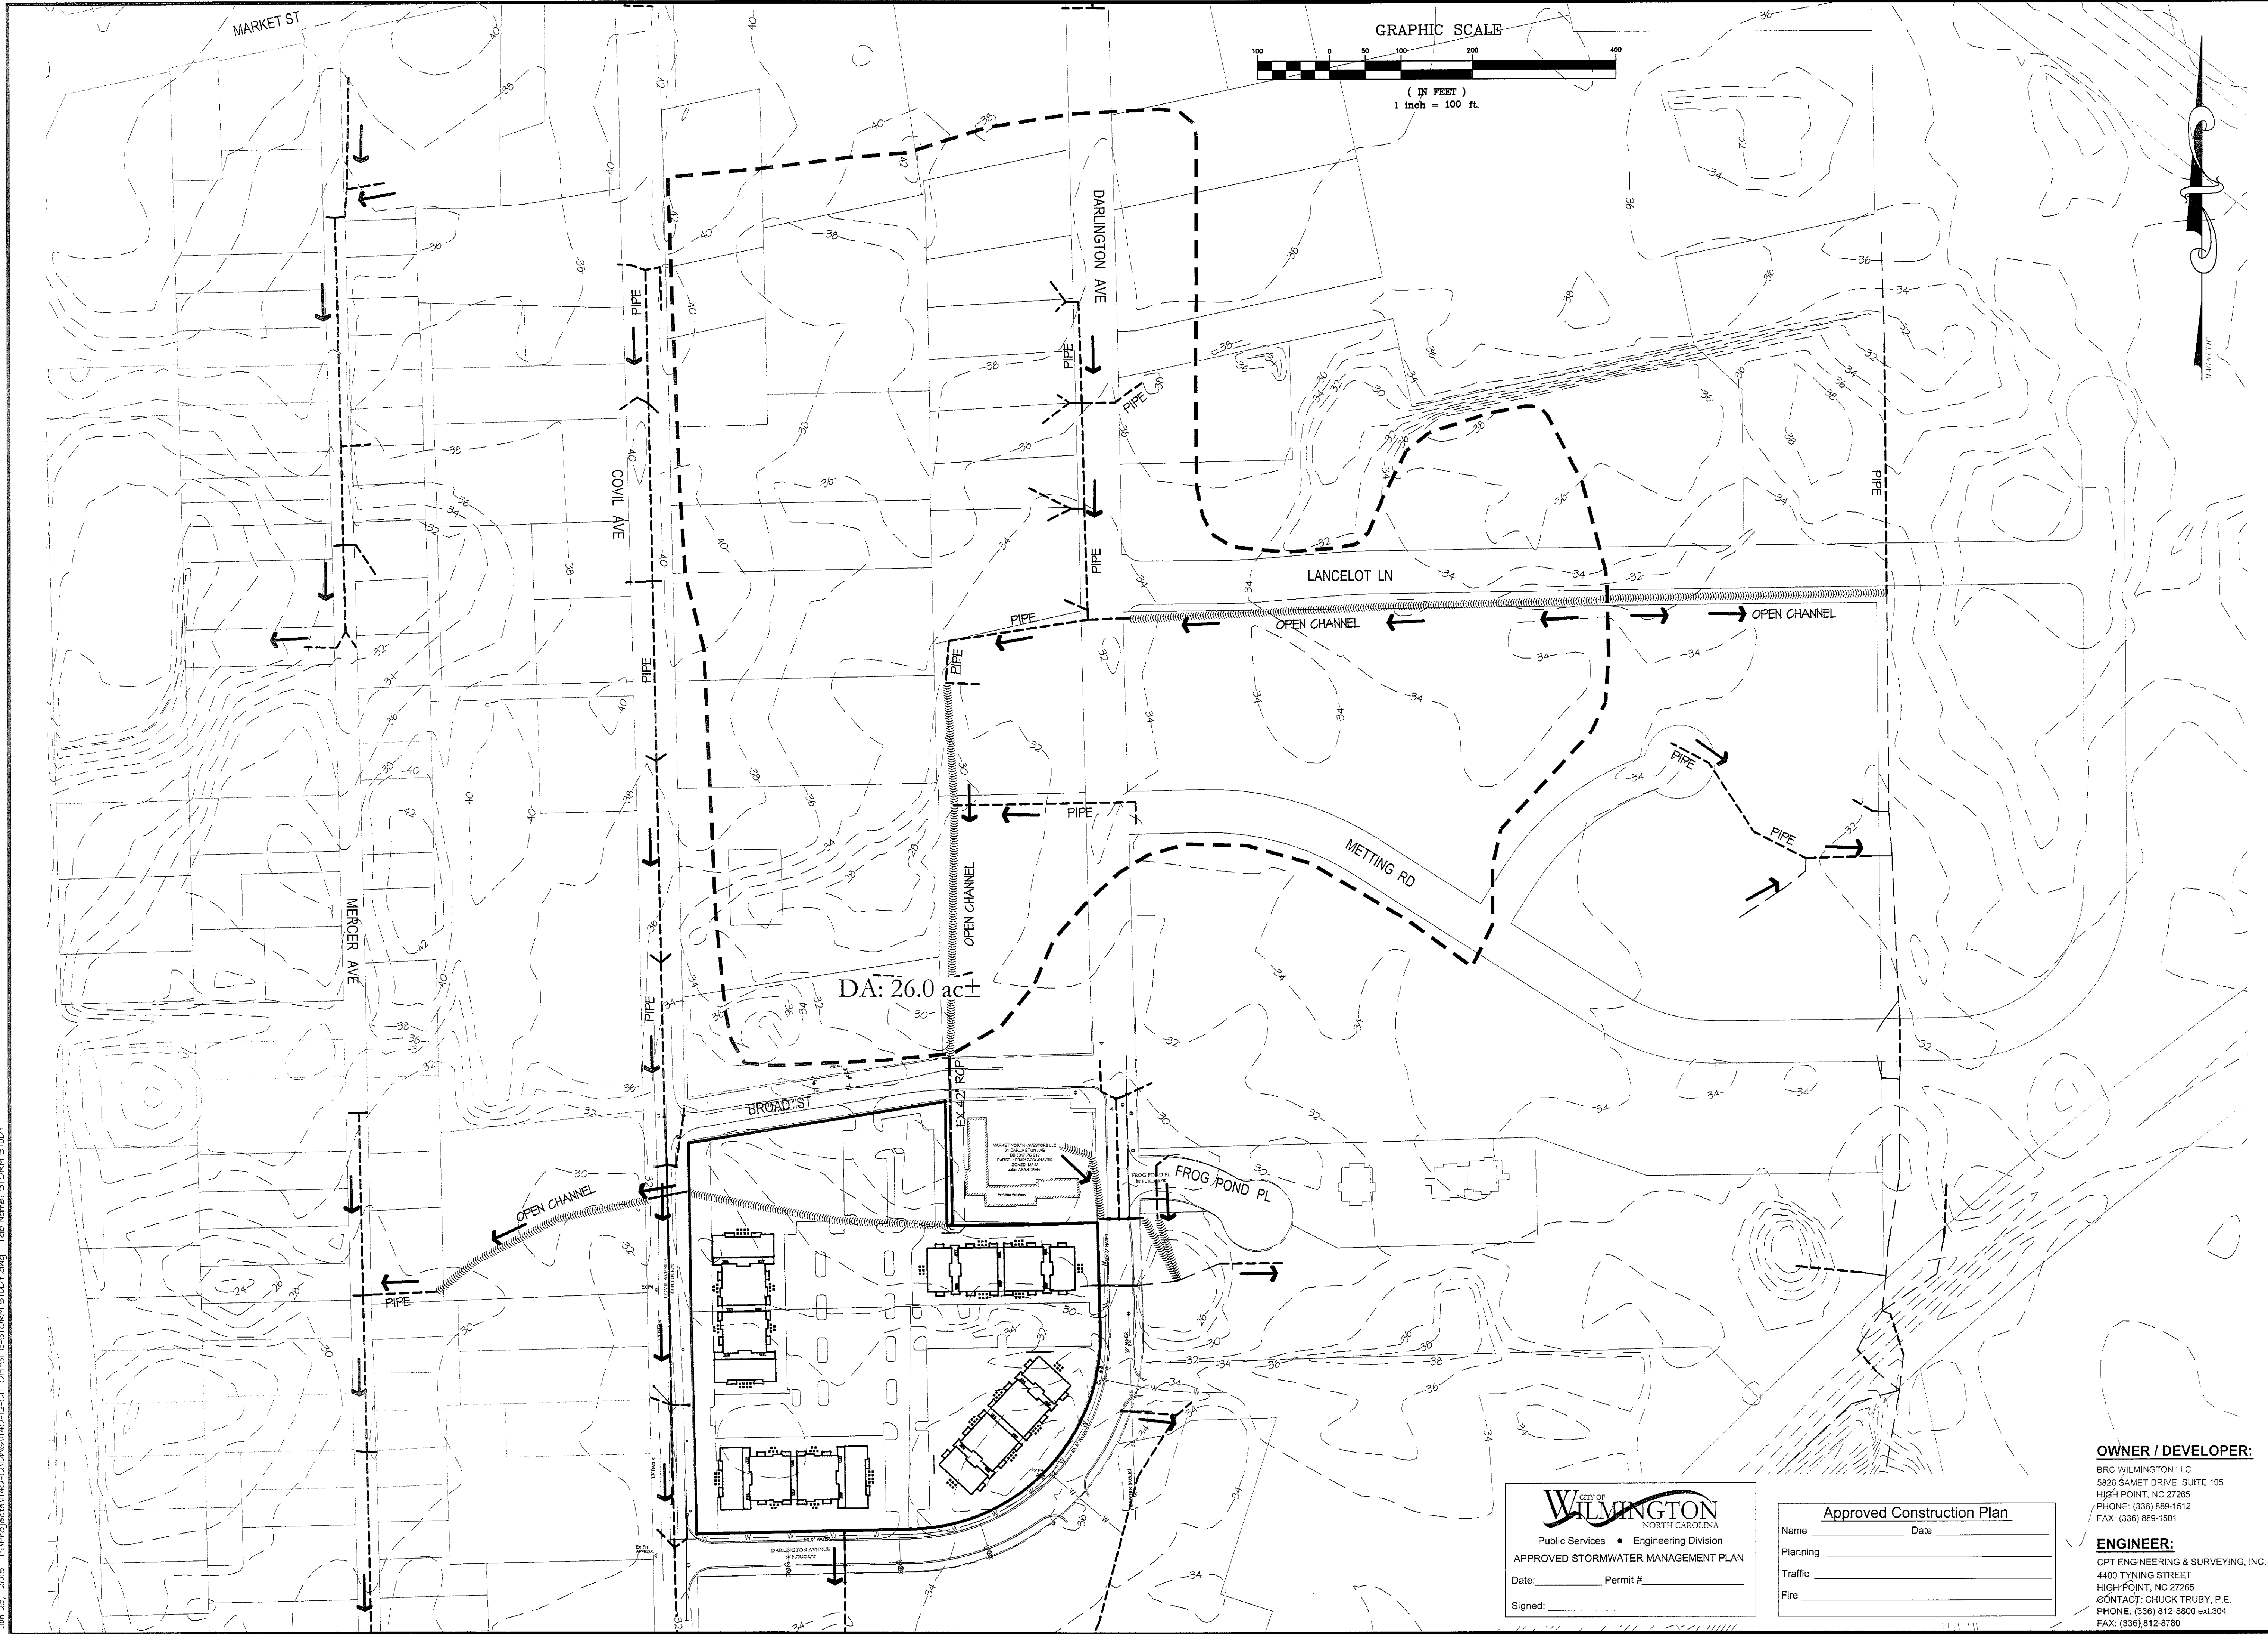NO.	DATE	DESCRIPTION
1	08-16-2015	REV PER CITY COMMENTS

**ENGINEERING AND SURVEYING, INC.**  
 LAND DEVELOPMENT CONSULTING  
 CORPORATE LICENSE NUMBER C-1975  
 4400 TYNING STREET  
 HIGH POINT, NORTH CAROLINA 27265  
 PHONE: (336) 812-8800 FAX: (336) 812-8180



**OFF-SITE DRAINAGE AREA MAP**  
**ANNEXE AT THE RESERVE**  
 CITY OF WILMINGTON ~ WILMINGTON TOWNSHIP  
 NEW HANOVER COUNTY, NORTH CAROLINA

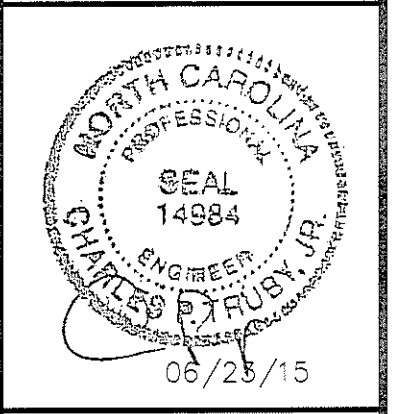315 & 323 COVIL AVE.  
**OFF-SITE DRAINAGE AREA MAP**  
 SCALE: 1" = 100'  
 DATE: 03/17/15  
 PROJECT: 1140-12  
 DRAWN BY: TGL  
 SHEET: C11

DA: 26.0 ac±

**CITY OF WILMINGTON**  
 NORTH CAROLINA  
 Public Services • Engineering Division  
**APPROVED STORMWATER MANAGEMENT PLAN**  
 Date: \_\_\_\_\_ Permit # \_\_\_\_\_  
 Signed: \_\_\_\_\_

**Approved Construction Plan**

Name \_\_\_\_\_ Date \_\_\_\_\_

Planning \_\_\_\_\_









Traffic \_\_\_\_\_

Fire \_\_\_\_\_

**OWNER / DEVELOPER:**  
 BRC WILMINGTON LLC  
 5829 SAMET DRIVE, SUITE 105  
 HIGH POINT, NC 27265  
 PHONE: (336) 888-1512  
 FAX: (336) 888-1501

**ENGINEER:**  
 CPT ENGINEERING & SURVEYING, INC.  
 4400 TYNING STREET  
 HIGH POINT, NC 27265  
 CONTACT: CHUCK TRUBY, P.E.  
 PHONE: (336) 812-8800 ext.304  
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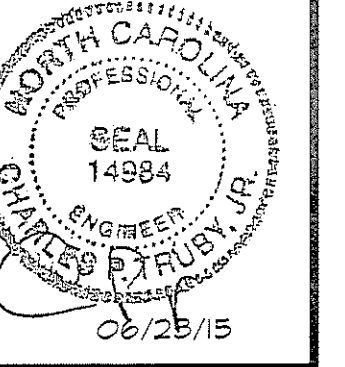
**CITY OF WILMINGTON**  
NORTH CAROLINA  
Public Services • Engineering Division  
APPROVED STORMWATER MANAGEMENT PLAN  
Date: \_\_\_\_\_ Permit # \_\_\_\_\_  
Signed: \_\_\_\_\_

**Approved Construction Plan**  
Name \_\_\_\_\_ Date \_\_\_\_\_  
Planning \_\_\_\_\_  
Traffic \_\_\_\_\_  
Fire \_\_\_\_\_

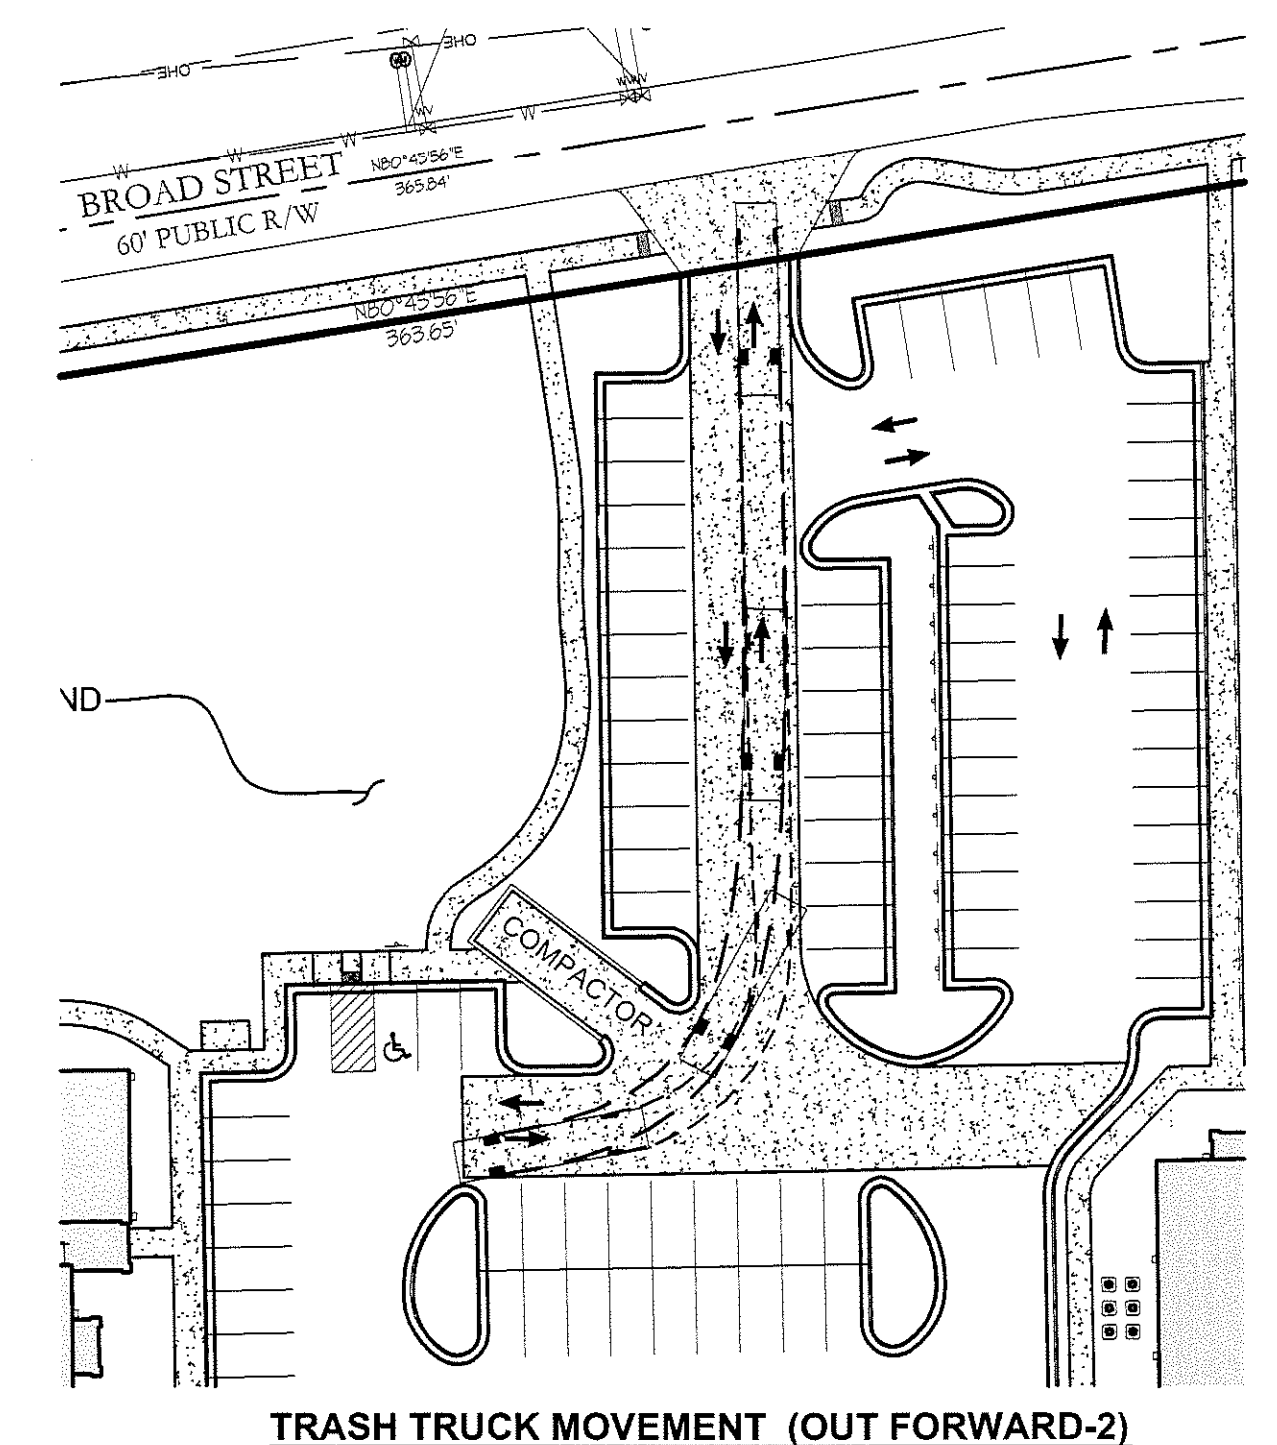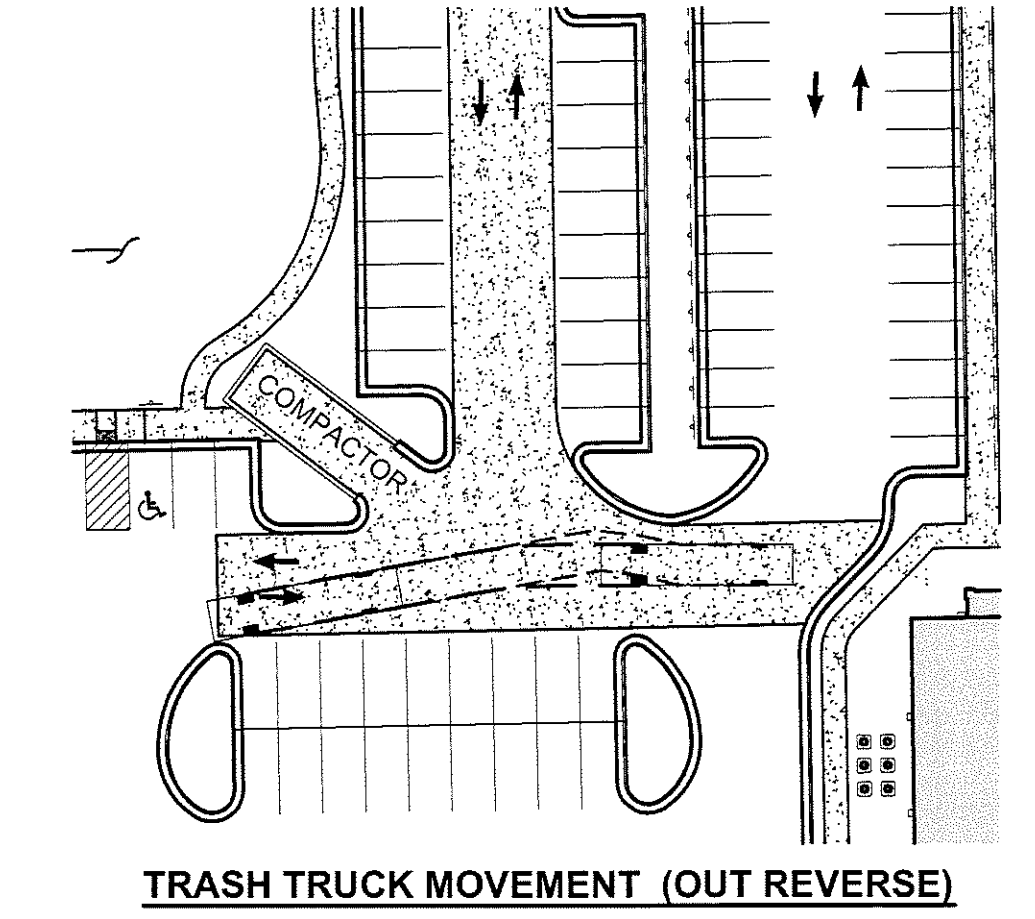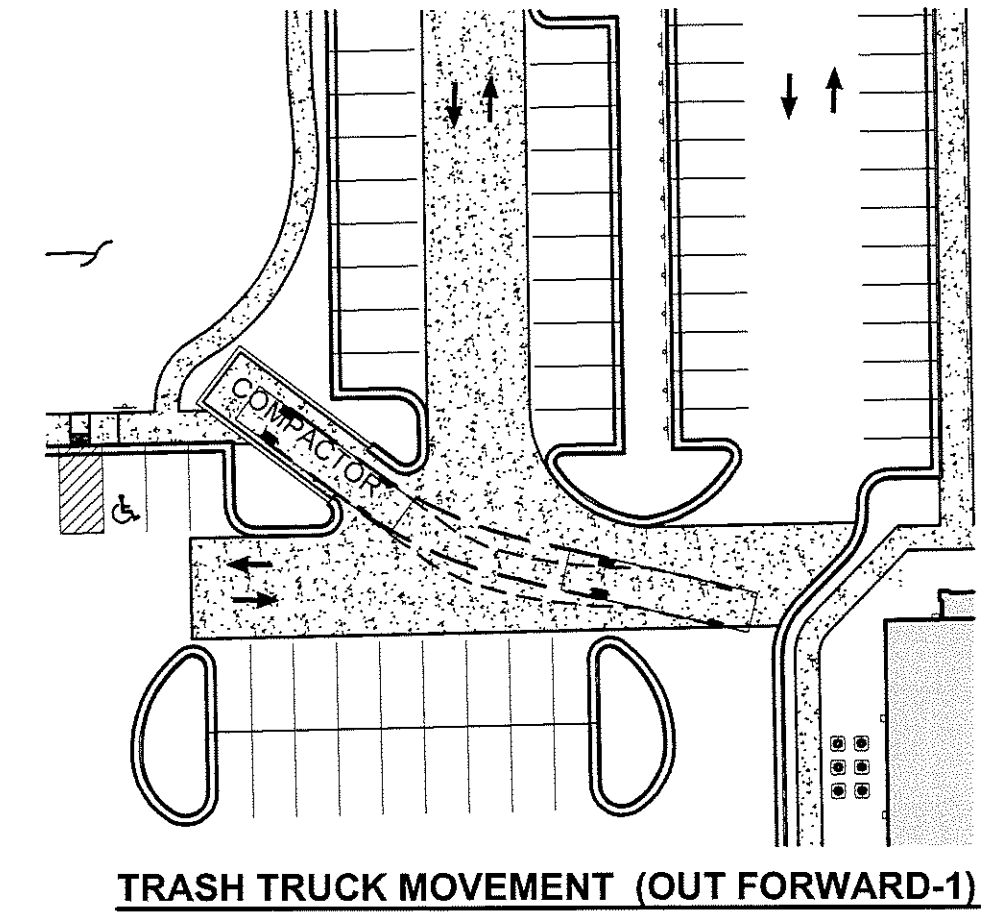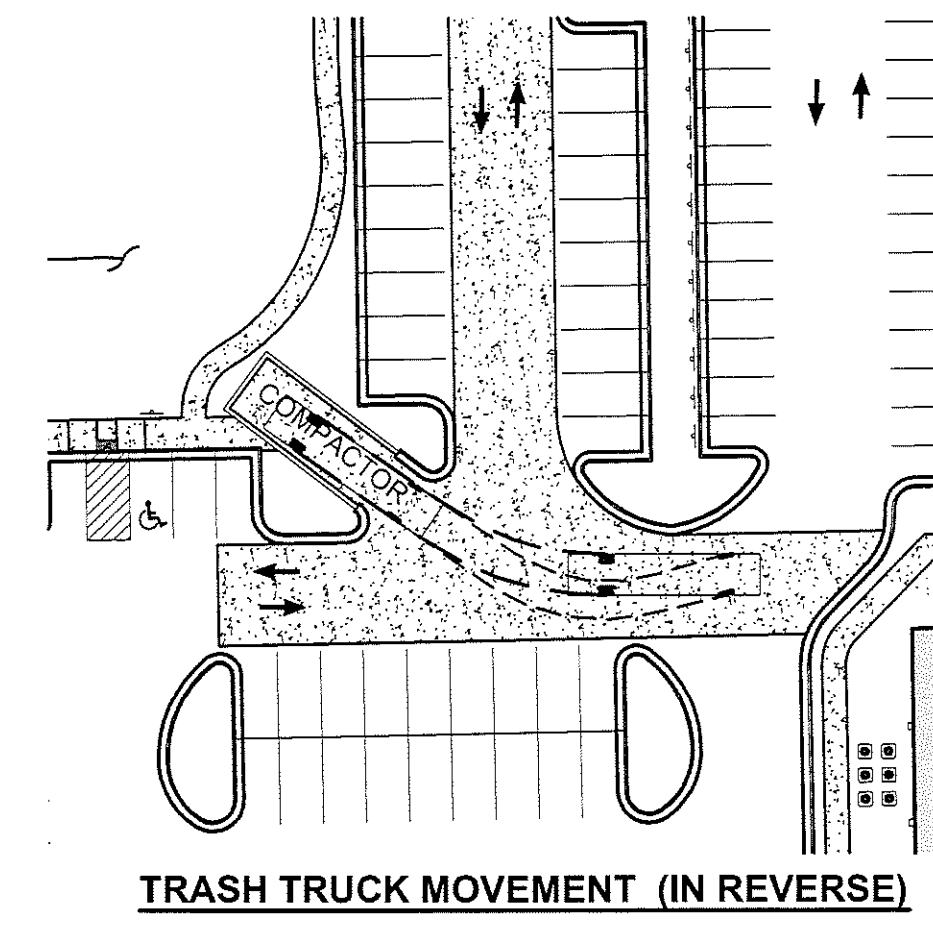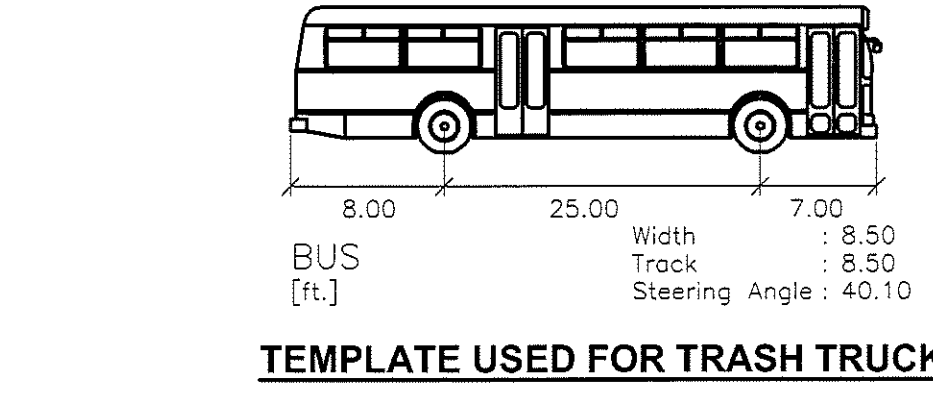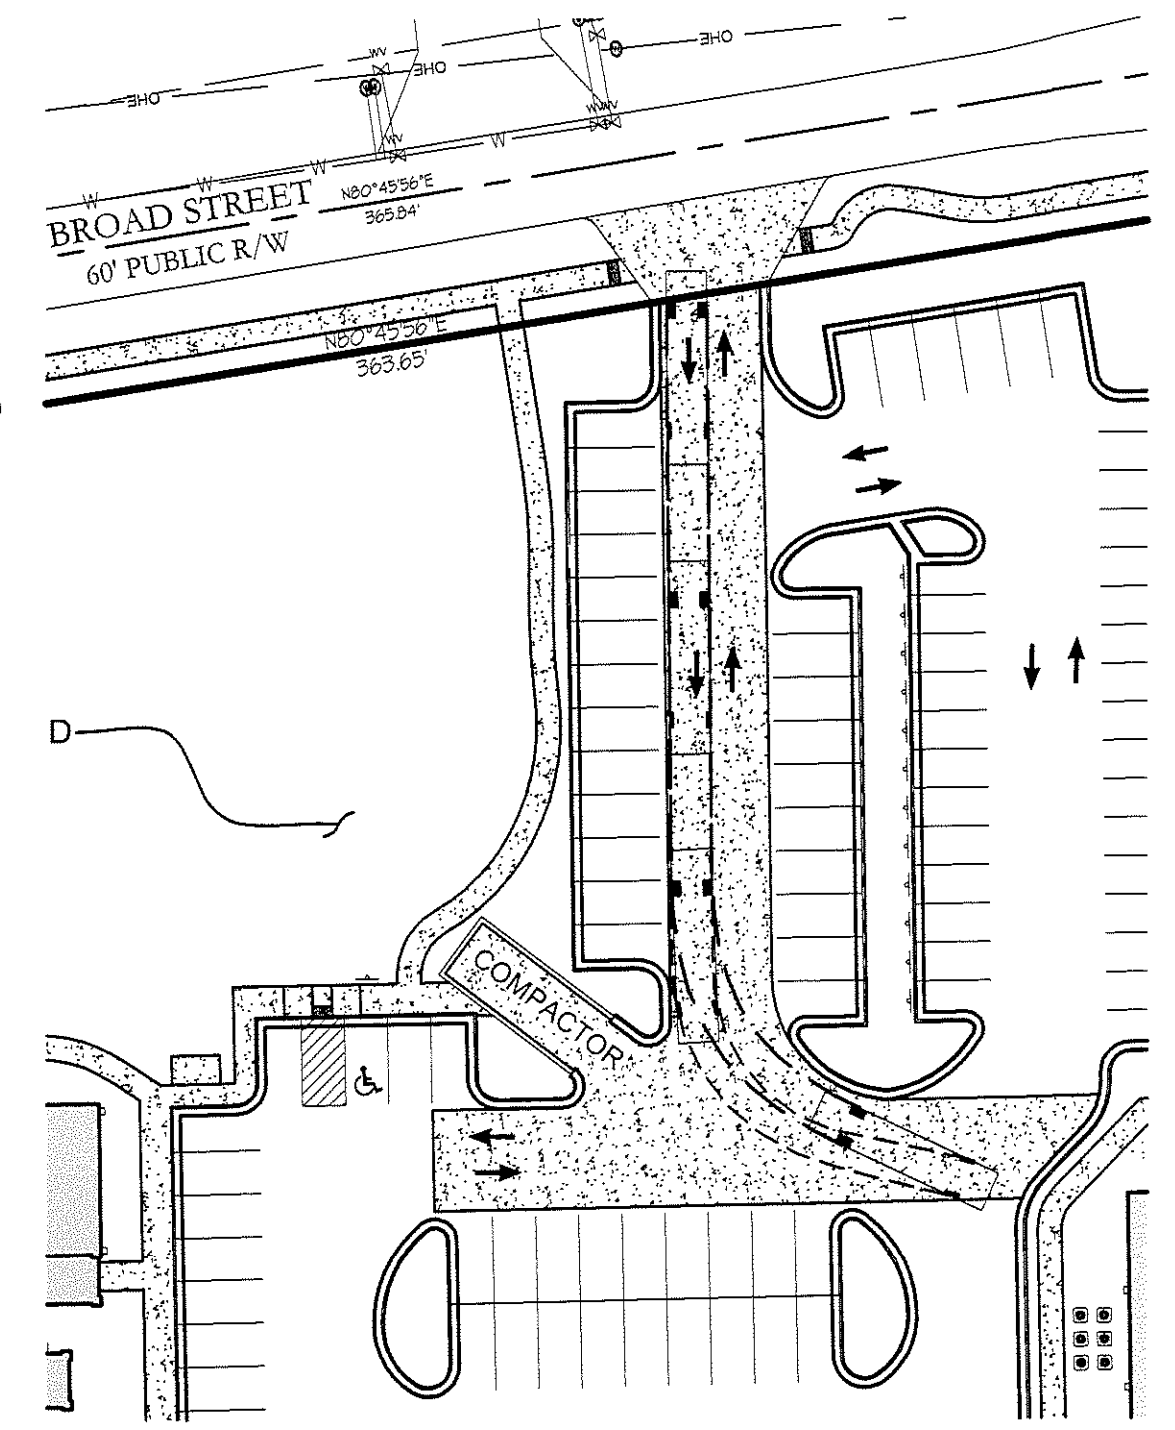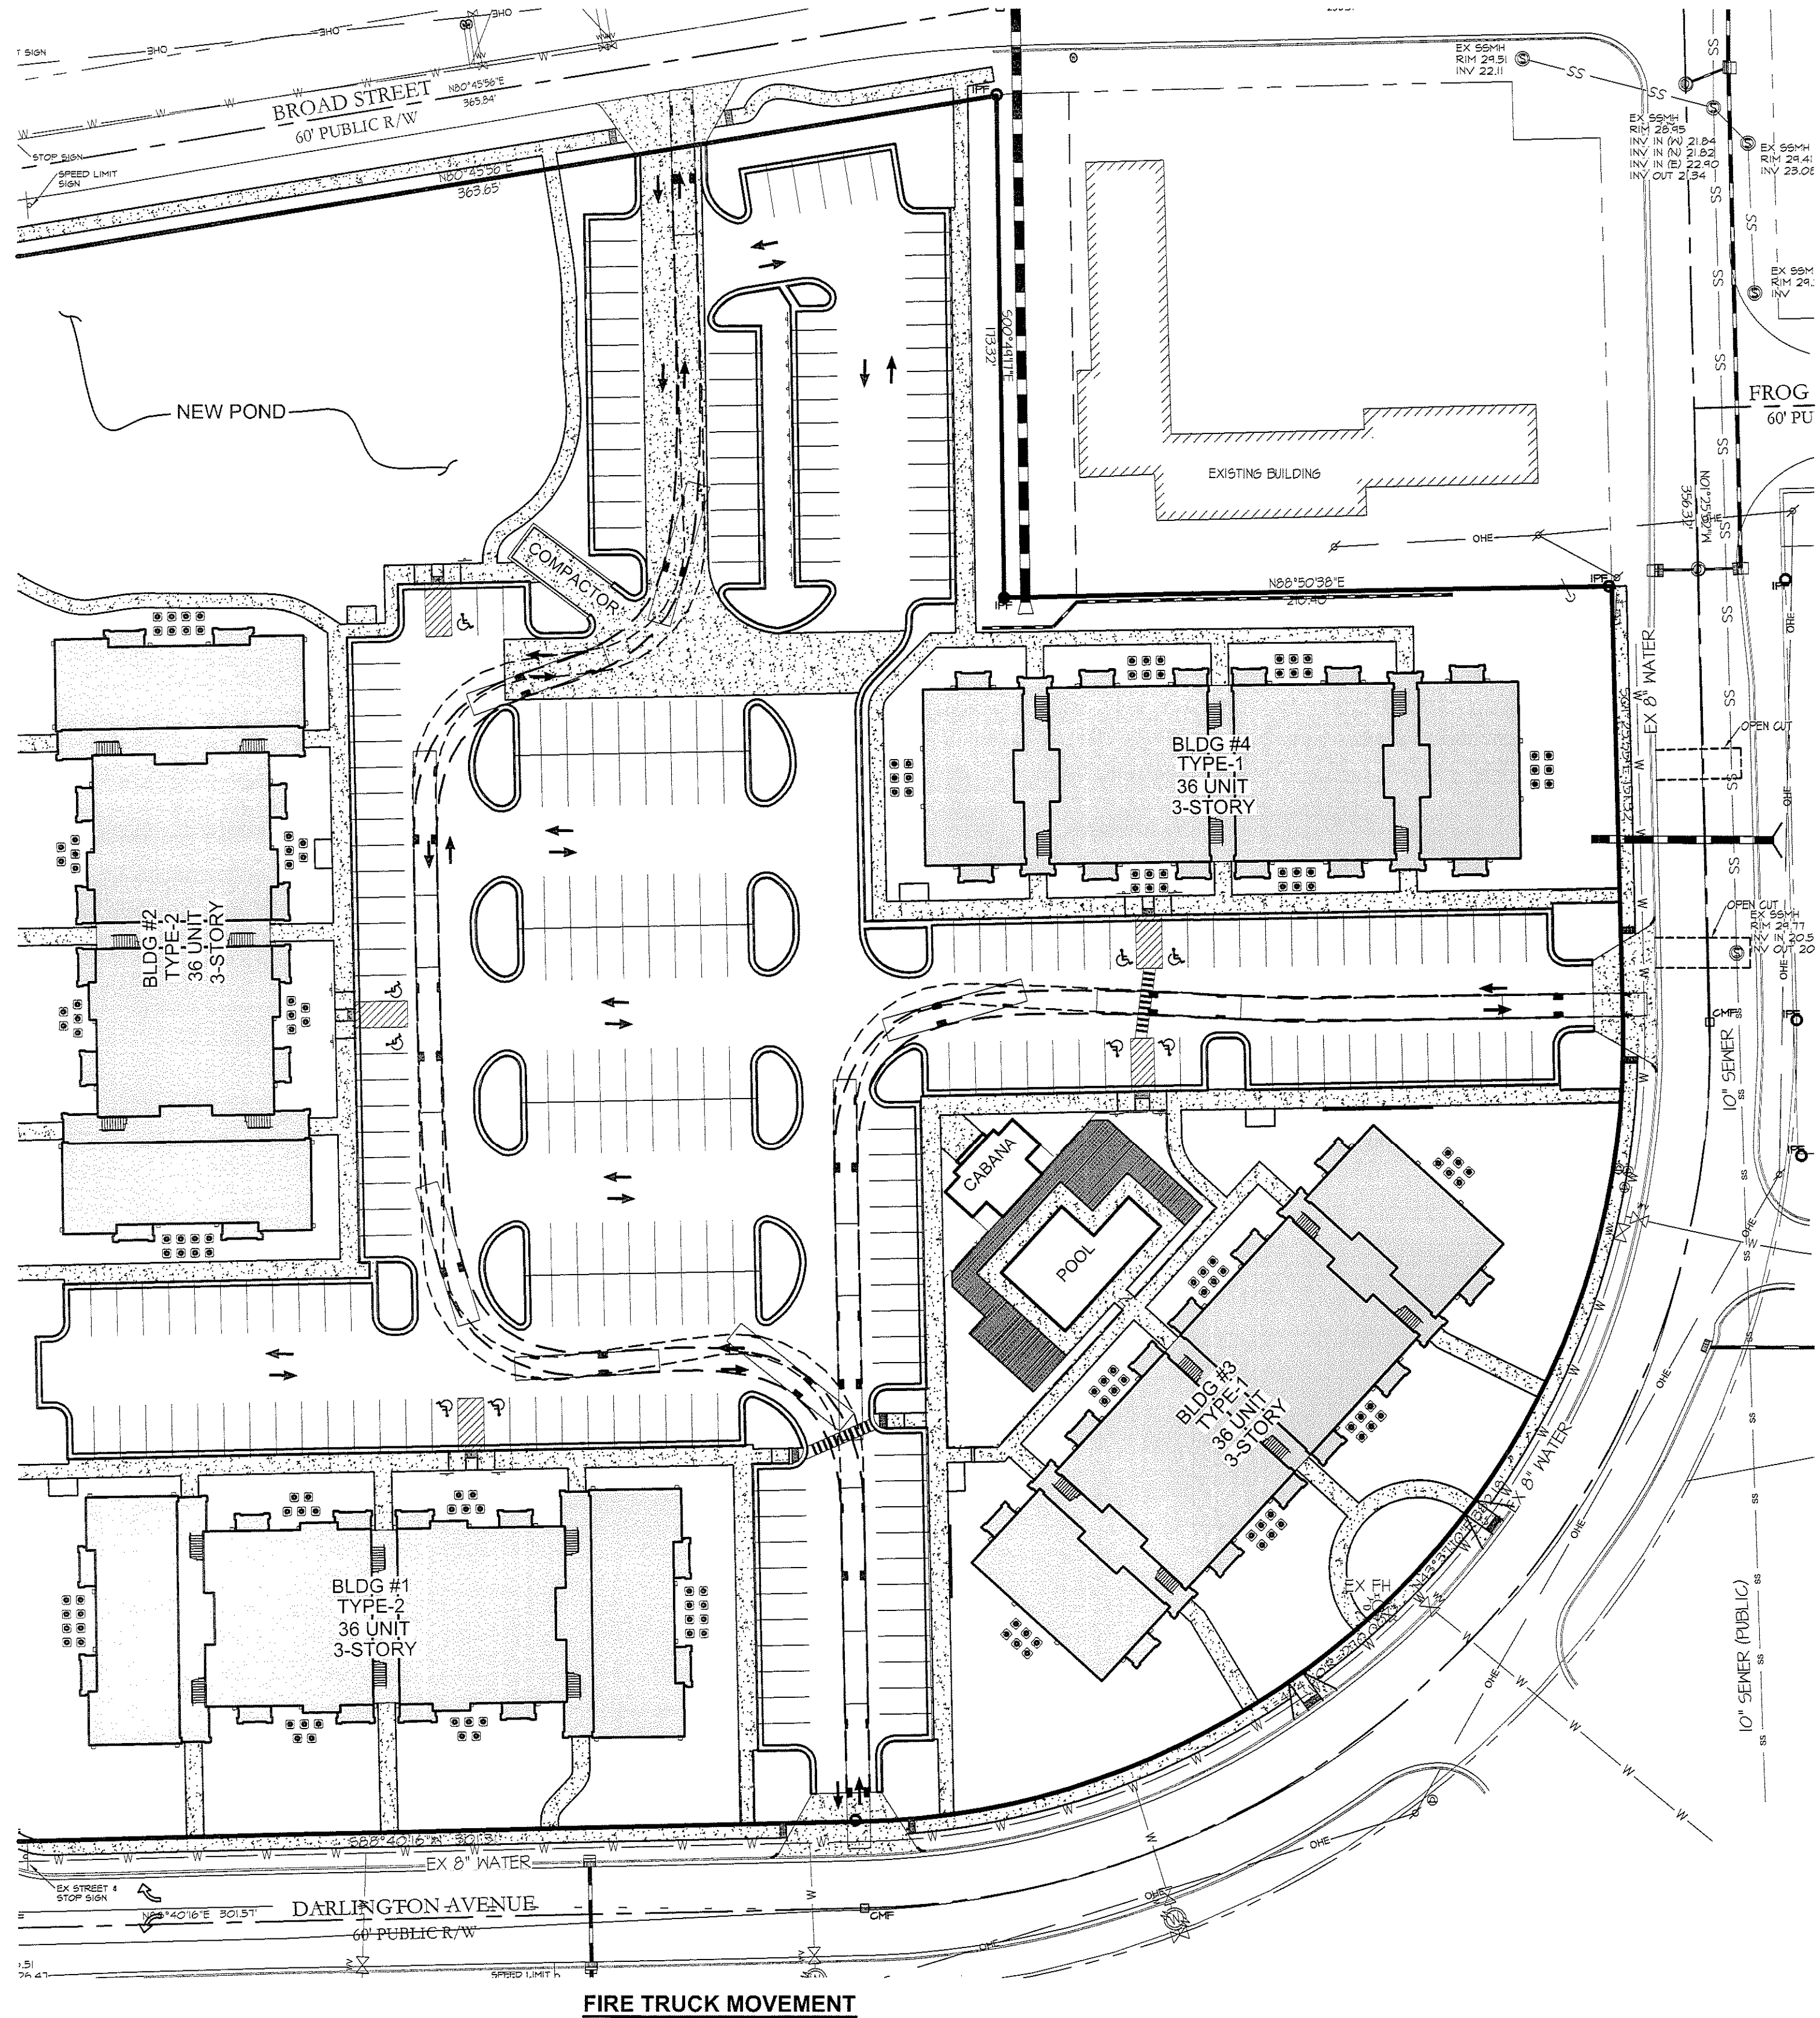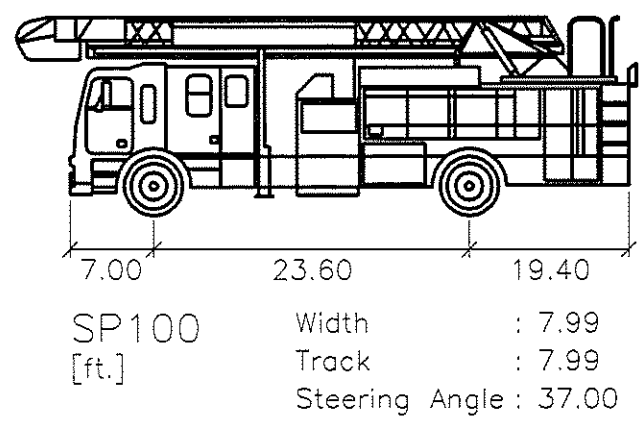**REVISIONS**

REV	PER	CITY COMMENTS
1	REV PER CITY COMMENTS	08-18-2015

**ENGINEERING AND SURVEYING, INC.**  
LAND DEVELOPMENT CONSULTING  
CORPORATE LICENSE NUMBER C-1875  
4400 TANNING STREET  
HIGH POINT, NORTH CAROLINA 27265  
PHONE: (336) 912-9800 FAX: (336) 912-9790



**TRUCK MOVEMENT PLAN**  
**ANNEXE AT THE RESERVE**  
CITY OF WILMINGTON ~ WILMINGTON TOWNSHIP  
NEW HANOVER COUNTY, NORTH CAROLINA


315 & 323 COVIL AVE.

**TRUCK MOVEMENT PLAN**


SCALE: 1" = 40'  
DATE: 03/17/15  
PROJECT: 1140-12  
DRAWN BY: TGL  
SHEET **C-12**

Jun 23, 2015 2:05 PM F:\Projects\1140-12\DWG\1140-12\_CIVIL\_BASE\SWMP.dwg Tab Name: C12-AUTOTURN




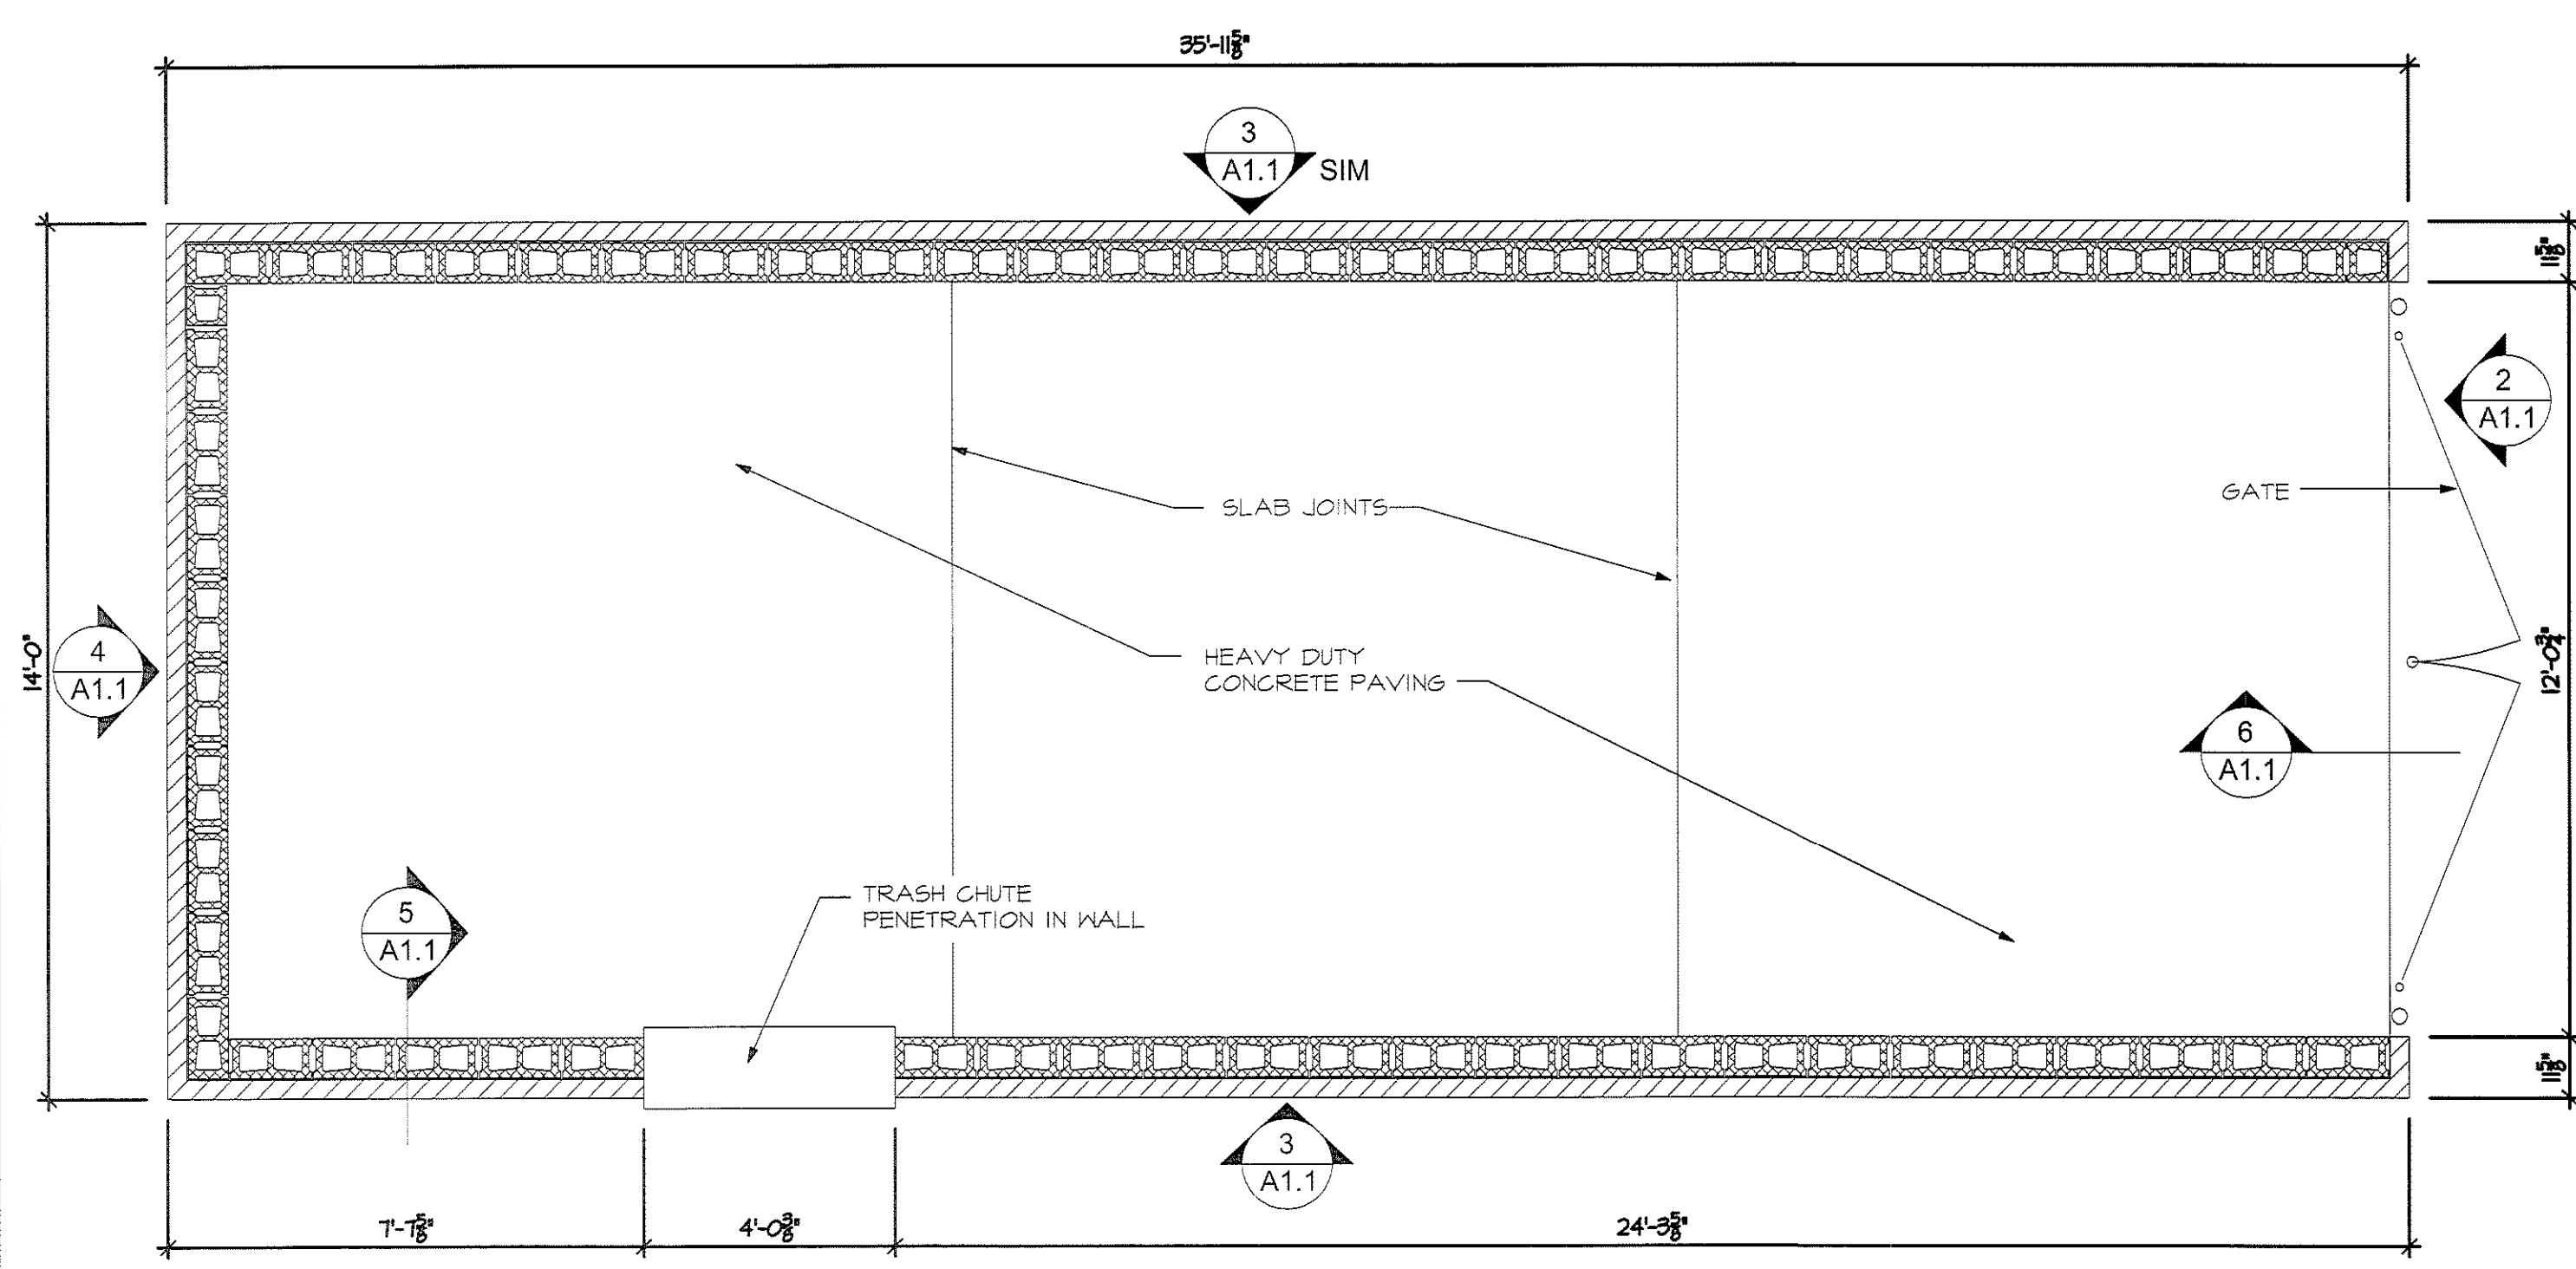


TRASH COMPACTOR PLAN  
SCALE: 3/8" = 1'-0"

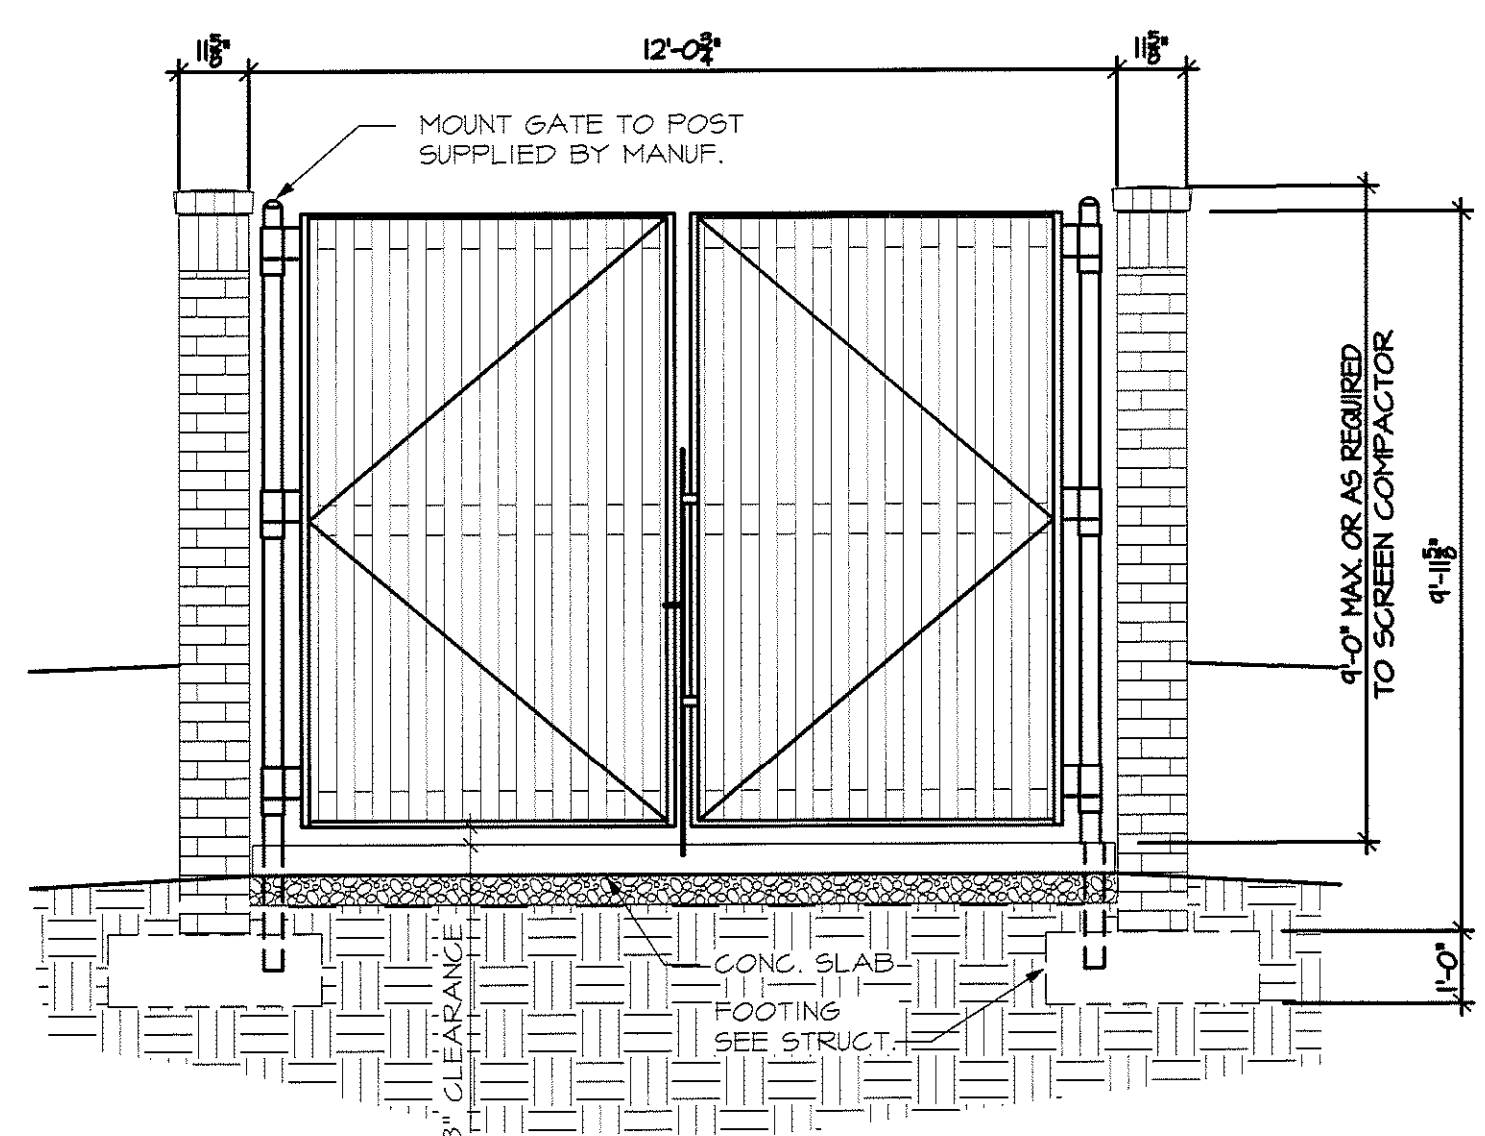


FRONT ELEVATION  
SCALE: 3/8" = 1'-0"

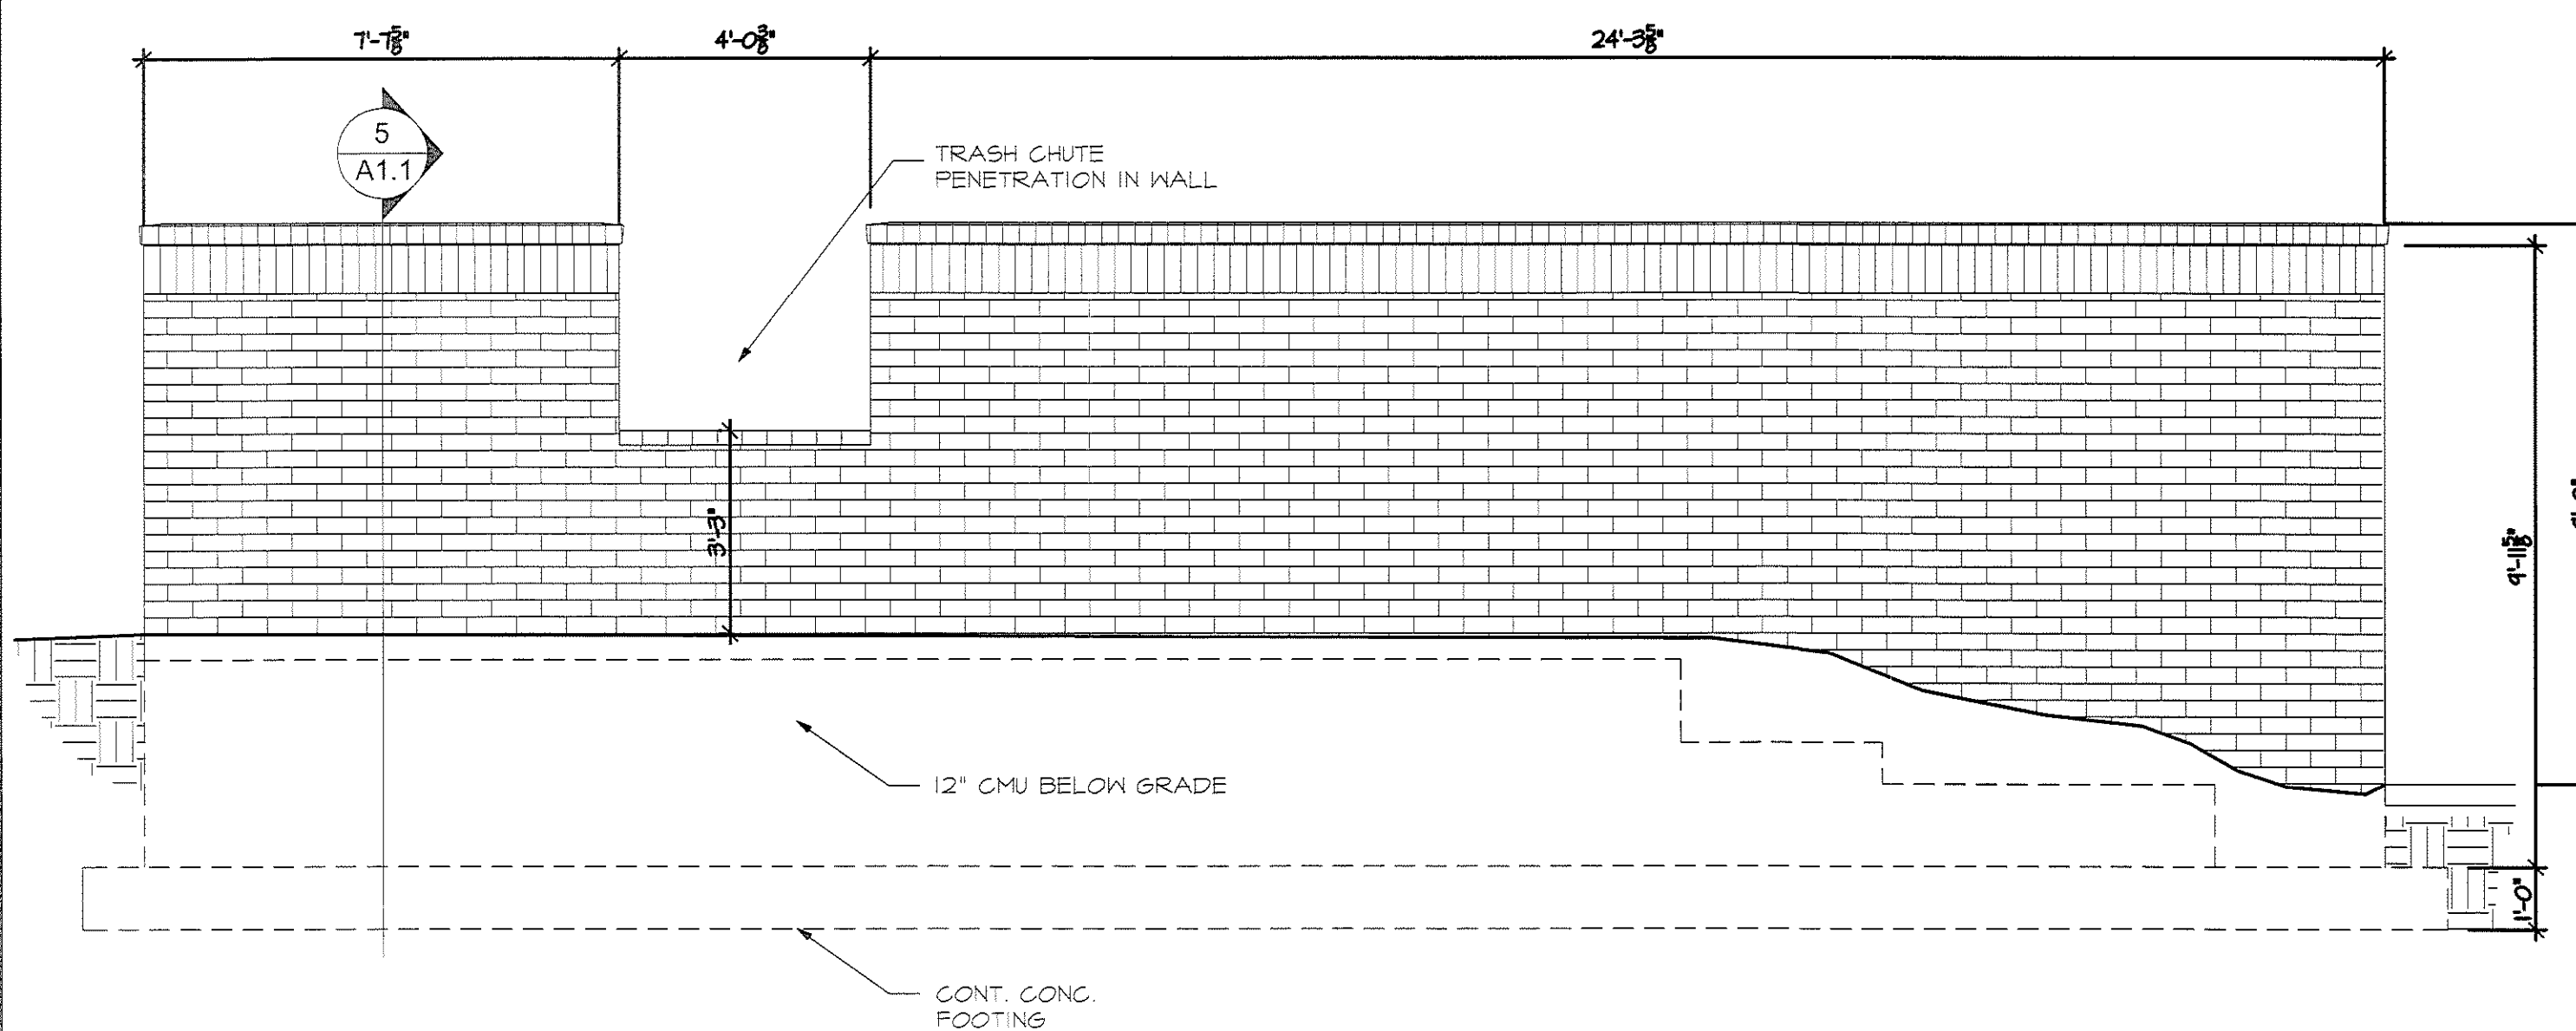


SIDE ELEVATION  
SCALE: 3/8" = 1'-0"

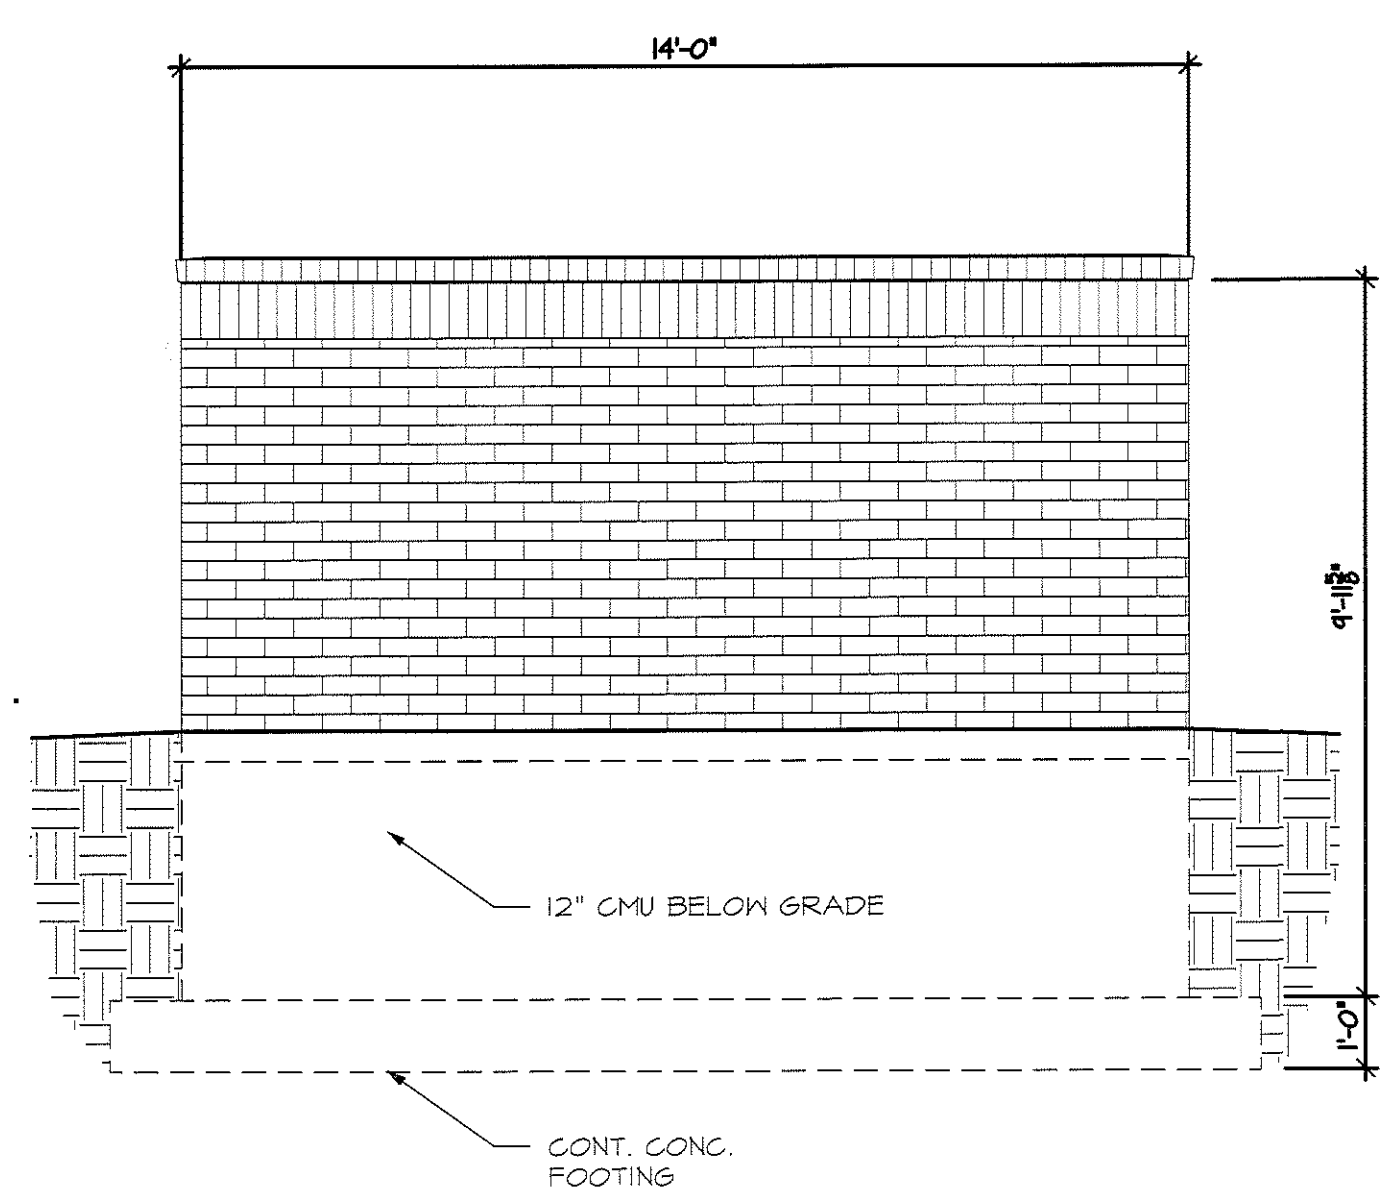

REAR ELEVATION  
SCALE: 3/8" = 1'-0"

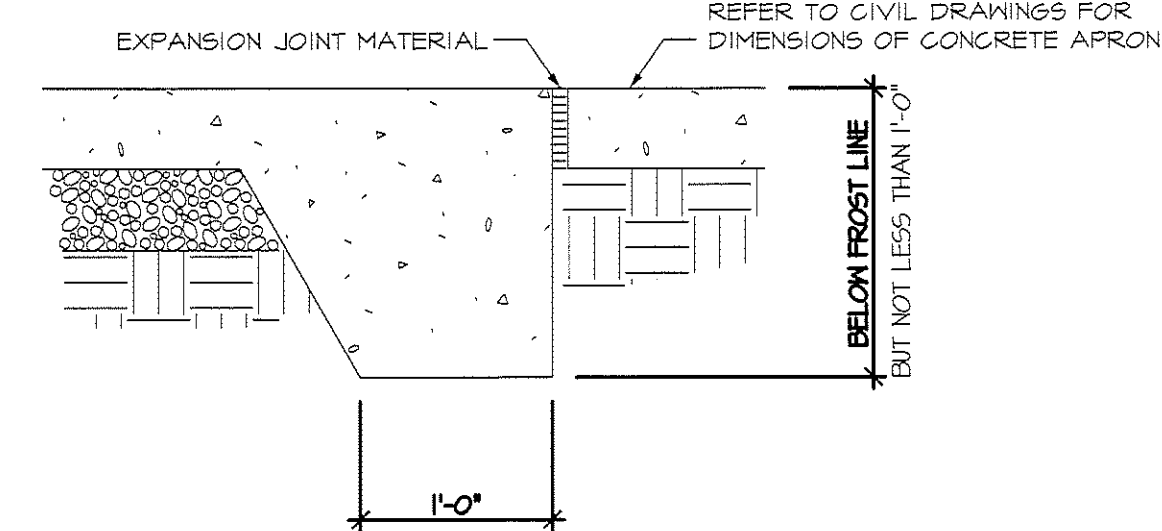


CROSS SECTION  
SCALE: 1" = 1'-0"

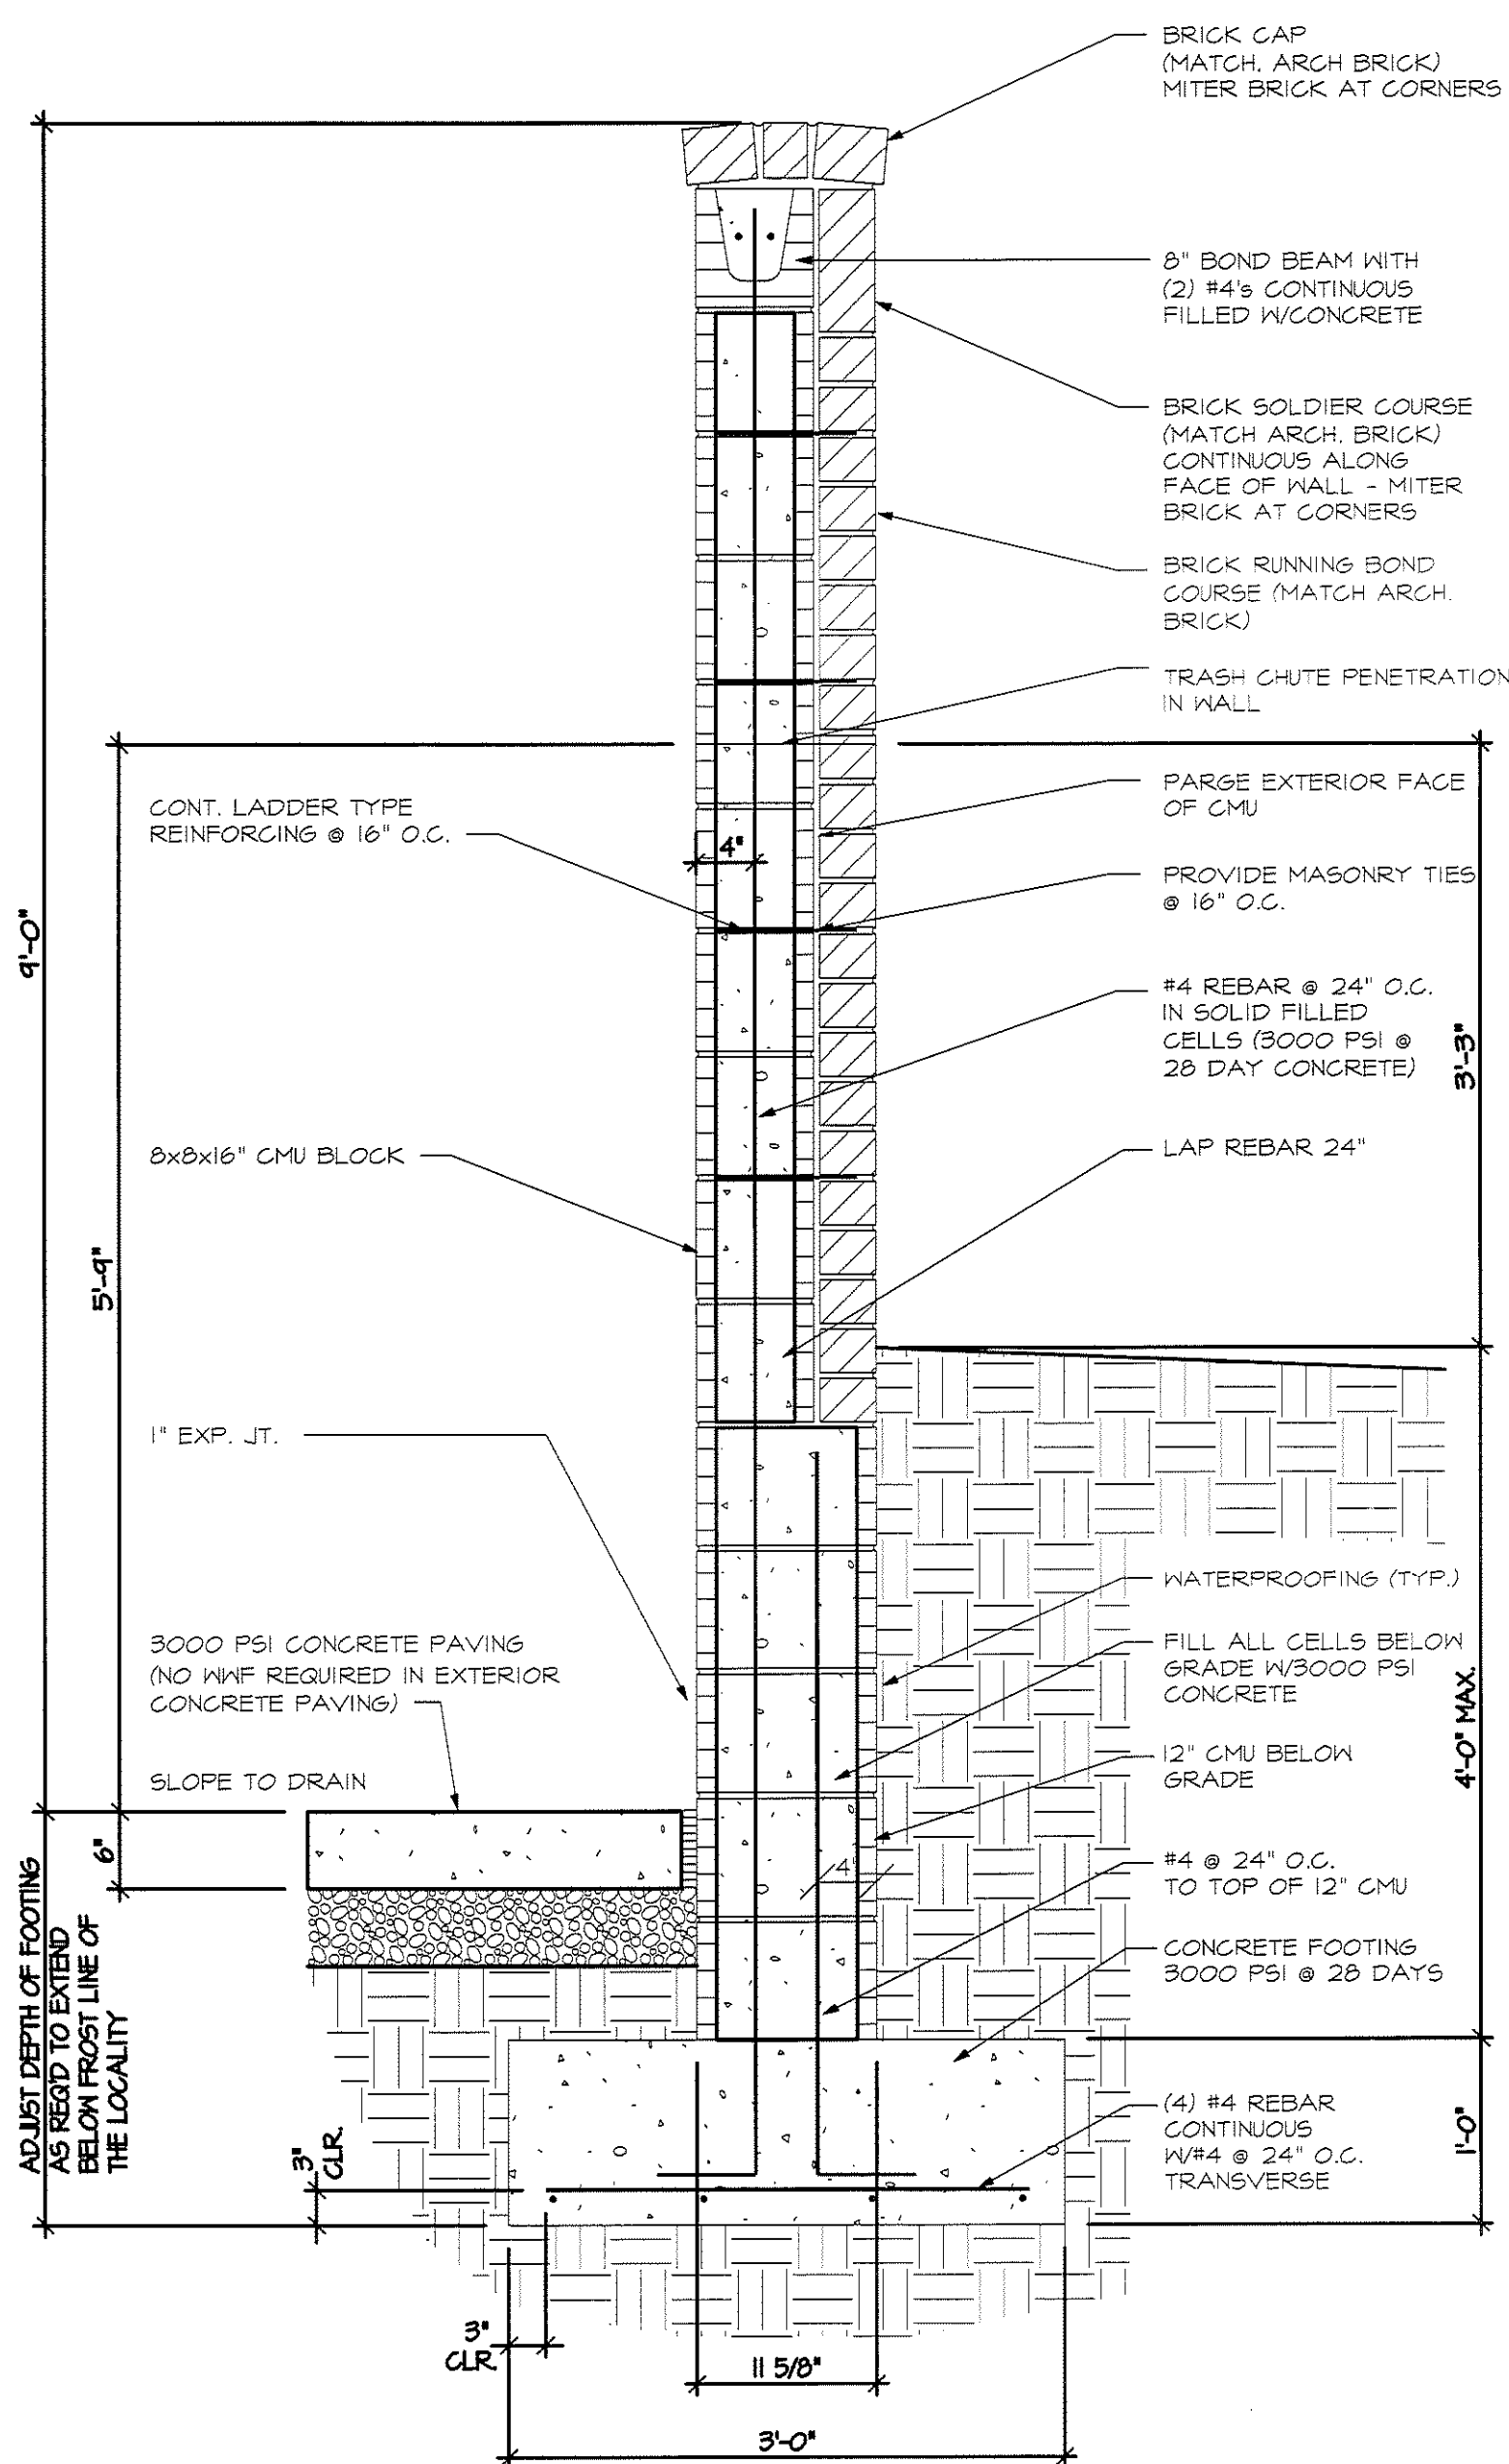

CROSS SECTION  
SCALE: 1" = 1'-0"

REVISIONS	
1	REV PER CITY COMMENTS 08-18-2015

ENGINEERING AND SURVEYING, INC.  
 4400 TRYING STREET  
 HIGH POINT, NORTH CAROLINA 27285  
 PHONE: (336) 312-8800 ~ FAX: (336) 312-8100

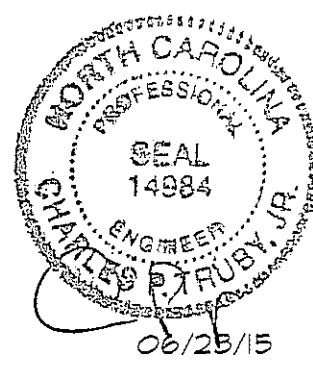

TRASH COMPACTOR PLAN & DETAILS  
 ANNEXE AT THE RESERVE  
 CITY OF WILMINGTON ~ WILMINGTON TOWNSHIP  
 NEA HANOVER COUNTY, NORTH CAROLINA

915 & 928 COVIL AVE.


TRASH COMPACTOR PLAN & DETAILS  
 SCALE: AS SHOWN  
 DATE: 03/17/15  
 PROJECT: 1140-12  
 DRAWN BY: TGL  
 SHEET C-13

CITY OF WILMINGTON  
 NORTH CAROLINA  
 Public Services • Engineering Division  
 APPROVED STORMWATER MANAGEMENT PLAN  
 Date: \_\_\_\_\_ Permit # \_\_\_\_\_  
 Signed: \_\_\_\_\_

Approved Construction Plan  
 Name: \_\_\_\_\_ Date: \_\_\_\_\_  
 Planning: \_\_\_\_\_  
 Traffic: \_\_\_\_\_  
 Fire: \_\_\_\_\_








Jun 23, 2015 5:41 PM Project: 1140-12-DWS\1140-12-213 Trash-Compactor.dwg Tab Name: Layout1



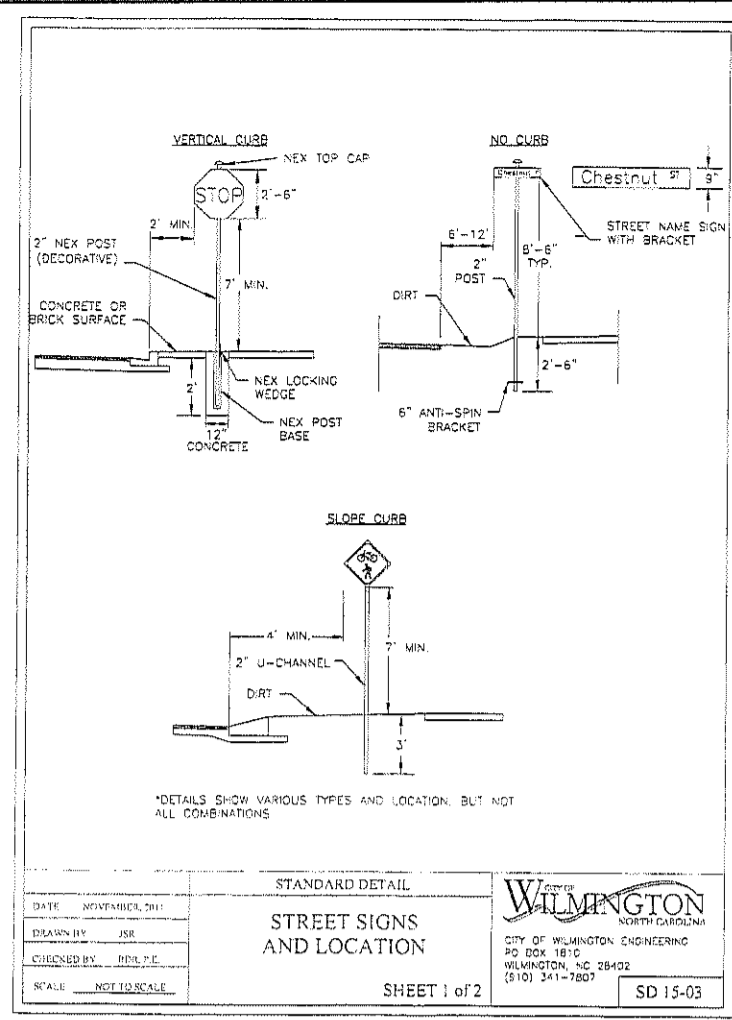


**SIGNS**

- All signs shall meet the requirements of MUTCD and City Traffic Engineering in effect at the time of construction.
- All Traffic Control Signs including advance warning shall be fabricated with 0.060 inch aluminum sheets using high quality pressure sensitive adhesive Type IV or better. STOP signs shall be a minimum of 30" x 30".
- SPECIAL DESIGNATION signs by location type shall adhere to City of Wilmington sign plan (i.e. downtown, historic, cross-city, parks, riverfront, scenic byway, parking, etc.) as referenced herein.
- POST MOUNTED STREET NAME SIGNS shall be fabricated with 1/8" extruded aluminum sheet name sign blanks using a standard sign blank. Minimum sign length is 18" and increasing in 6" increments to 24" maximum as dictated by the number of letters in the name. The color scheme shall be white letters on a green background without a border. Generally, the downtown and historic areas are an exception in the City of Wilmington sign plan and the background shall be blue and colors as listed.
- Decorative sign posts shall consist of the NEX sign support system, 2" vertical slabs, 14 gauge, powder coated galvanized black and include cap, post, base and wedge.
- All other sign posts shall be uniform in size and color with approval from the City Signs and Marketing Engineer.
- OVERHEAD STREET NAME SIGNS shall be fabricated with 1/8" extruded aluminum sheet name sign blanks using a standard sign blank. Minimum sign length is 18" and increasing in 6" increments to 24" maximum as dictated by the number of letters in the name. The color scheme shall be white letters on a green background without a border. Generally, the downtown and historic areas are an exception in the City of Wilmington sign plan and the background shall be blue and colors as listed.
- All sign mounting, signs and posts shall adhere to the MUTCD in effect at the time of construction. Fabrication instructions shall be used on signs, 12" above of below when used as a sign blank. For maximum sign traffic response and other overhead support systems refer to the design plans for maximum sign length.
- Sign locations depend on the edge of road condition. Generally, signs shall be a minimum of 2' from face of vertical curb or from face of slope back curb, and 8' from edge of pavement without curb. Signs shall not be located more than 12' from any of these locations.
- Sign posts shall be located in the center of the road. Signs shall be located in the center of the road.
- Sign posts shall be located in the center of the road.
- Sign posts shall be located in the center of the road.

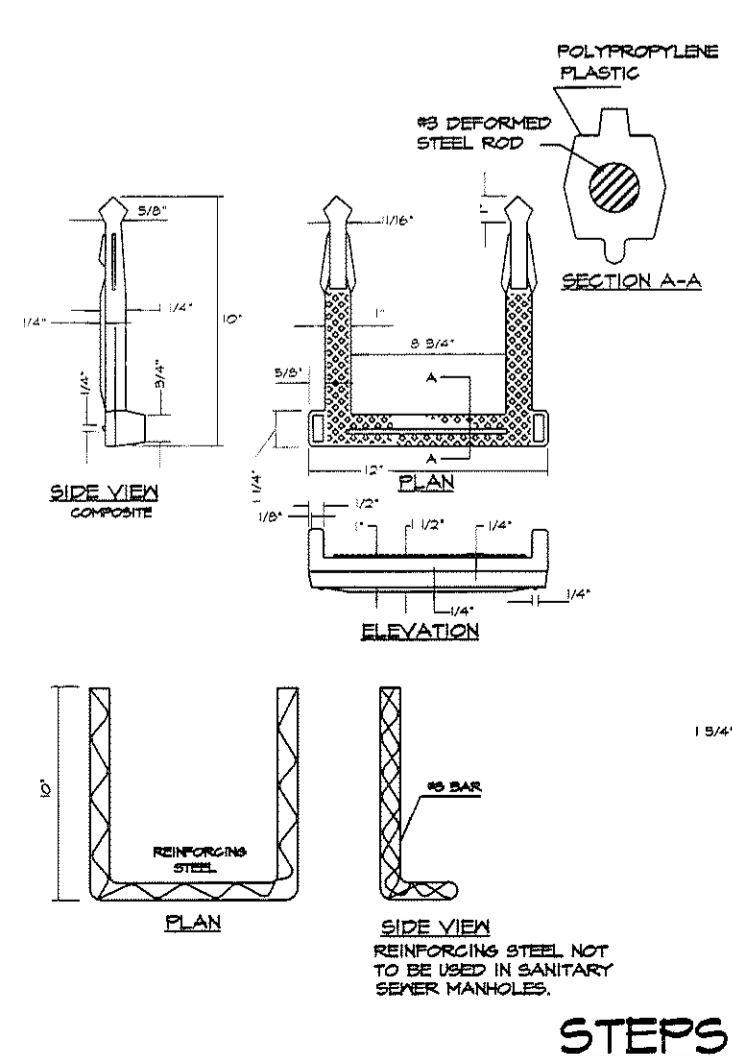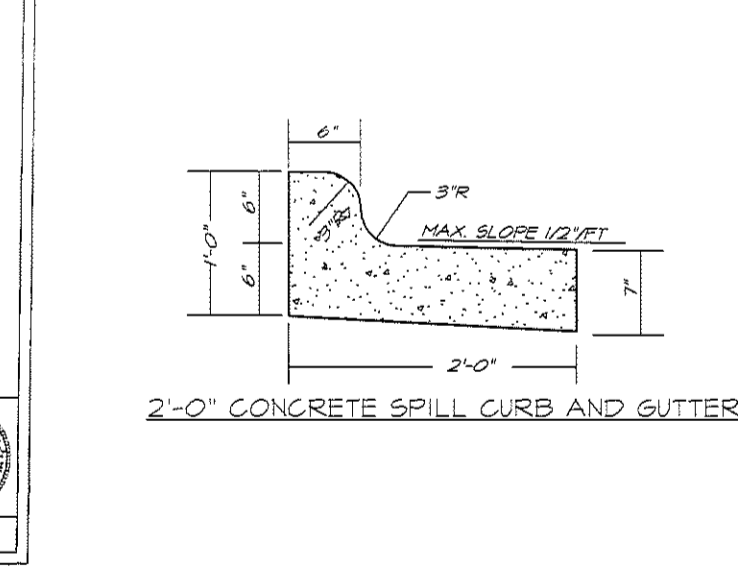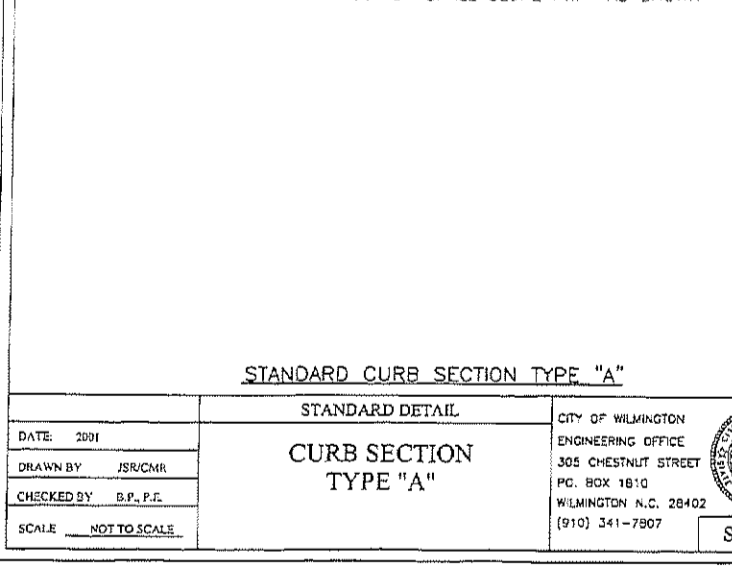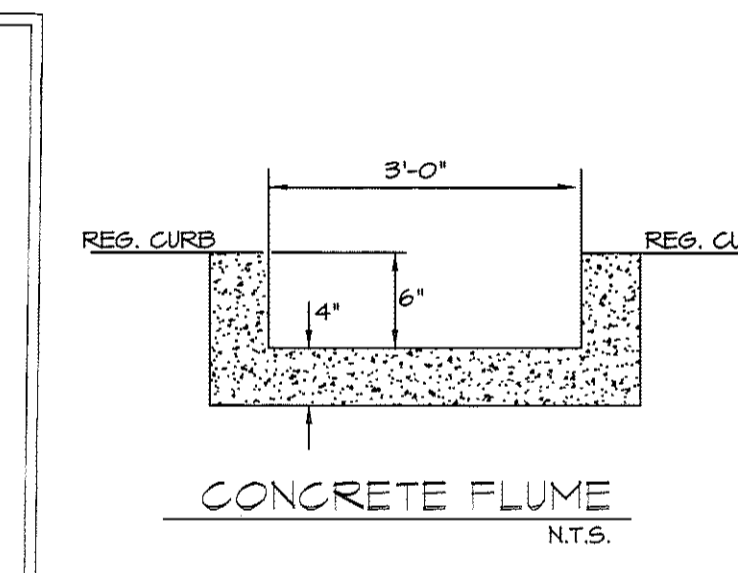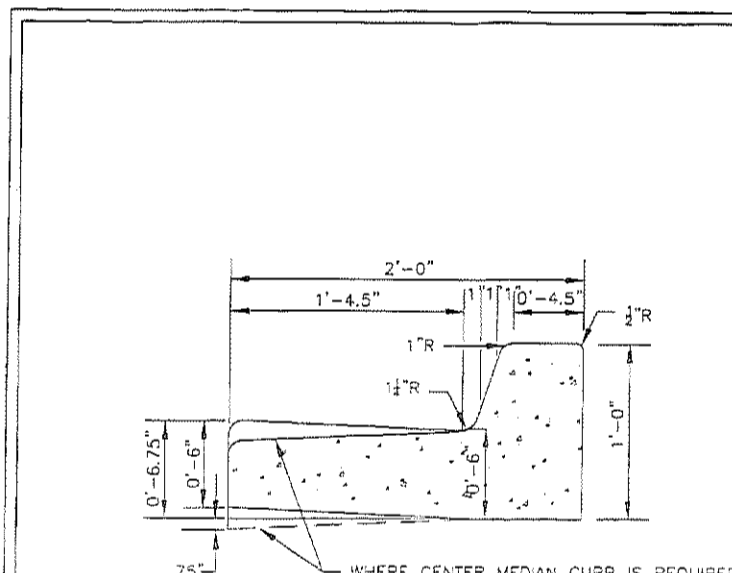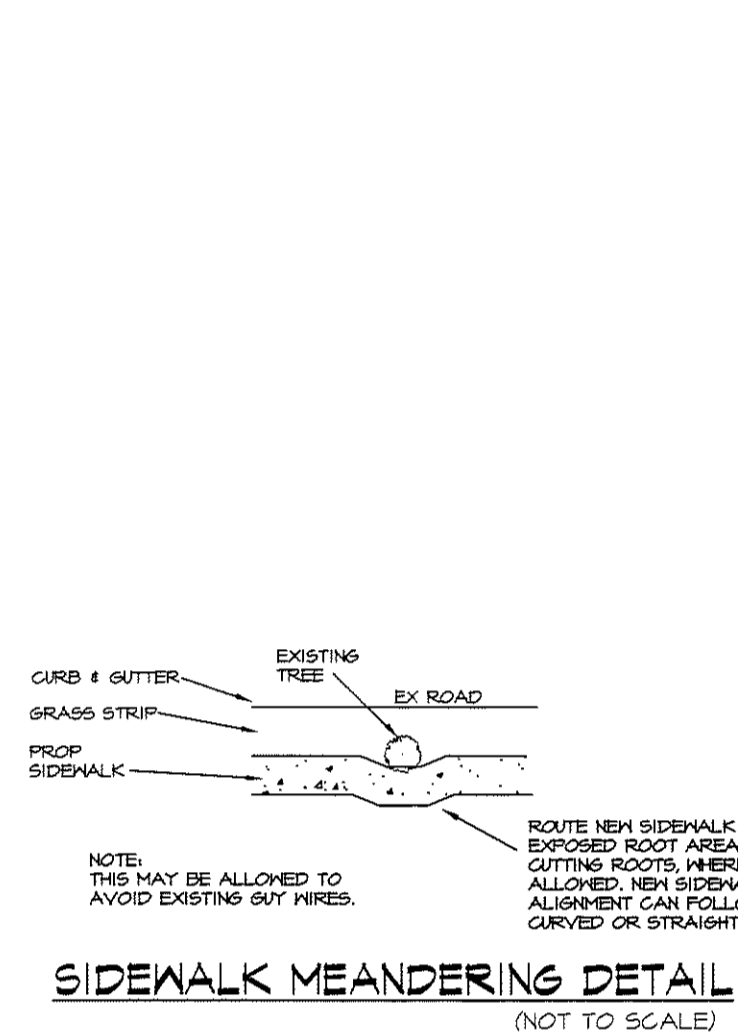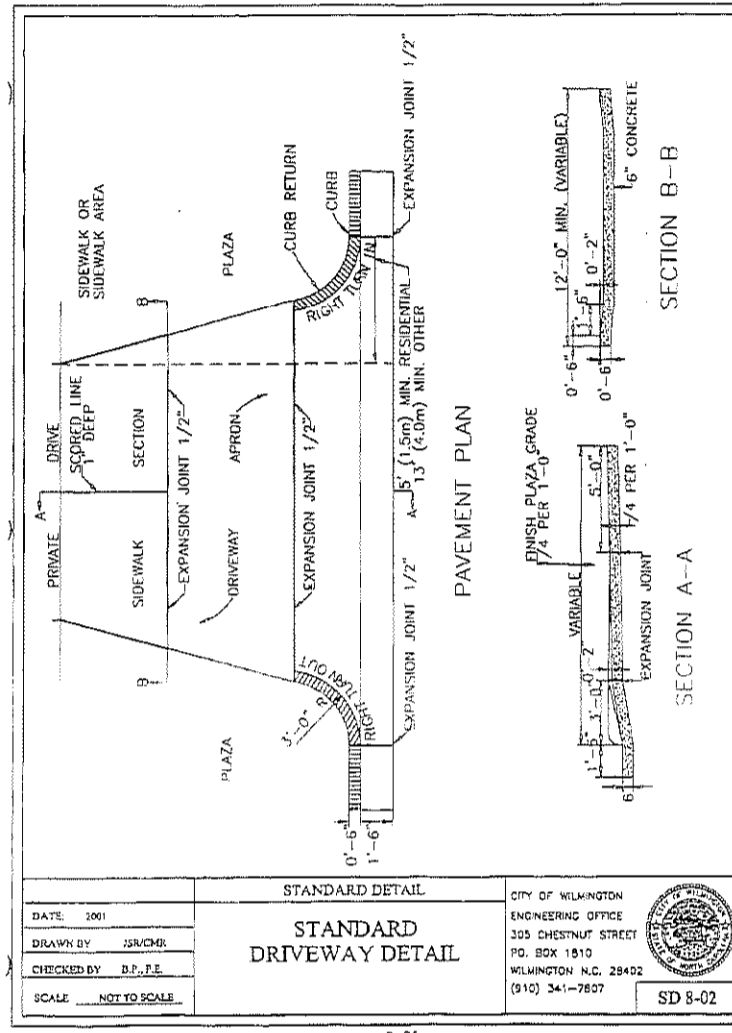

**STEPS**


- STEPS DIFFERING IN DIMENSIONS, CONFIGURATION OR MATERIALS FROM THOSE SHOWN MAY ALSO BE USED PROVIDED THE CONTRACTOR HAS FURNISHED DETAILS OF THE PROPOSED STEPS AND HAS RECEIVED WRITTEN APPROVAL FROM THE APPROPRIATE CITY/COUNTY ENGINEERING DEPARTMENT.
- ALL STEPS SHALL PROTRUDE 1/4" FROM INSIDE FACE OF STRUCTURE WALL.

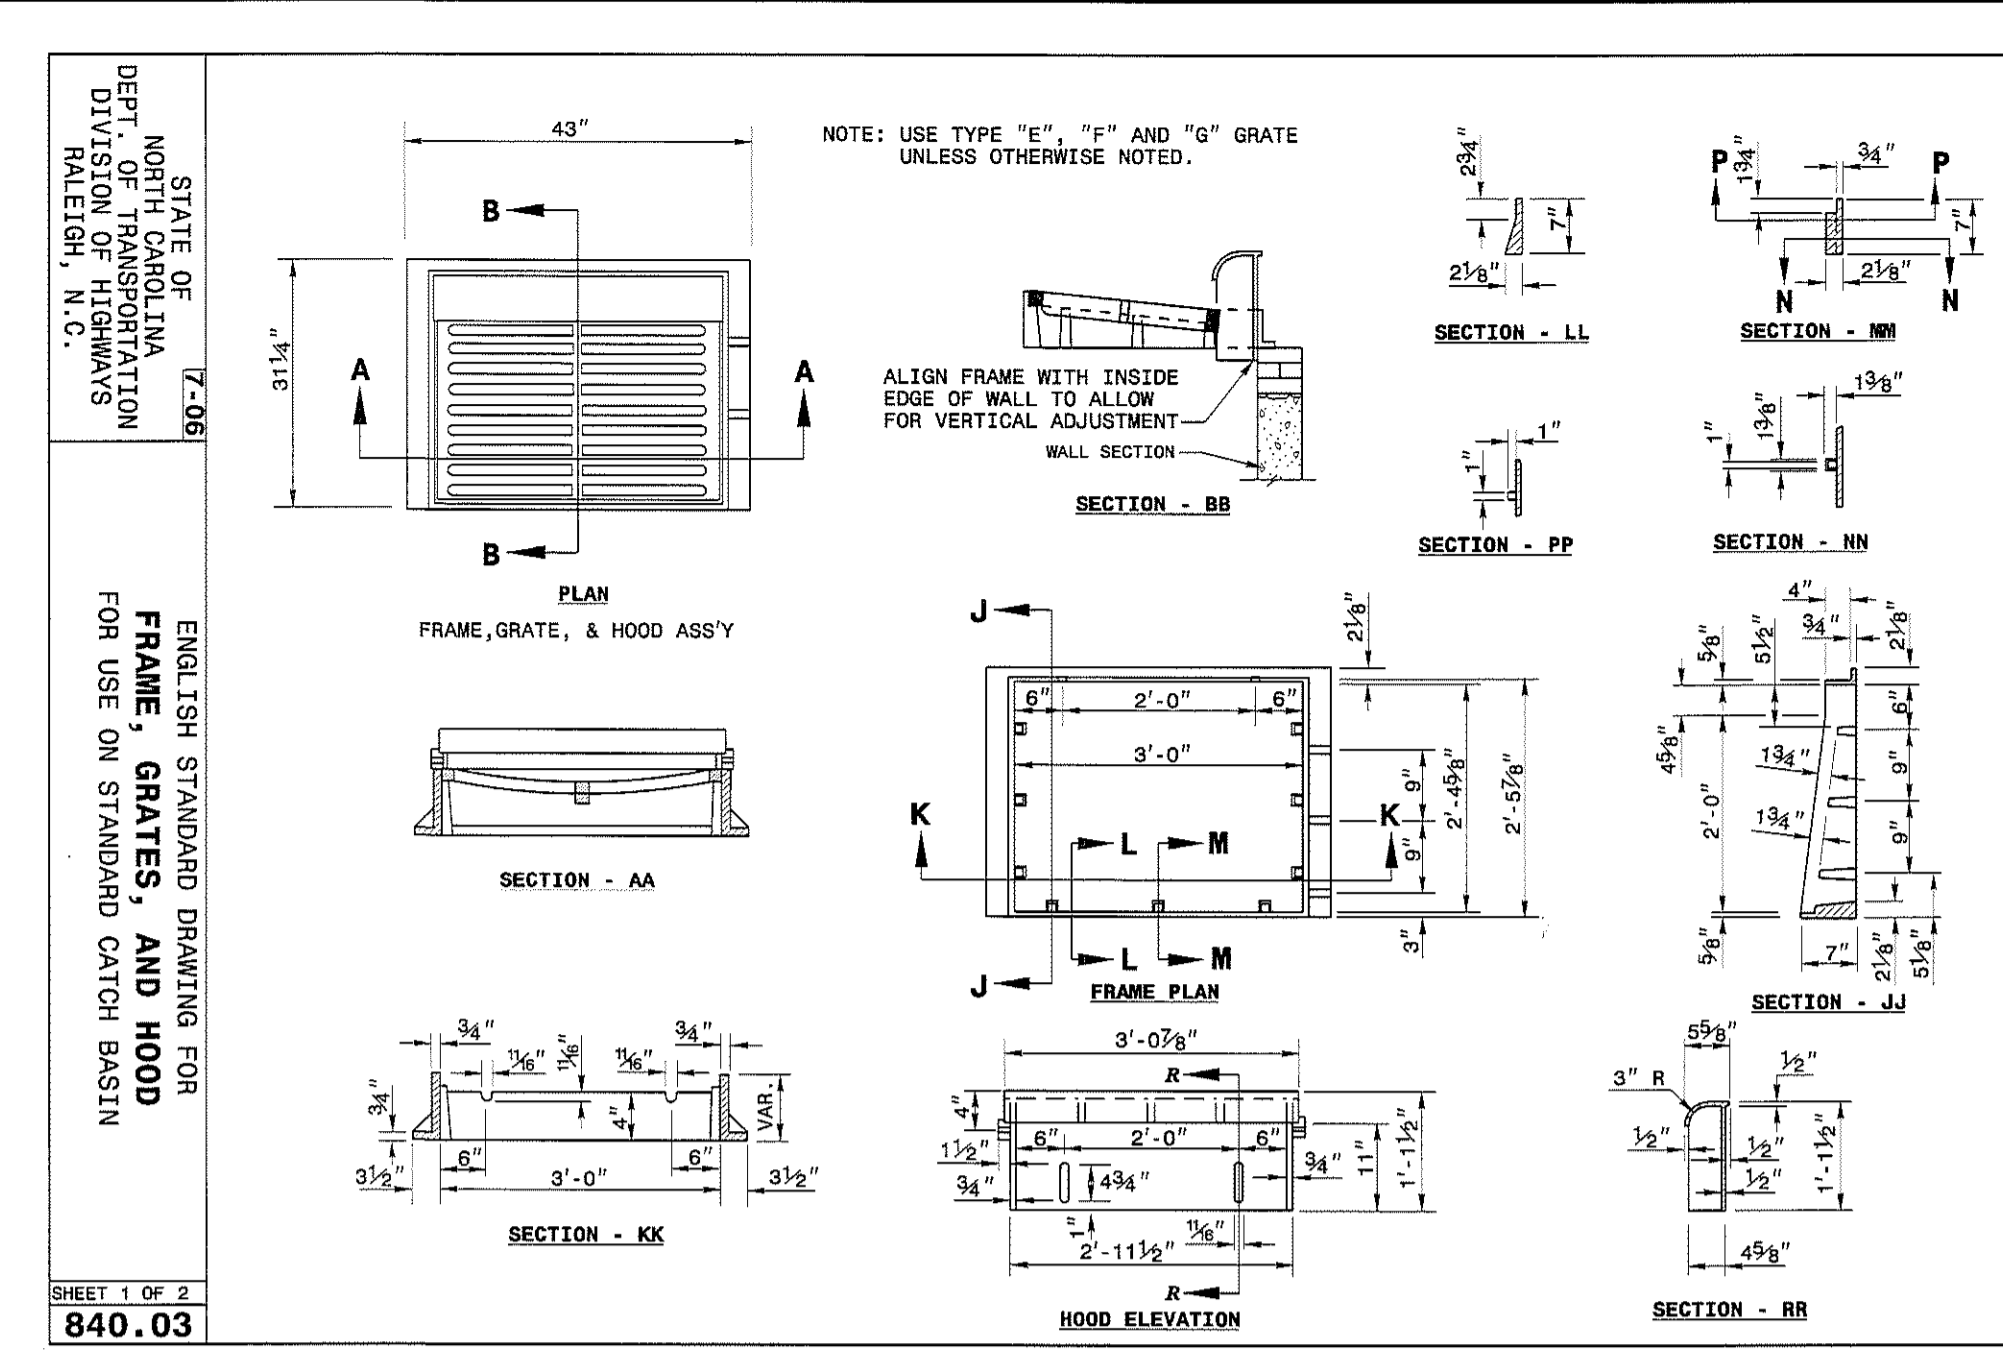

STATE OF NORTH CAROLINA  
DEPT. OF TRANSPORTATION  
DIVISION OF HIGHWAYS  
RALEIGH, N.C.

ENGLISH STANDARD DRAWING FOR  
FRAME, GRATES, AND HOOD  
FOR USE ON STANDARD CATCH BASIN


SHEET 1 OF 2  
840.03

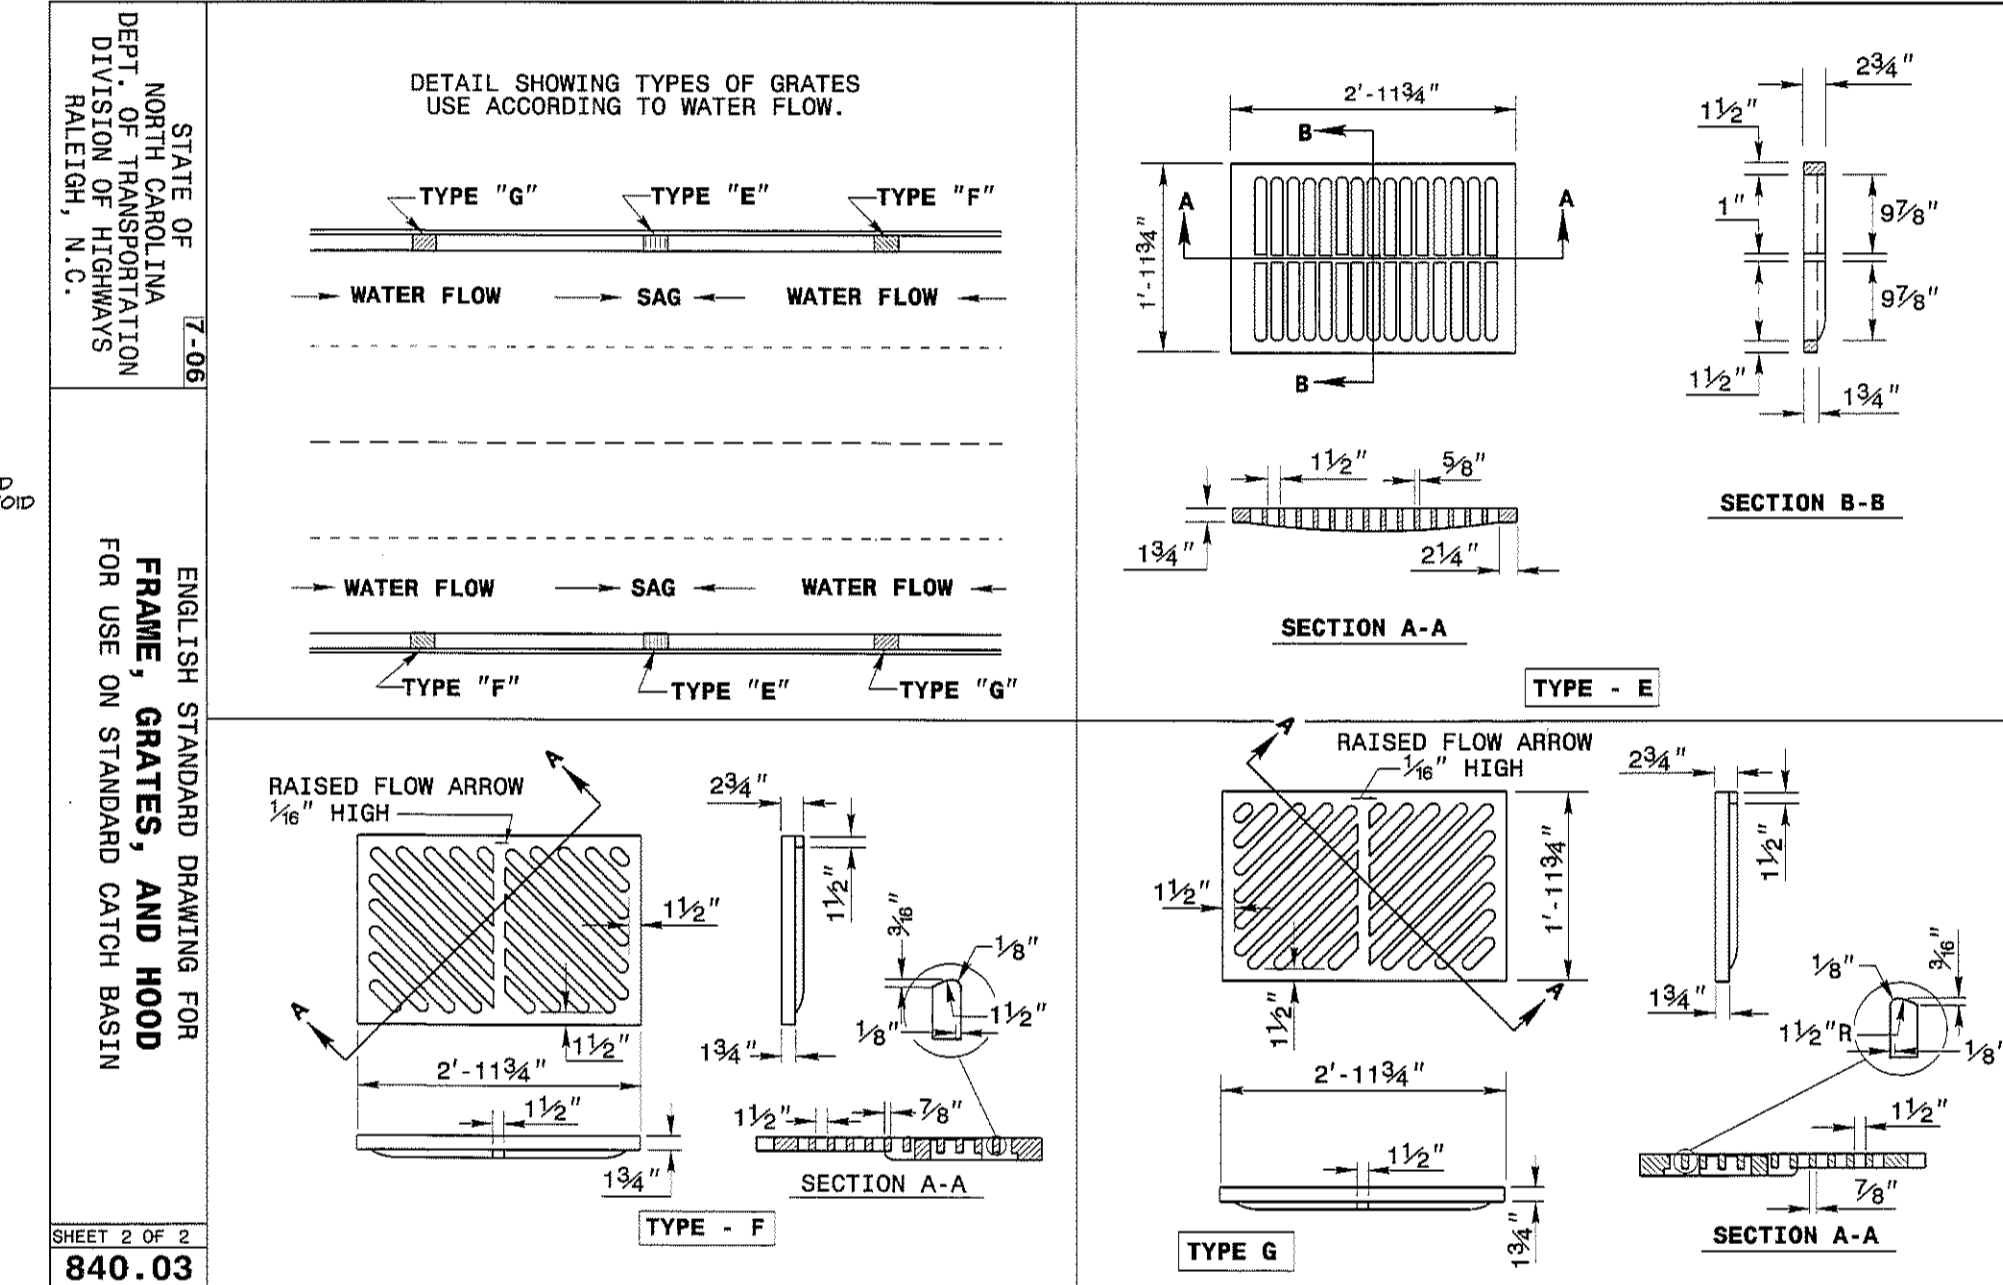

STATE OF NORTH CAROLINA  
DEPT. OF TRANSPORTATION  
DIVISION OF HIGHWAYS  
RALEIGH, N.C.

ENGLISH STANDARD DRAWING FOR  
FRAME, GRATES, AND HOOD  
FOR USE ON STANDARD CATCH BASIN


SHEET 2 OF 2  
840.03

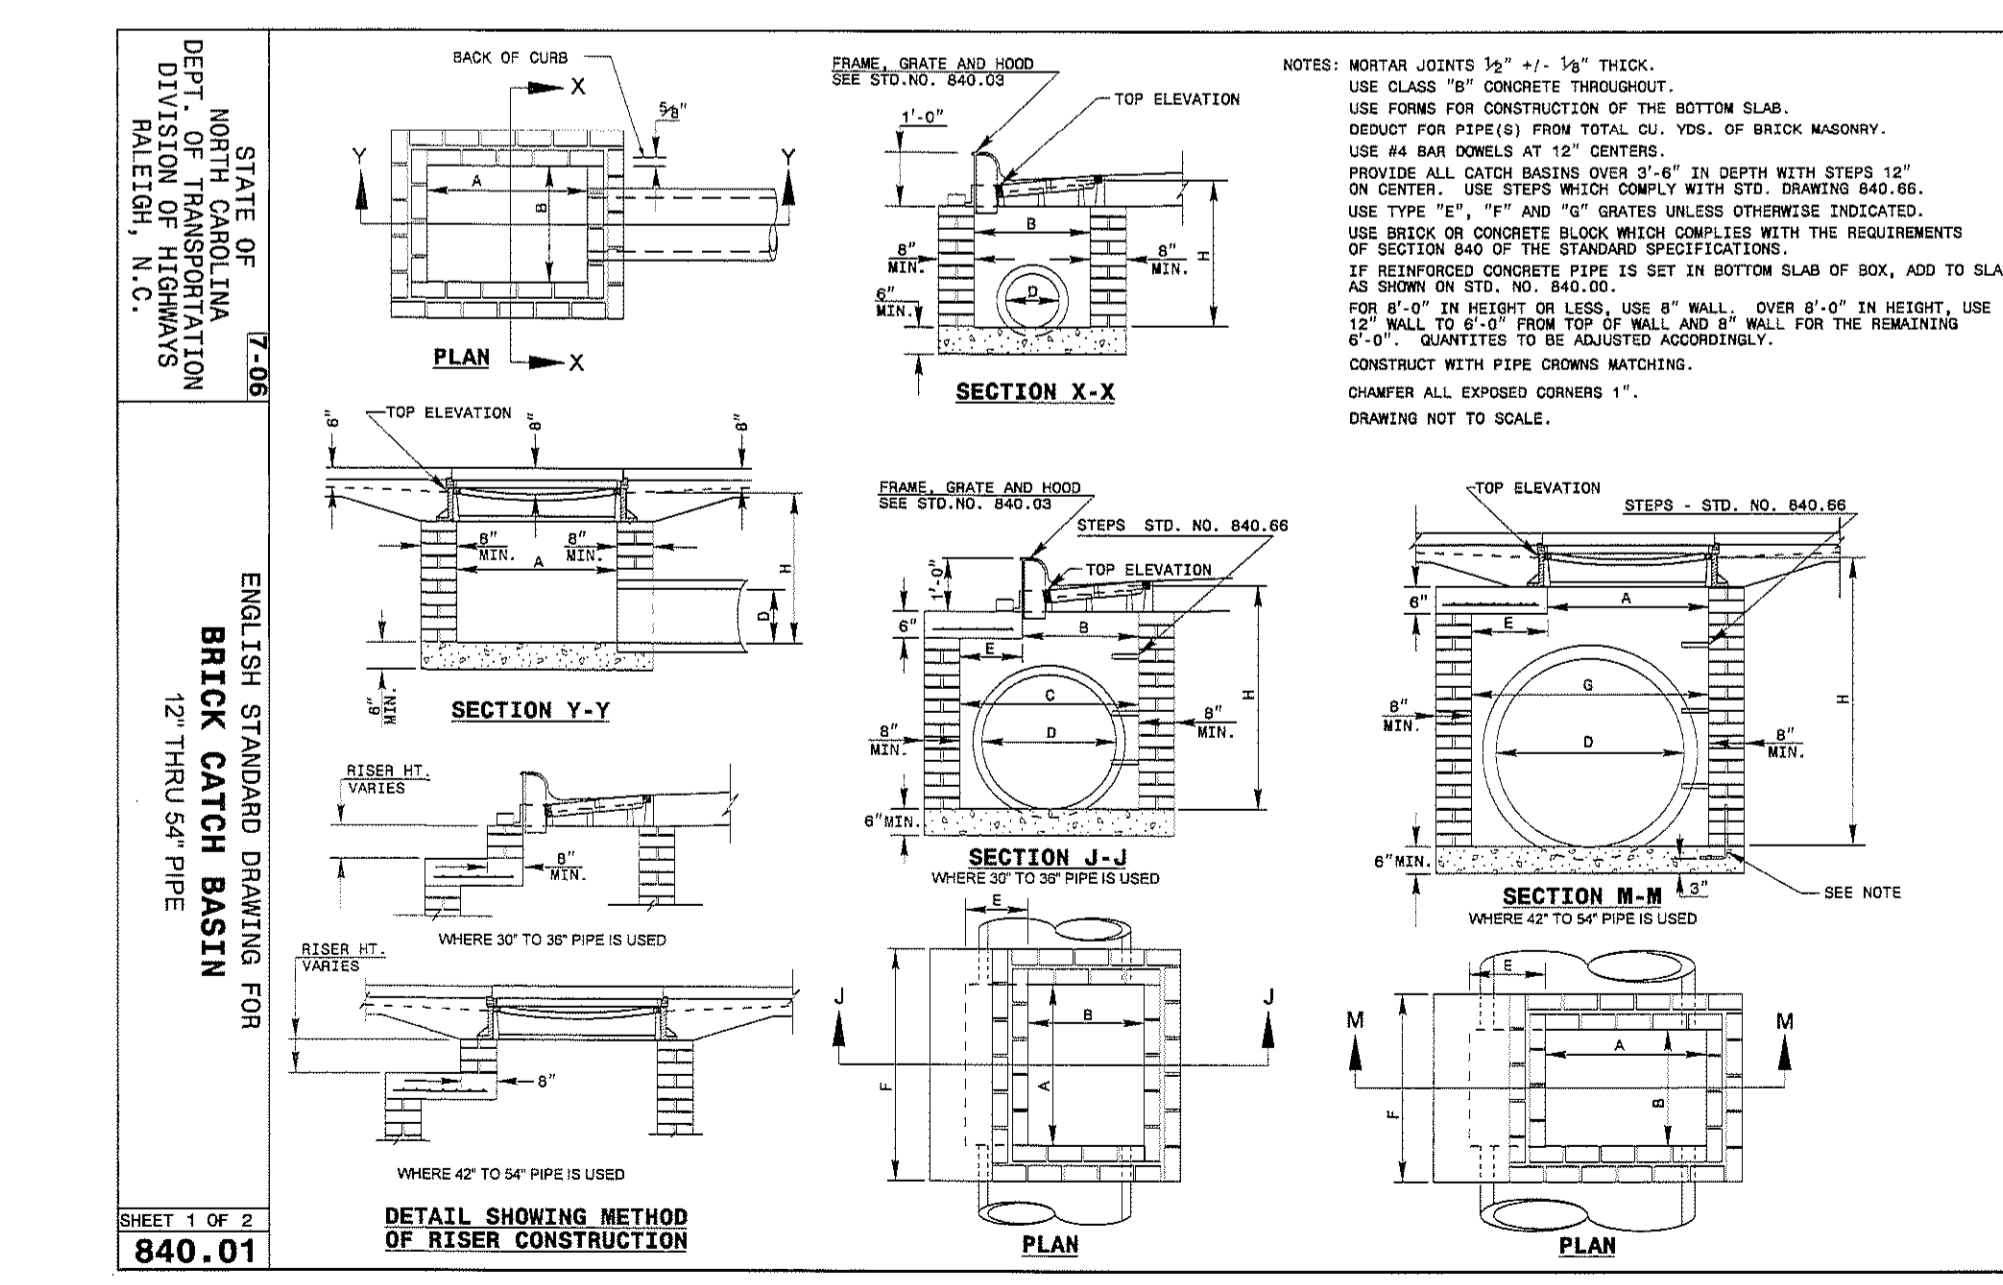

STATE OF NORTH CAROLINA  
DEPT. OF TRANSPORTATION  
DIVISION OF HIGHWAYS  
RALEIGH, N.C.

ENGLISH STANDARD DRAWING FOR  
BRICK CATCH BASIN  
12" THRU 54" PIPE


SHEET 1 OF 2  
840.01

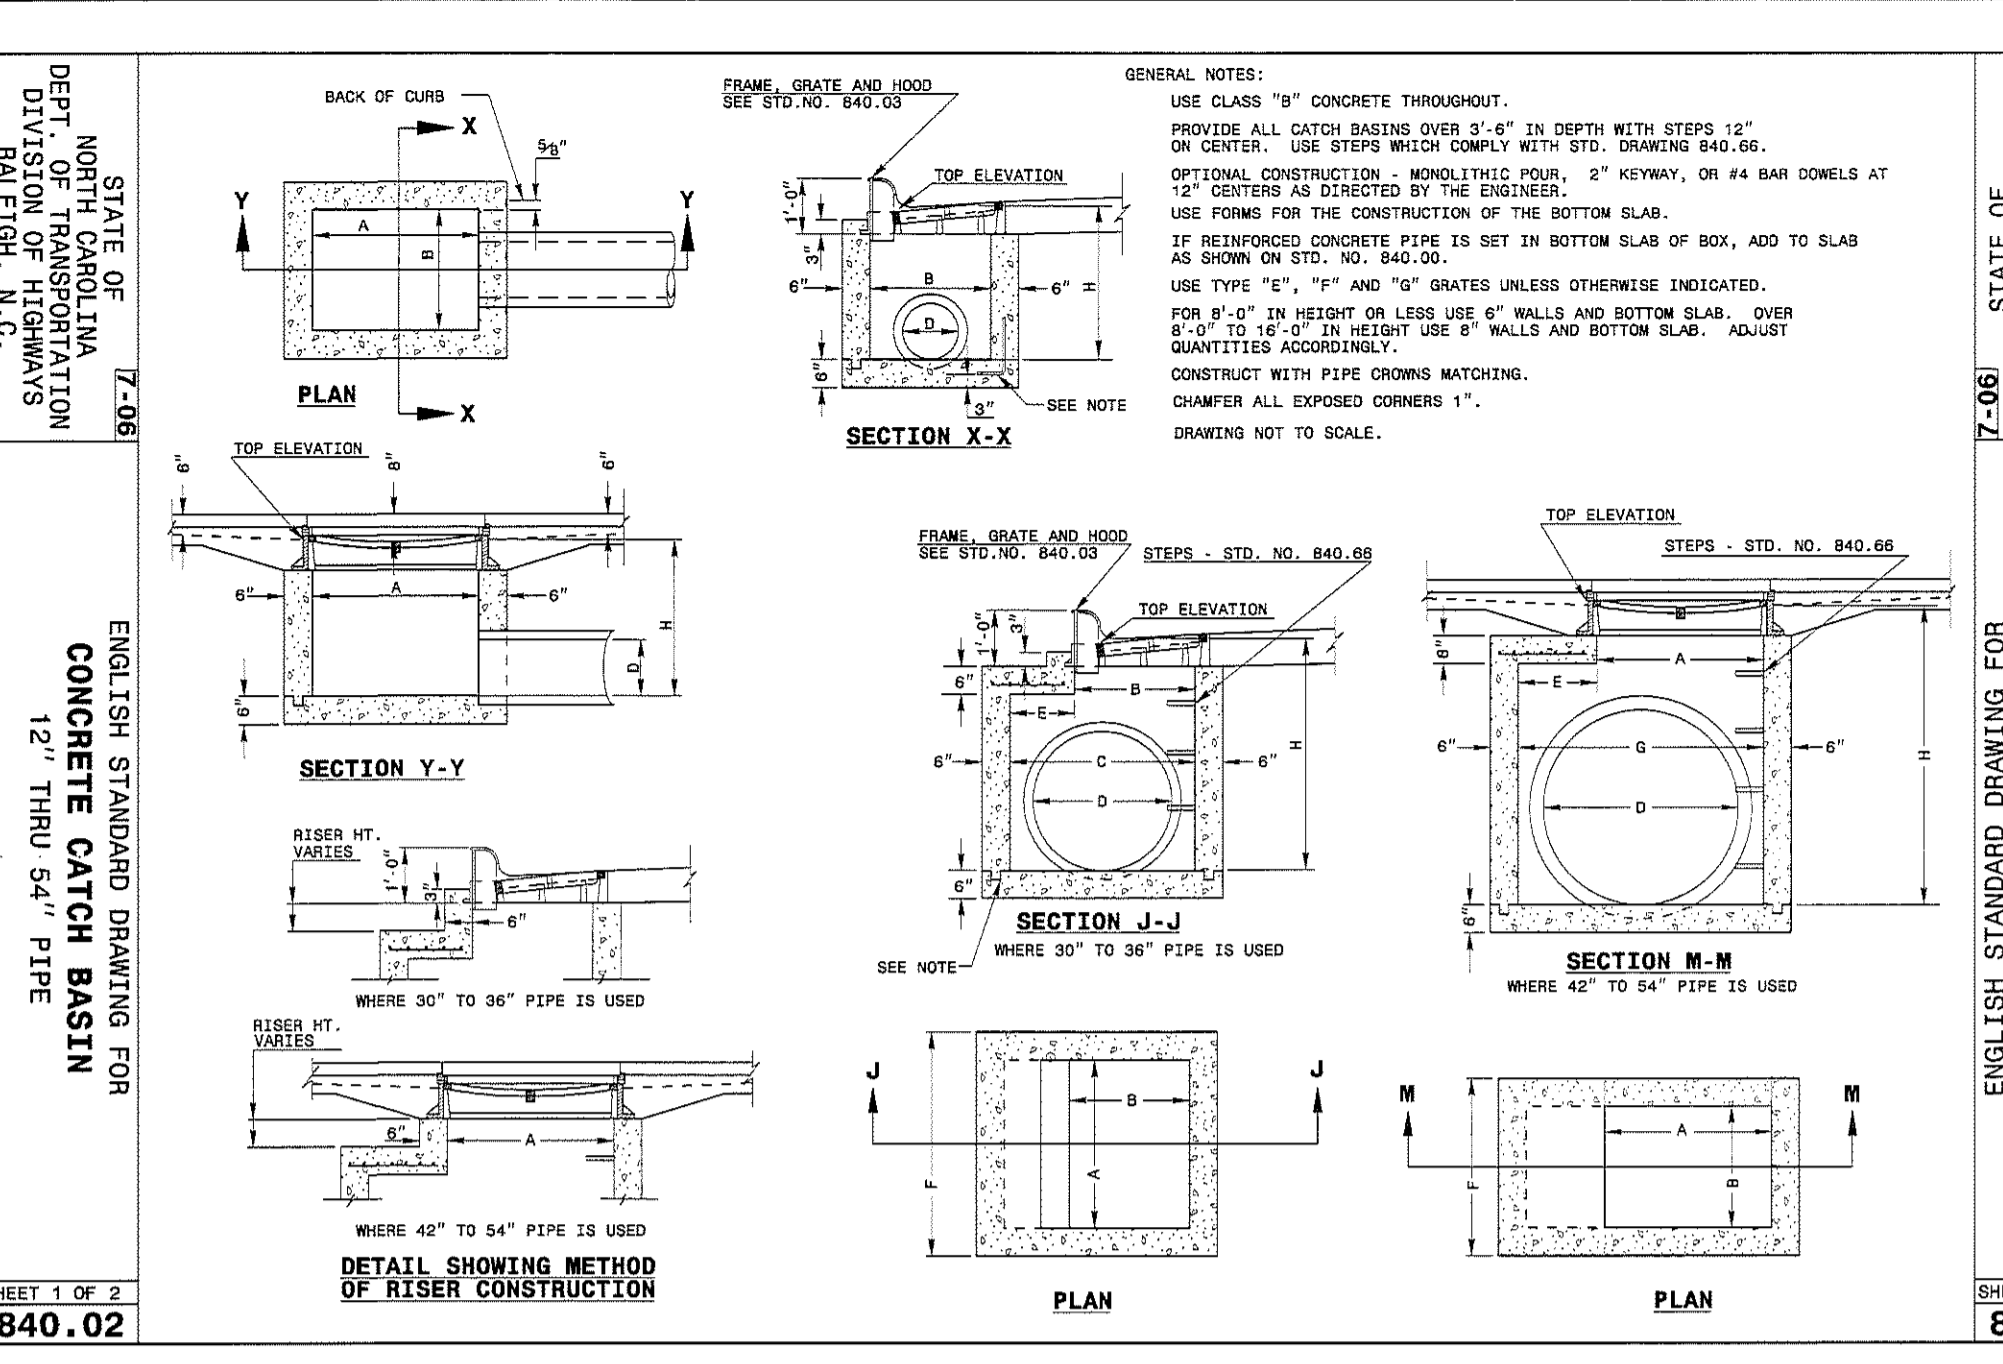

STATE OF NORTH CAROLINA  
DEPT. OF TRANSPORTATION  
DIVISION OF HIGHWAYS  
RALEIGH, N.C.

ENGLISH STANDARD DRAWING FOR  
CONCRETE CATCH BASIN  
12" THRU 54" PIPE


SHEET 1 OF 2  
840.02

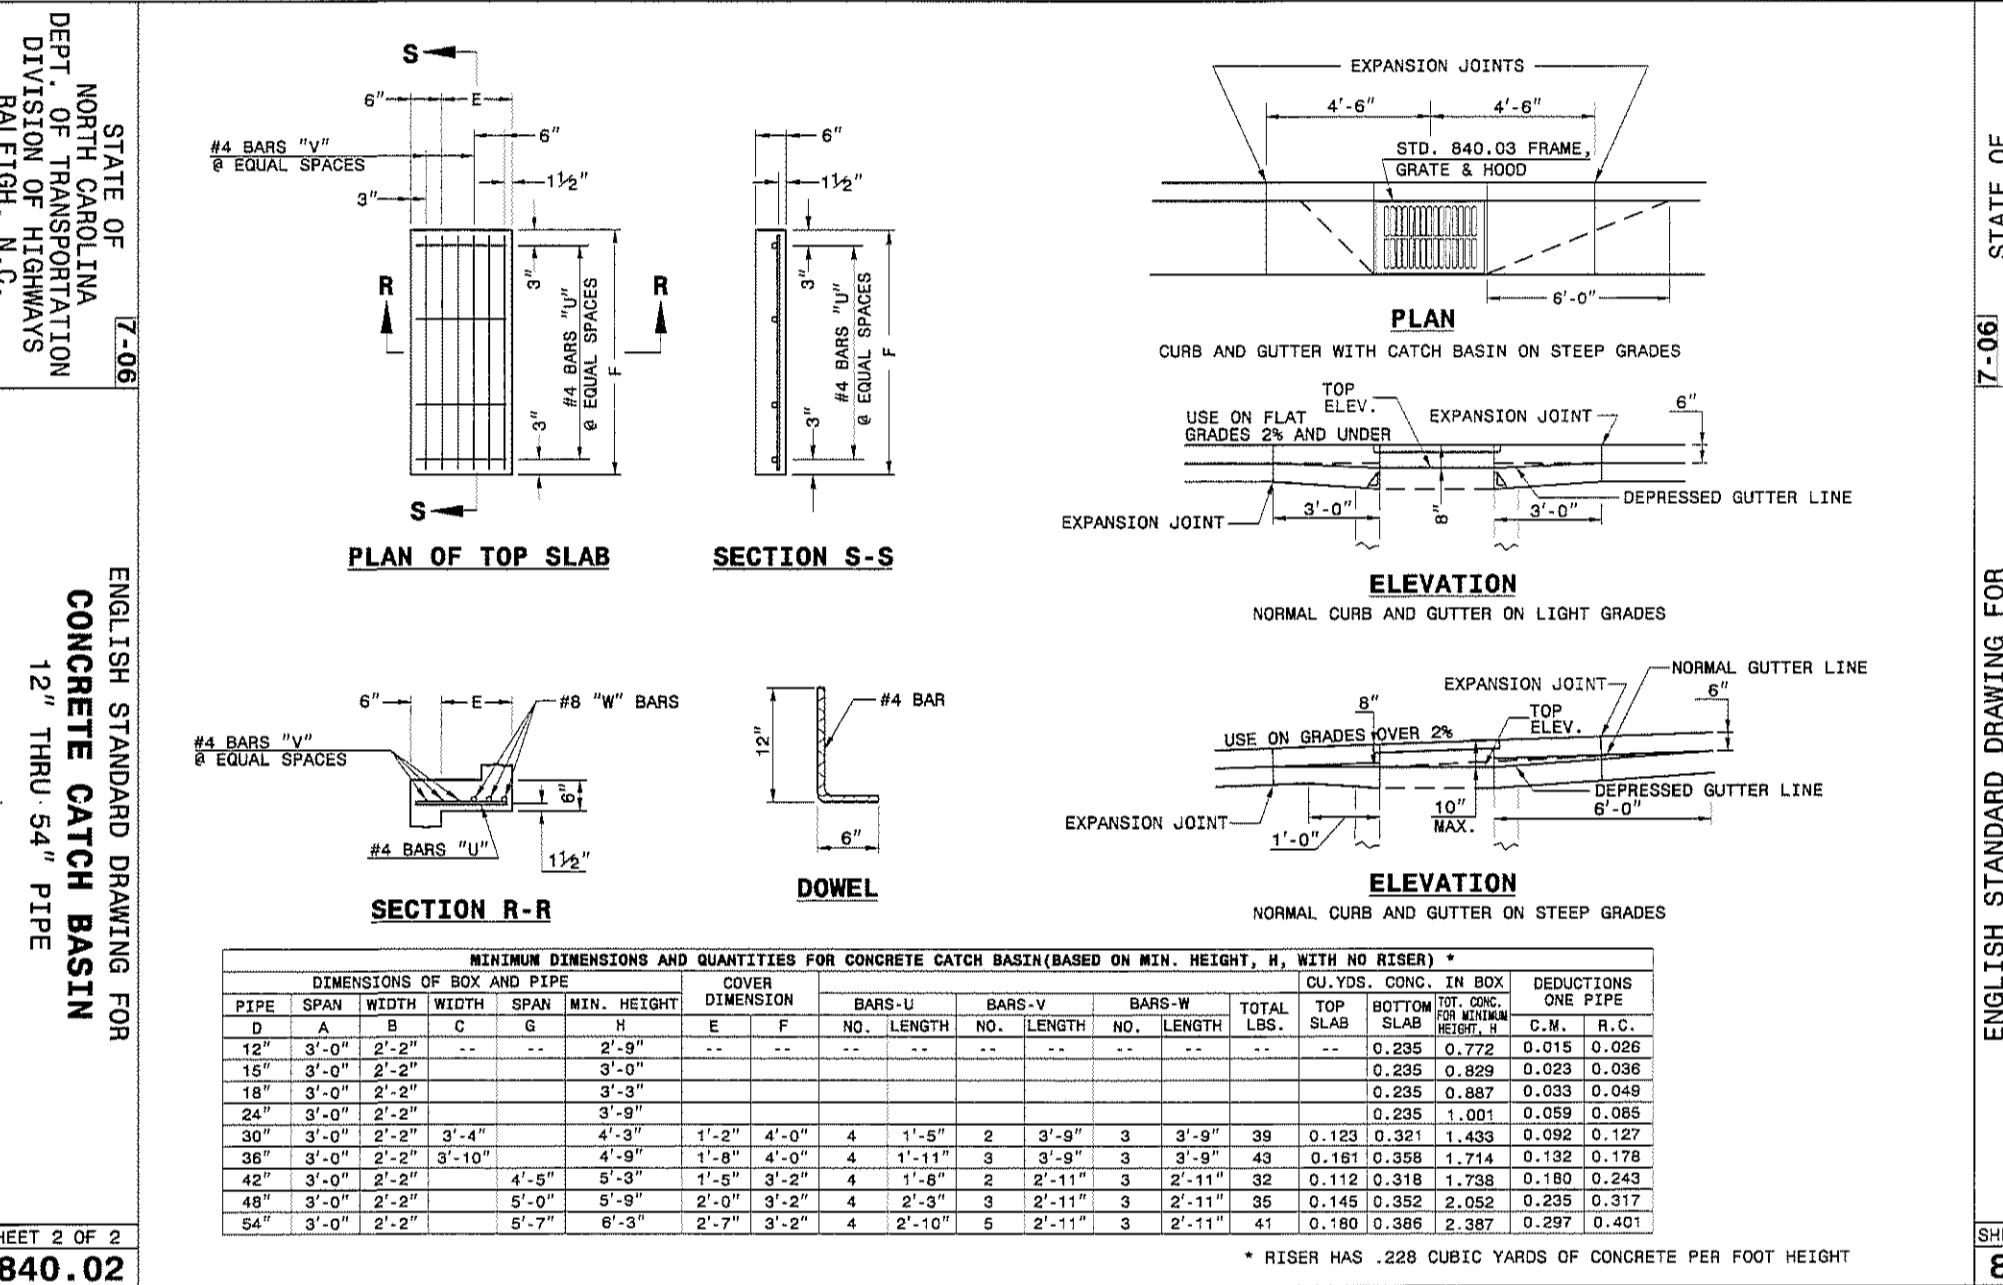

STATE OF NORTH CAROLINA  
DEPT. OF TRANSPORTATION  
DIVISION OF HIGHWAYS  
RALEIGH, N.C.

ENGLISH STANDARD DRAWING FOR  
CONCRETE CATCH BASIN  
12" THRU 54" PIPE

SHEET 2 OF 2  
840.02

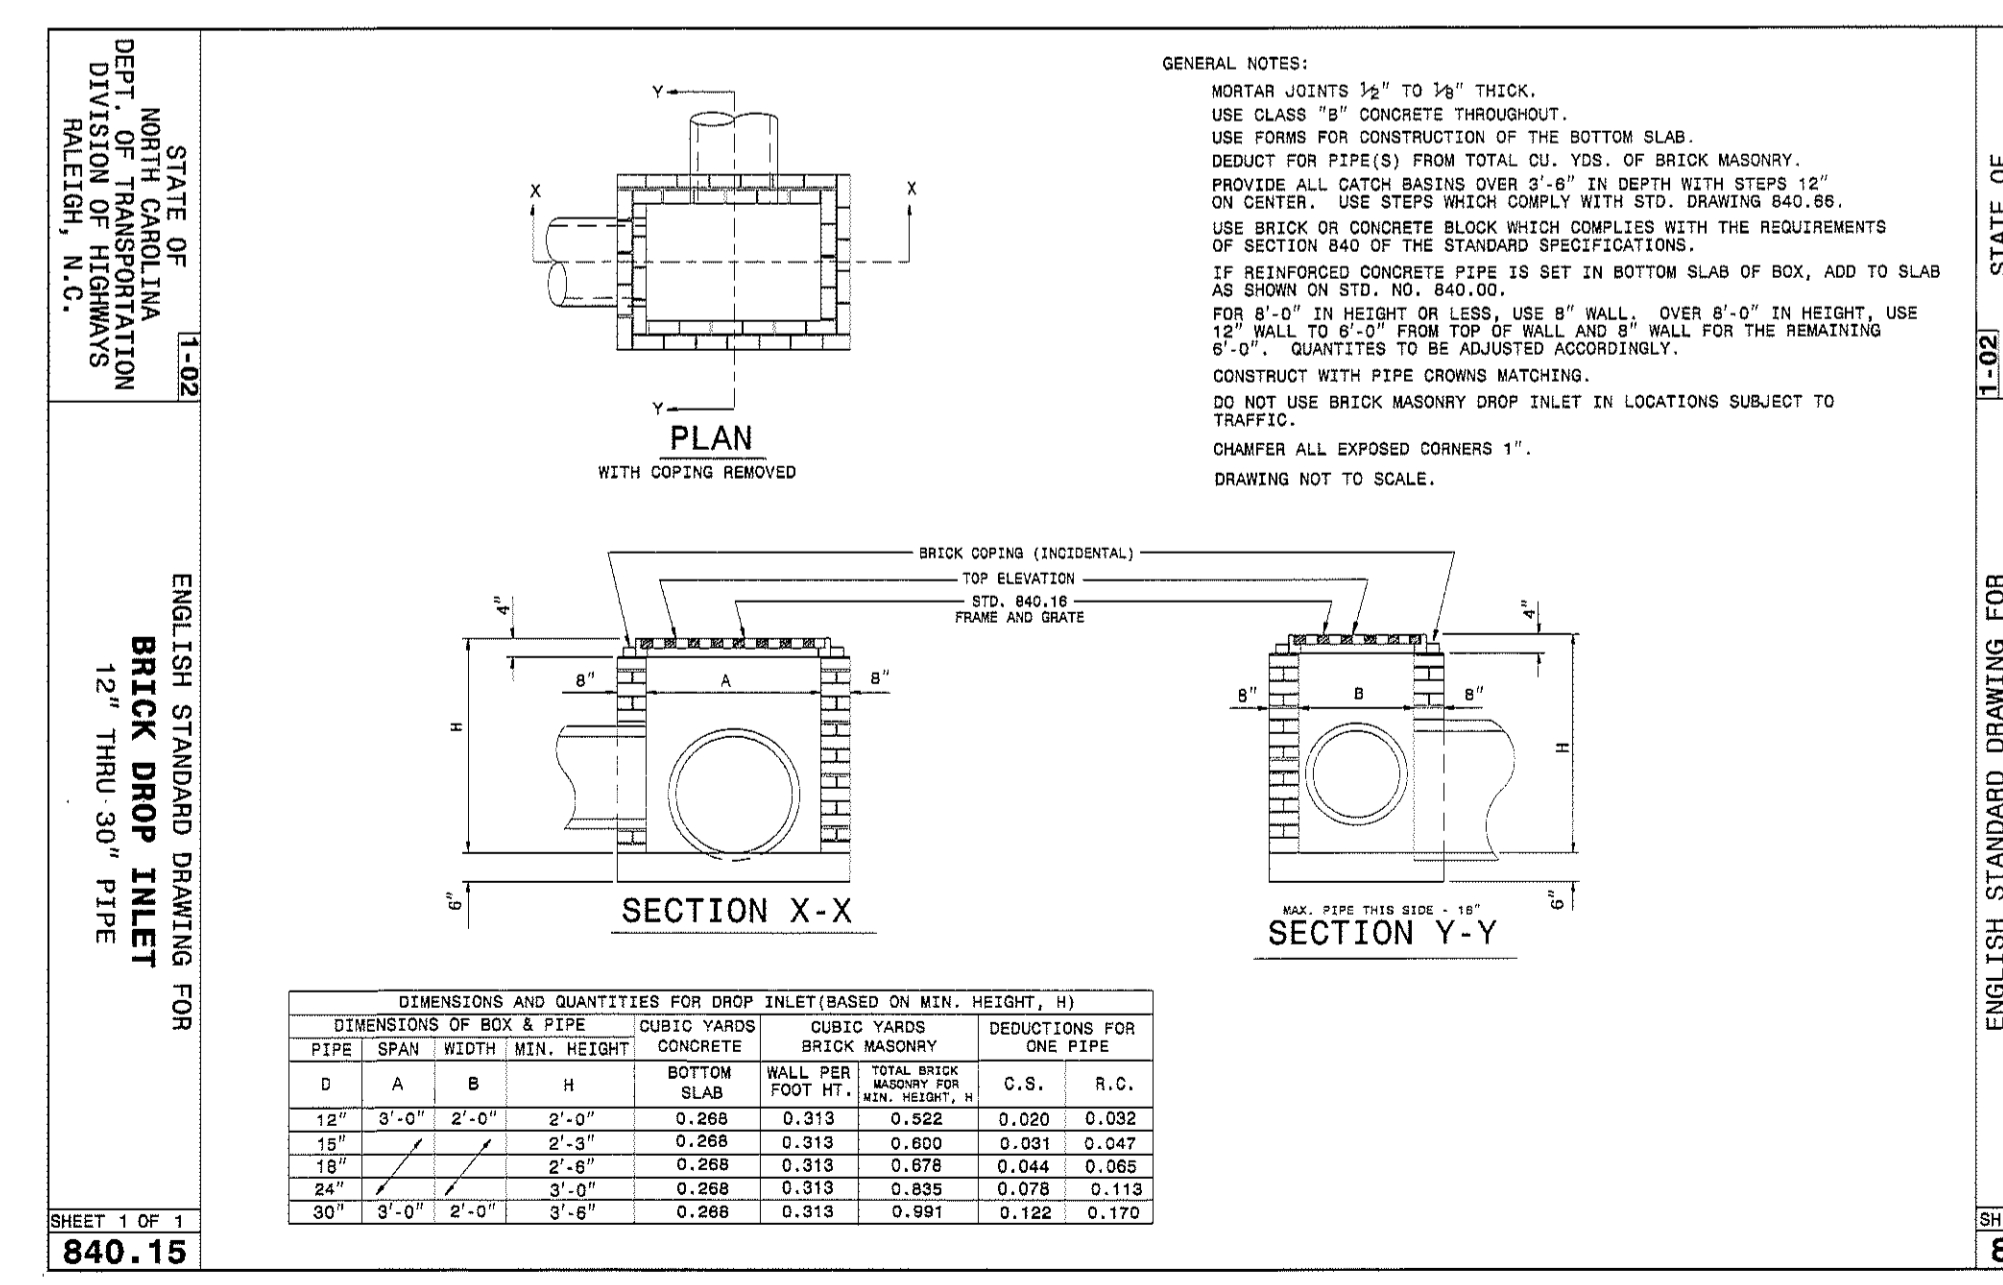

STATE OF NORTH CAROLINA  
DEPT. OF TRANSPORTATION  
DIVISION OF HIGHWAYS  
RALEIGH, N.C.

ENGLISH STANDARD DRAWING FOR  
BRICK DROP INLET  
12" THRU 30" PIPE

SHEET 1 OF 1  
840.15

APPROVED STORMWATER MANAGEMENT PLAN

Date: \_\_\_\_\_ Permit # \_\_\_\_\_

Signed: \_\_\_\_\_

**REVISIONS**

NO.	REV PER CITY COMMENTS	DATE
1	REV PER CITY COMMENTS	02-18-2015

**ENGINEERING AND SURVEYING, INC.**  
LAND DEVELOPMENT CONSULTING  
CORPORATE LICENSE NUMBER C-1375  
4400 TYNNIS STREET  
HIGH POINT, NORTH CAROLINA 27265  
PHONE: (936) 812-8800 ~ FAX: (936) 812-8700


**SEAL**  
14984  
ENGINEER  
G. STRUENY, JR.  
02/25/15

**SITE DETAILS**  
ANNEXE AT THE RESERVE  
CITY OF WILMINGTON ~ WILMINGTON TOWNSHIP  
NEW HANOVER COUNTY, NORTH CAROLINA


**SITE DETAILS**

SCALE: N.T.S.  
DATE: 03/17/15  
PROJECT: 1140-12  
DRAWN BY: TGL  
SHEET **D1**



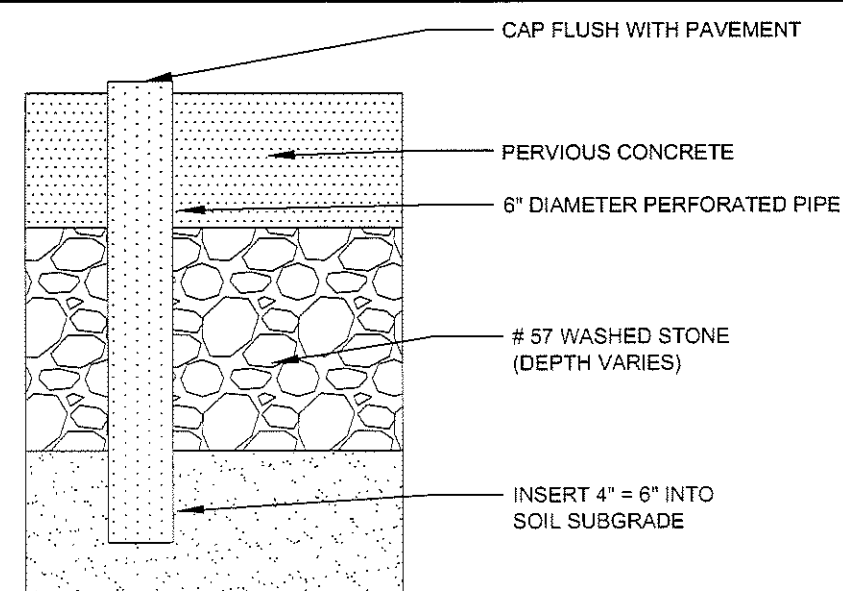

**OBSERVATION WELL DETAIL**

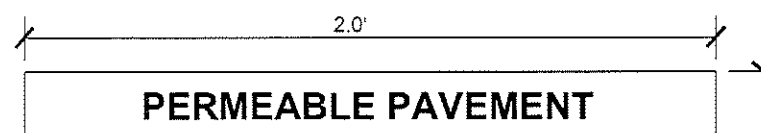

**ACTIVITIES PROHIBITED:**  
SANDING  
RE-SEALING  
RE-SURFACING  
POWER WASHING  
STORAGE OF MULCH OR SOIL  
STORAGE OF SNOW PILES  
STORAGE OF HEAVY LOADS

TO BE PLACED ON 4\"/>

**PERMEABLE PAVEMENT SIGN DETAIL**

**CONSTRUCTION STEP 5: PLACE GEOTEXTILES AND GEOMEMBRANE (IF APPLICABLE)**

IF THE SOILS ENGINEER REQUIRES USING GEOTEXTILES OR GEOMEMBRANES, THEN FOLLOW THE MANUFACTURER'S RECOMMENDATIONS SO FOR THE APPROPRIATE OVERLAP BETWEEN ROLLS OF MATERIAL. SECURE GEOTEXTILE OR GEOMEMBRANE SO THAT IT WILL NOT MOVE OR WRINKLE AS AGGREGATE IS PLACED.

**CONSTRUCTION STEP 6: PLACE OBSERVATION WELL(S)**

PLACE OBSERVATION WELLS ACCORDING TO THE DESIGN PLANS AND VERIFY THAT THE ELEVATIONS ARE CORRECT.

**CONSTRUCTION STEP 7: PLACE AGGREGATE BASE**

INSPECT ALL STONE TO INSURE THAT IT IS CLEAN, FREE OF FINES AND CONFORMS TO THE SPECIFICATIONS OF THE DESIGN PLANS. ALL AGGREGATES SHOULD BE STOCKPILED ON AN IMPERVIOUS SURFACE, A GEOTEXTILE OR OTHER IMPERVIOUS MATERIAL TO KEEP THE AGGREGATE FREE OF SEDIMENT. IF AGGREGATE BECOMES CONTAMINATED WITH SEDIMENT, THEN IT SHALL BE REPLACED WITH CLEAN MATERIALS. BEFORE PLACING THE AGGREGATE BASE, REMOVE ANY ACCUMULATION OF SEDIMENTS ON THE FINISHED SUBGRADE WITH LIGHT EQUIPMENT. IF THE EXCAVATED SUBGRADE SURFACE IS SUBJECTED TO RAINFALL BEFORE THE PLACEMENT OF THE AGGREGATE BASE, THE RESULTING SURFACE CRUST MUST BE EXCAVATED (TO AT LEAST AN ADDITIONAL TWO INCHES IN DEPTH), RAKED OR SCARIFIED TO BREAK UP THE CRUST. FOR SITES WITH AN IMPERVIOUS LNER OR GEOTEXTILES, REMOVE ANY ACCUMULATED SEDIMENTS AND CHECK THE PLACEMENT, SLOPES AND ELEVATIONS SHOULD BE CHECKED ON THE SOIL SUBGRADE AND THE FINAL BEDDING MATERIAL TO ASSURE THAT THEY CONFORM TO THE DESIGN SPECIFICATIONS.

ALL AGGREGATE SHOULD BE SPREAD (NOT DUMPED) BY A FRONT-END LOADER. MOISTEN AND SPREAD SIX INCH LIFTS OF THE WASHED STONE WITHOUT DRIVING ON THE SUBGRADE AND BEING CAREFUL NOT TO DAMAGE UNDERDRAINS AND THEIR FITTINGS. CATCH BASINS, OR OBSERVATION WELLS. THE AGGREGATE LAYER SHOULD BE LIGHTLY COMPACTED.

**CONSTRUCTION STEP 8: INSTALL CURB RESTRAINTS AND PAVEMENT BARRIERS**

EDGE RESTRAINTS AND BARRIERS BETWEEN PERMEABLE AND IMPERVIOUS PAVEMENT SHALL BE INSTALLED PER DESIGN. BEFORE MOVING ON TO CONSTRUCTION STEP 9, BE CERTAIN THAT THE DESIGN AND INSTALLATION ARE CONSISTENT.

**CONSTRUCTION STEP 9: INSTALL BEDDING AND PAVEMENT COURSES**

PC PAVEMENTS SHALL BE CONSTRUCTED IN ACCORDANCE WITH THE LATEST VERSION OF ACI 522.1 SPECIFICATION FOR PEROUS CONCRETE. IT IS REQUIRED THAT THE CONTRACTOR INSTALLING THE PEROUS CONCRETE MEET THE REQUIREMENTS OUTLINED IN THE LATEST VERSION OF ACI 522.1. INSTALLATION OF PC CAN BE ACCOMPLISHED USING EITHER THE ONE-STEP OR THE TWO-STEP METHOD. THE TWO-STEP METHOD IS THE MORE TRADITIONAL METHOD AND UTILIZES SEPARATE STEPS TO STRIKE-OFF THEN COMPACT THE PEROUS CONCRETE. IN THIS METHOD, THE PEROUS CONCRETE WILL USUALLY REQUIRE A SLUMP OF APPROXIMATELY 1-3 INCHES. THE ONE-STEP METHOD USES A COUNTER-ROTATING ROLLER SCREED TO BOTH STRIKE-OFF AND COMPACT THE PEROUS CONCRETE IN ONE STEP. THIS METHOD REQUIRES THE USE OF A PEROUS CONCRETE WITH A SLUMP IN THE RANGE OF 4-8 INCHES. IN THE CASE OF EITHER METHOD, THE USE OF DENSE-PASTE PEROUS CONCRETE MIXTURES IS REQUIRED. THESE MIXES ARE DEFINED BY THE USE OF CHEMICAL ADMIXTURES WHICH MODIFY THE VISCOSITY OF THE CEMENT PASTE TO A CONSISTENCY THAT WILL NOT RUN OFF OF THE AGGREGATE, BUT "STICK" TO THE AGGREGATE. THESE MIXES PROVIDE MORE COHESIVITY WHICH INCREASES STRENGTH AND DURABILITY. PC MIXES SHOULD ALSO INCLUDE A HYDRATION STABILIZER BUT SHALL BE REQUIRED TO INCLUDE A HYDRATION STABILIZER WHEN THE AMBIENT TEMPERATURE EXCEEDS 90 DEGREES F.

**CONSTRUCTION STEP 10: PROTECT THE PAVEMENT THROUGH PROJECT COMPLETION**



THE PERMEABLE PAVEMENT SHALL BE INSTALLED AT THE END OF THE SITE CONSTRUCTION TIMELINE. THE CONTRACTOR MUST PROTECT THE PERMEABLE PAVEMENT THROUGH PROJECT COMPLETION. THIS MUST BE DONE BY:  
- ROUTE CONSTRUCTION ACCESS THROUGH OTHER PORTIONS OF THE SITE SO THAT NO CONSTRUCTION TRAFFIC PASSES THROUGH THE PERMEABLE PAVEMENT SITE. INSTALL BARRIERS OR FENCES AS NEEDED.  
- PROTECT THE PAVEMENT PER THE CONSTRUCTION DOCUMENTS. PROTECTION TECHNIQUES THAT MAY BE SPECIFIED INCLUDE MATS, PLASTIC SHEETING, BARRIERS TO LIMIT ACCESS, OR MOVING THE STABILIZED CONSTRUCTION ENTRANCE  
- SCHEDULE STREET SWEEPING DURING AND AFTER CONSTRUCTION TO PREVENT SEDIMENT FROM ACCUMULATING ON THE PAVEMENT.

**CONSTRUCTION STEP 11: AS-BUILT INSPECTION**



AFTER INSTALLATION, AN APPROPRIATELY LICENSED NC PROFESSIONAL MUST PERFORM A FINAL ASBUILT INSPECTION AND CERTIFICATION THAT INCLUDES:  
- ENSURING THAT THE INSTALLATION REMAINS IN GOOD CONDITION AND THE SURFACE IS FREE OF FINES.  
- CHECKING THAT ALL PEROUS SURFACES ARE DRAINING AWAY FROM THE PAVEMENT AND THAT THE OVERALL SITE IS STABILIZED.  
- VERIFYING THAT THE PAVEMENT WAS INSTALLED PER THE DESIGN.  
- PREPARING THE AS-BUILT PLANS THAT INCLUDE ANY CHANGES TO THE UNDERDRAINS, OBSERVATION WELL LOCATIONS, TERRACE LAYOUTS, AGGREGATE DEPTH OR STORAGE STRUCTURES. ANY REVISED CALCULATIONS, ETC.  
- TESTING THE PERMEABILITY OF THE PAVEMENT SURFACE USING THE NCSU SHALLOW HEAD INFILTRATION TEST (SEE MAINTENANCE SECTION 18.5.5) OR OTHER APPROPRIATE TEST SUCH AS ASTM C101 STANDARD TEST METHOD FOR INFILTRATION RATE OF IMPLACE PEROUS CONCRETE. ANY DEFICIENCIES FOUND DURING THE AS-BUILT INSPECTION SHALL BE PROMPTLY ADDRESSED.

**OPERATION AND MAINTENANCE PROVISIONS FOR PERMEABLE PAVEMENT**

BMP element:	Potential problem:	How to remediate the problem:
The perimeter of the permeable pavement	Areas of bare soil and / or erosive gullies have formed.	Regrade the soil if necessary to remove the gully, then plant a ground cover and water until it is established.
	A vegetated area drains toward the pavement.	Regrade the area so that it drains away from the pavement, then plant a ground cover and water until it is established.
The surface of the permeable pavement	Trash / debris is present.	Remove the trash / debris.
	Weeds are growing on the surface of the permeable pavement.	Do not pull the weeds (may pull out media as well). Spray them with a systemic herbicide such as glyphosate and then return within the week to pull them by hand. (Another option is to pour boiling water on them or steam them.)
	Sediment is present on the surface.	Vacuum sweep the pavement.
	The structure is deteriorating or damaged.	Consult an appropriate professional.
	The pavement is rutting, cracking or slumping.	Consult an appropriate professional.
Observation well	Water is present more than five days after a storm event.	Vacuum sweep the pavement. If the pavement still does not dewater, consult a professional.
Educational Sign	The educational sign is missing or has been damaged.	Replace the sign.

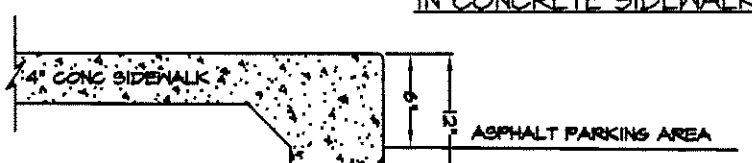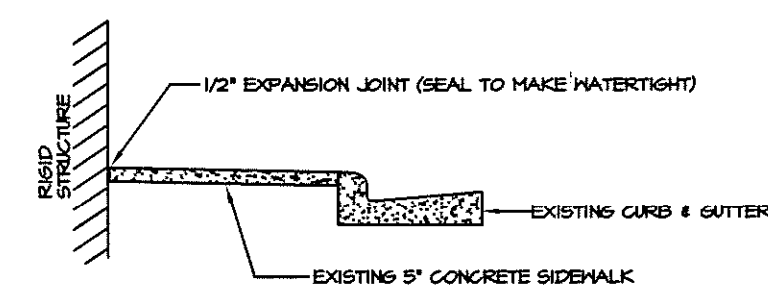


**TURN DOWN SIDEWALK**

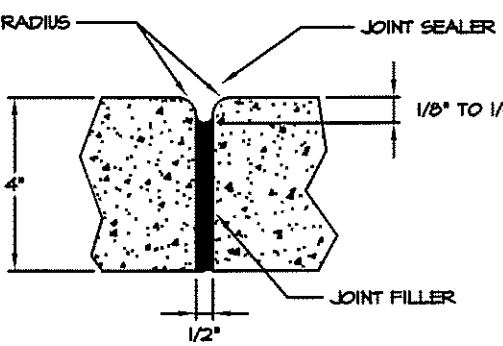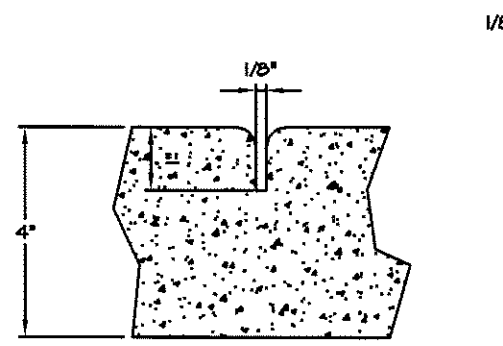



**GENERAL NOTES:**

- A GROOVE JOINT 1\"/>
- EXPANSION JOINTS SHALL BE REQUIRED AT 9\"/>
- EXPANSION JOINTS SHALL BE REQUIRED AT 48\"/>
- CONCRETE TO BE 3000 PSI MIN
- VERTICAL CURB AND OBSERVE CURB SHALL BE SLOPED 3/4\"/>
- USE 1\"/>
- EXPANSION JOINT MATERIAL TO COMPLY WITH CURRENT AISC SPECIFICATIONS
- 5\"/>
- MINIMUM INSULATION LENGTH IS 3 FT
- CONCRETE TO BE 3000 PSI MIN
- VERTICAL CURB AND OBSERVE CURB SHALL BE SLOPED 3/4\"/>

**CONCRETE SIDEWALKS**

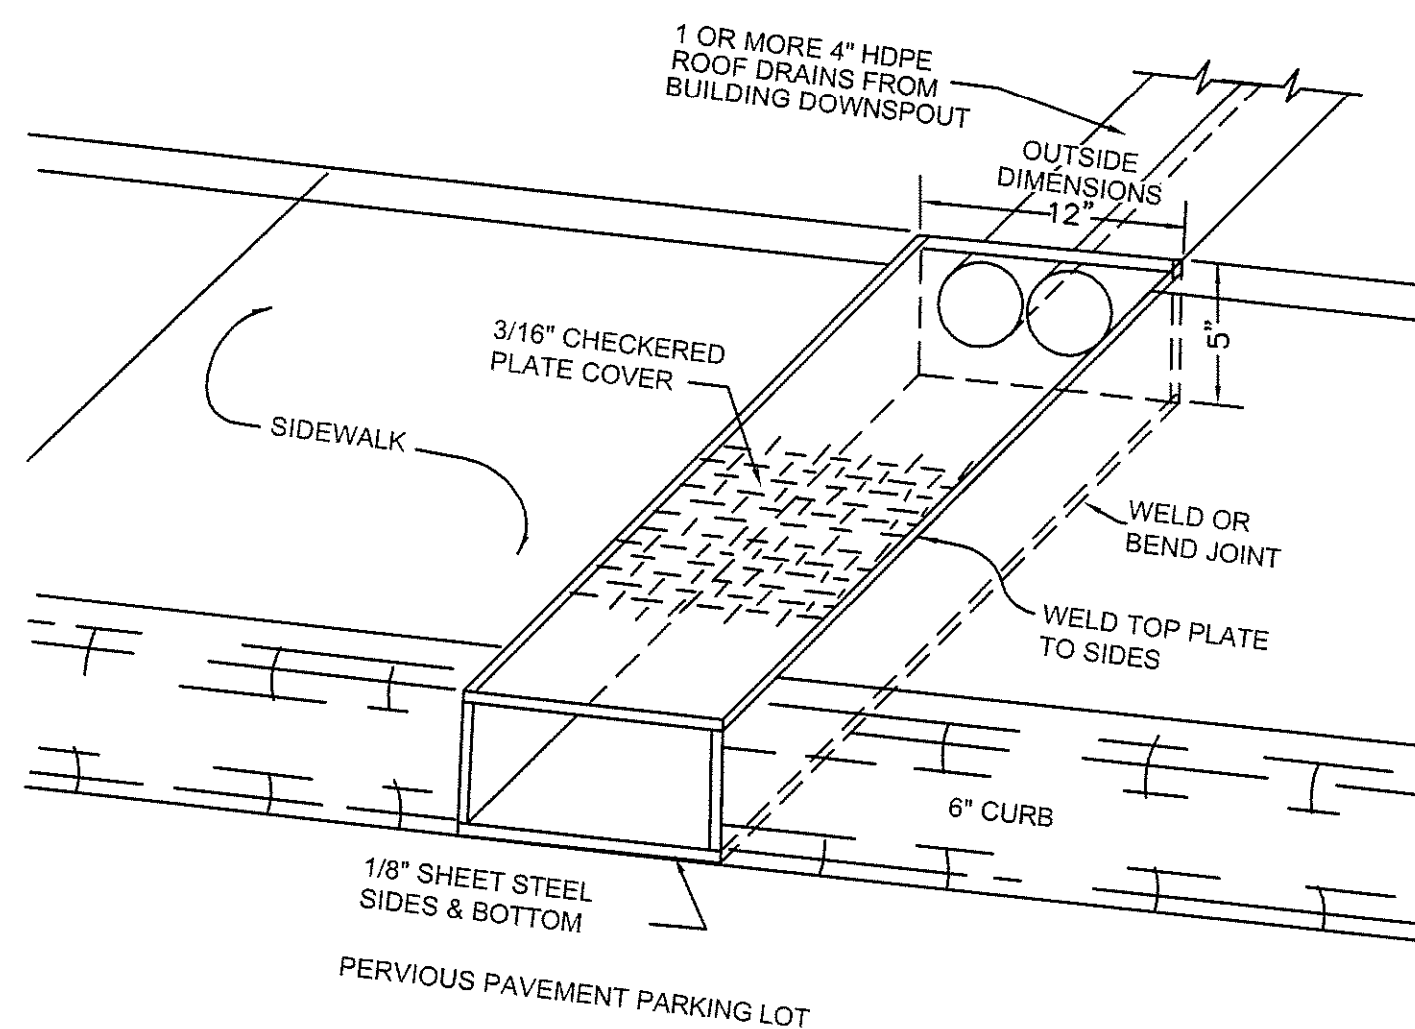


**STANDARD 5" X 12" GALVANIZED STEEL FLUME**

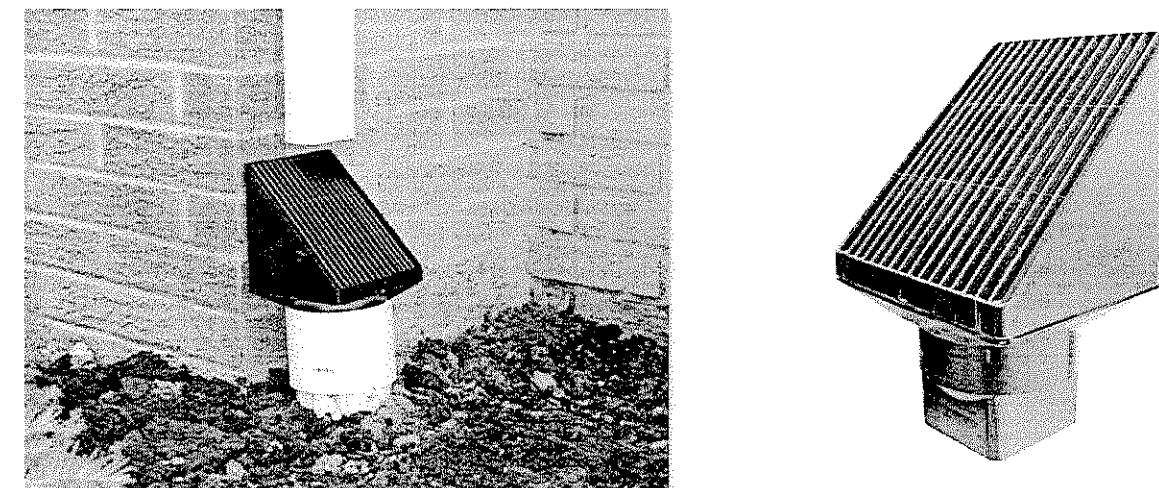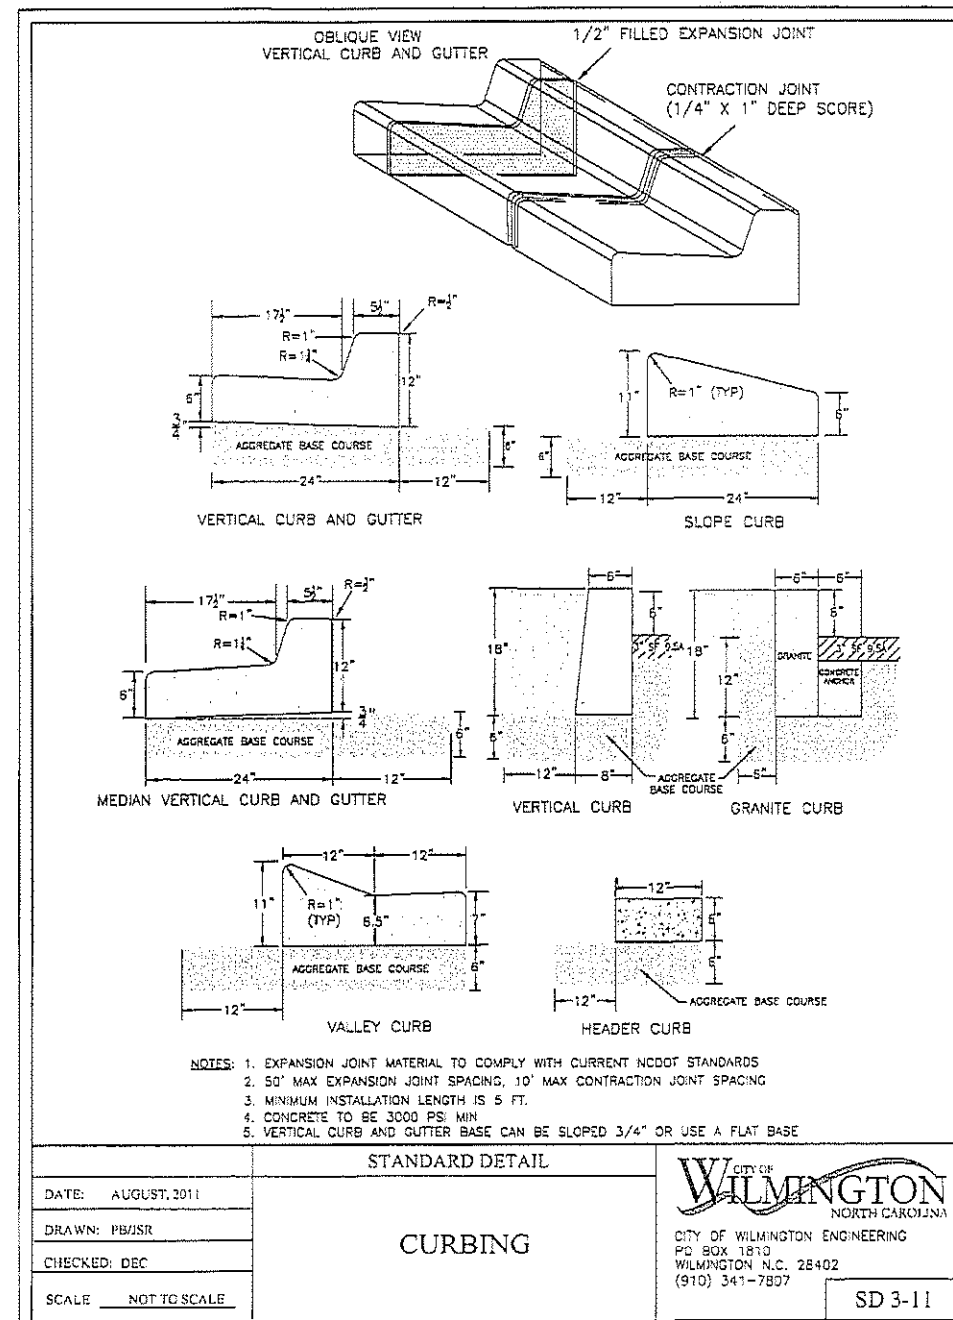

"THE ULTIMATE DOWN SPOUT SCREEN" BY ANDERSON WINDOW AND GUTTER CLEANING SHALL BE INSTALLED AT EACH DOWN SPOUT LOCATION. CONTRACTOR MAY SUBMIT EQUIVALENT PRODUCT FOR SUBSTITUTION APPROVAL. MODEL AND SIZE SHALL BE AS REQUIRED BASED ON DOWN SPOUT SIZE SPECIFIED BY THE ARCHITECT. REFER TO ARCHITECTURAL PLANS FOR EXACT LOCATION. THE GAP BETWEEN THE DOWN SPOUT END AND THE SCREEN SHALL BE MINIMIZED TO THE EXTENT PRACTICAL TO AVOID SLASH OUT. 4\"/>

**DOWNSPOUT SCREEN**

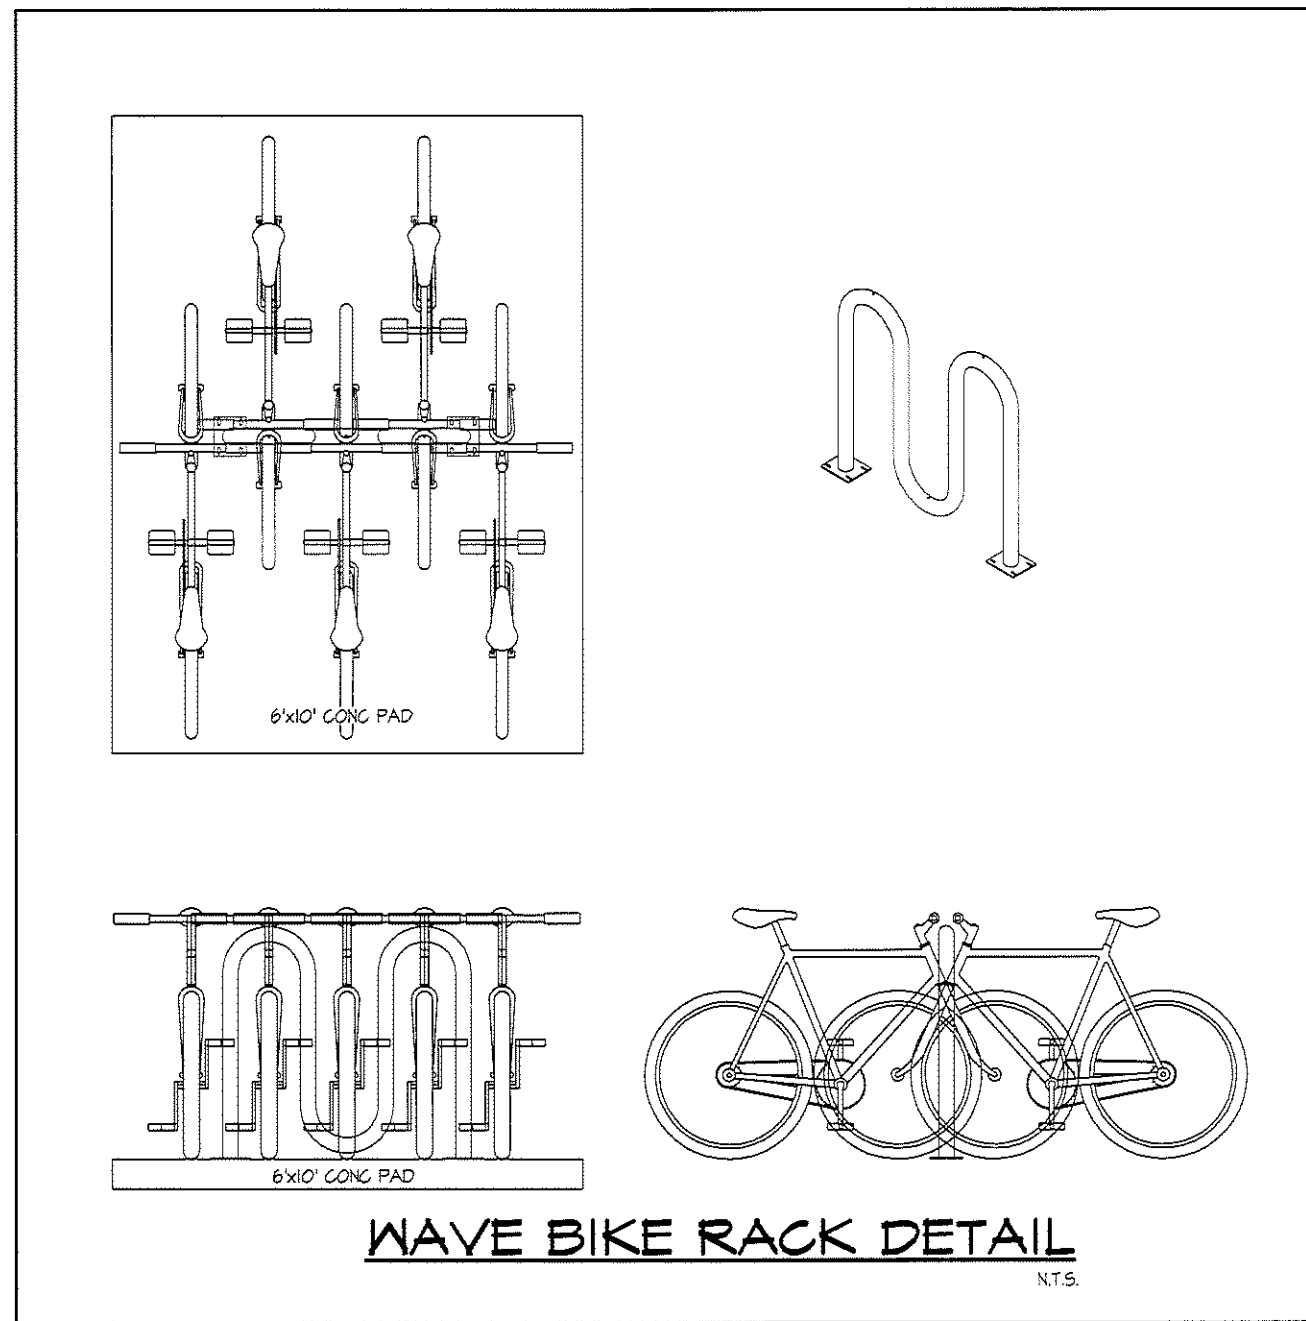

**WAVE BIKE RACK DETAIL**



APPROVED STORMWATER MANAGEMENT PLAN  
Date: \_\_\_\_\_ Permit # \_\_\_\_\_  
Signed: \_\_\_\_\_


**Approved Construction Plan**

Name: \_\_\_\_\_ Date: \_\_\_\_\_  
Planning: \_\_\_\_\_  
Traffic: \_\_\_\_\_  
Fire: \_\_\_\_\_

**REVISIONS**

1. REV PER CITY COMMENTS 08-18-2018

**ENGINEERING AND SURVEYING, INC.**  
LAND DEVELOPMENT CONSULTING  
CORPORATE LICENSE NUMBER C-13715  
4400 TYNING STREET  
HIGH POINT, NORTH CAROLINA 27265  
PHONE: (336) 812-8000 ~ FAX: (336) 812-8780

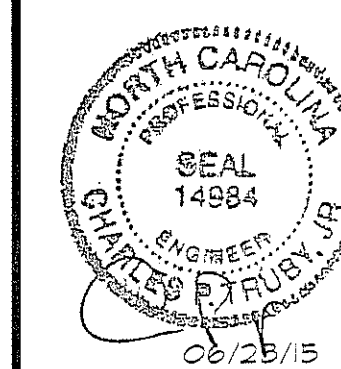

**NOTES and DETAILS**

**ANNEXE AT THE RESERVE**  
CITY OF WILMINGTON ~ WILMINGTON TOWNSHIP  
NEW HANOVER COUNTY, NORTH CAROLINA

**NOTES and DETAILS**

SCALE: N.T.S.  
DATE: 03/17/15  
PROJECT: 1140-12  
DRAWN BY: TGL  
SHEET: D2



**GENERAL NOTES**

- In accordance with N.C.G.S. 136-44.14, all street curbs being constructed or reconstructed shall provide wheelchair ramps for the physically handicapped on each side of any street or road, where curbs and sidewalks are provided and at other major points of pedestrian flow.
- Wheelchair ramps shall be located as indicated in detail drawings; however, existing light poles, fire hydrants, drop inlets, etc. may affect placement.
- Curbs shall have detectable warnings extending the full width of the ramp and a minimum of 2'-ft. in length.

**CONSTRUCTION NOTES**

- Construction shall conform with construction standards of the governing body which has jurisdiction of the particular street.
- Wheelchair ramps shall be constructed of Class **III** concrete with the surface having a rough, non-skid type finish.
- A 1/2-in. expansion joint shall be required where the concrete wheelchair ramp joins any rigid pavement or structure.
- In no case shall the width of a curb ramp or curb cut be less than 40-in. (3-ft. 4-in.), not including the flared sides.
- Transitions from ramps to walks, gutters or streets shall be flush and free of abrupt changes.
- The maximum slope on the curb ramp run is 1:12.
- The maximum cross slope of the curb ramp is 1:50.
- Maximum slopes of adjoining gutters, road surface immediately adjacent to the curb ramp, or accessible route shall not exceed 1:20.
- Any raised islands in crossings shall be cut through level with the street or have curb ramps at both sides and a level area at least 48-in. long between the curb ramps.
- Detectable warnings shall consist of raised truncated domes with a diameter of nominal 0.9-in., a height of nominal 0.2-in., and a center-to-center spacing of nominal 2.35-in. and shall contrast visually with adjoining surfaces, either light-on-dark, or dark-on-light.

**ADDITIONAL NOTES**

- Stop bars shall be used where it is important to indicate the point behind which vehicles are required to stop in compliance with a traffic signal, stop sign or other legal requirement.
- Parking shall be eliminated a minimum of 20 feet back of the pedestrian crosswalk.
- All government markings shall be in accordance with the latest edition of the Manual of Uniform Traffic Control Devices, published by the Federal Highway Administration. This document is available from the Superintendent of Documents, U.S. Government Printing Office, Washington, D.C. 20402.
- Curbs ramps at marked crossings shall be wholly contained within the markings, excluding any flared sides.
- The bottom of diagonal (corner type) curb ramps at marked crossings shall have 48-in. minimum clear space within the markings.
- If diagonal curb ramps have flared sides, they shall have at least a 24-in. long segment of straight curb located on each side of the curb ramp and within the marked crossing.

**STANDARD DETAIL**  
**GUIDELINES FOR WHEELCHAIR RAMPS**  
 SD 8-09

CITY OF WILMINGTON  
 ENGINEERING OFFICE  
 305 CHESTNUT STREET  
 P.O. BOX 1810  
 WILMINGTON, N.C. 28402  
 (910) 341-7807

**TYPICAL LOCATION OF WHEELCHAIR RAMP**

**PLAN VIEW WHEELCHAIR RAMP**

**GUIDELINES FOR WHEELCHAIR RAMPS & DEPRESSED CURBS**  
 SD 8-10

**STANDARD DETAIL**  
**GUIDELINES FOR WHEELCHAIR RAMPS & DEPRESSED CURBS**  
 SHEET 1 OF 2  
 SD 8-10

CITY OF WILMINGTON  
 ENGINEERING OFFICE  
 305 CHESTNUT STREET  
 P.O. BOX 1810  
 WILMINGTON, N.C. 28402  
 (910) 341-7807

**SPECIAL SITUATIONS FOR WHEELCHAIR RAMPS & DEPRESSED CURBS**  
 SD 8-13

**STANDARD DETAIL**  
**SPECIAL SITUATIONS FOR WHEELCHAIR RAMPS AND DEPRESSED CURBS**  
 SD 8-13

CITY OF WILMINGTON  
 ENGINEERING OFFICE  
 305 CHESTNUT STREET  
 P.O. BOX 1810  
 WILMINGTON, N.C. 28402  
 (910) 341-7807

**STANDARD SHOWING METHOD MAKING PAVEMENT REPAIRS WHERE PIPE IS INSTALLED**

**PAVEMENT REPAIRS**  
 SD 1-05

**NOTES:**

- BACKFILL TO BE INSTALLED IN 6" LIFTS (MAXIMUM) AND COMPACTED TO A MINIMUM DENSITY OF 95% AS DETERMINED BY THE MODIFIED A.A.S.H.T.O. STANDARD METHOD T-99
- CUT - BACK TO BE PREPARED AFTER TRENCH BACKFILLING AND COMPACTION

**STANDARD DETAIL**  
**PAVEMENT REPAIRS**  
 SD 1-05

CITY OF WILMINGTON  
 ENGINEERING OFFICE  
 305 CHESTNUT STREET  
 P.O. BOX 1810  
 WILMINGTON, N.C. 28402  
 (910) 341-7807

**SECTION**

**FRONT ELEVATION**

**IN-LINE SIDEWALK RAMP DETAIL**  
 N.T.S.

**SECTION A-A**

**SECTION B-B**

**STANDARD DETAIL**  
**GUIDELINES FOR WHEELCHAIR RAMPS & DEPRESSED CURBS**  
 SHEET 2 OF 2  
 2-47A

CITY OF WILMINGTON  
 ENGINEERING OFFICE  
 305 CHESTNUT STREET  
 P.O. BOX 1810  
 WILMINGTON, N.C. 28402  
 (910) 341-7807

**ACCESSIBLE PARKING REQUIREMENTS**

TOTAL PARKING SPACES PROVIDED	MINIMUM NUMBER OF ACCESSIBLE SPACES REQUIRED	MINIMUM NUMBER OF ACCESSIBLE SPACES REQUIRED TO BE VAN ACCESSIBLE
1 TO 25	1	1
26 TO 50	2	1
51 TO 75	3	1
76 TO 100	4	1
101 TO 150	5	1
151 TO 200	6	1
201 TO 300	7	1
301 TO 400	8	1
401 TO 500	9	2
501 TO 1000	2% OF TOTAL	1 IN EVERY 5 ACCESSIBLE SPACES
1001 AND OVER	2% PLUS 1 FOR EACH 100 OVER 500	1 IN EVERY 6 ACCESSIBLE SPACES

**ACCESSIBLE PARKING STANDARDS**  
 N.T.S.

**NOTES:**

- ALL 2'x8' ACCESSIBLE SIGNS (RT-80 & RT-81) SHALL BE MOUNTED ON 4" X 4" SIGN POSTS TO BOTTOM EDGE OF SIGN FACE. SIGN HEIGHT SHALL BE 5 FEET. SIGN SHALL BE PLACED IN AN AREA BETWEEN SIDEWALK AND BUILDING FACE BY THE PROPERTY OWNER. SIGN SHALL BE 10' FROM DRIVE.
- REFER TO MANUAL ON UNIFORM TRAFFIC CONTROL DEVICES (MUTCD) FOR SIGNAGE REQUIREMENTS AND NORTH CAROLINA DEPARTMENT OF TRANSPORTATION SUPPLEMENT.
- IF ACCESSIBLE ROUTE IS A RAISED SIDEWALK AREA, THEN RAMPS ARE REQUIRED AT LOADING ZONE AREA.

**MAXIMUM PENALTY \$250**

**GS20-37.6**

**ACCESSIBLE PARKING SIGN (RT-80)**

**RESERVED PARKING SIGN (RT-81)**

**MAXIMUM PENALTY \$250**

**RESERVED PARKING SIGN (RT-82)**

**MAXIMUM PENALTY \$250**

**RESERVED PARKING SIGN (RT-83)**

**MAXIMUM PENALTY \$250**

**RESERVED PARKING SIGN (RT-84)**

**MAXIMUM PENALTY \$250**

**RESERVED PARKING SIGN (RT-85)**

**MAXIMUM PENALTY \$250**

**RESERVED PARKING SIGN (RT-86)**

**MAXIMUM PENALTY \$250**

**RESERVED PARKING SIGN (RT-87)**

**MAXIMUM PENALTY \$250**

**RESERVED PARKING SIGN (RT-88)**

**MAXIMUM PENALTY \$250**

**RESERVED PARKING SIGN (RT-89)**

**MAXIMUM PENALTY \$250**

**RESERVED PARKING SIGN (RT-90)**

**MAXIMUM PENALTY \$250**

**RESERVED PARKING SIGN (RT-91)**

**MAXIMUM PENALTY \$250**

**RESERVED PARKING SIGN (RT-92)**

**MAXIMUM PENALTY \$250**

**RESERVED PARKING SIGN (RT-93)**

**MAXIMUM PENALTY \$250**

**RESERVED PARKING SIGN (RT-94)**

**MAXIMUM PENALTY \$250**

**RESERVED PARKING SIGN (RT-95)**

**MAXIMUM PENALTY \$250**

**RESERVED PARKING SIGN (RT-96)**

**MAXIMUM PENALTY \$250**

**RESERVED PARKING SIGN (RT-97)**

**MAXIMUM PENALTY \$250**

**RESERVED PARKING SIGN (RT-98)**

**MAXIMUM PENALTY \$250**

**RESERVED PARKING SIGN (RT-99)**

**MAXIMUM PENALTY \$250**

**RESERVED PARKING SIGN (RT-100)**

**MAXIMUM PENALTY \$250**

**GENERAL NOTES**

- USE 4000 PSI MINIMUM COMPRESSIVE STRENGTH CONCRETE.
- FABRICATE, ASSEMBLE AND DESIGN PRECAST MANHOLE COMPONENTS ACCORDANCE WITH AASHTO M199.
- ASSEMBLE RISER AND GRADE RINGS WITH THE STEPS SPACED 12" FROM THE TOP TO THE BOTTOM OF THE MANHOLE.
- WHERE THE MANHOLE IS EXPOSED TO ROAD TRAFFIC, CONSTRUCT THE TOP OF THE MANHOLE FLUSH WITH THE GROUND AND A MINIMUM OF 9" ABOVE THE GROUND AT OTHER LOCATIONS.
- LIMIT DEPTH OF FILL TO 30'-0" FROM FINISH GRADE TO TOP OF BOTTOM SLAB.
- THE MIN. SLAB THICKNESS "T" IS THE DIMENSION OF THE THINDEST PORTION OF THE TOP/BOTTOM SLAB.
- TOP MAX. OF REINFORCEMENT MAY BE NEGLECTED IF TOP SLAB HAS A DISTINGUISHABLE TOP AND BOTTOM.

**PRECAST MANHOLE 4', 5' AND 6' DIAMETER**  
 12" THRU 48" PIPE

**ENGLISH STANDARD DRAWING FOR PRECAST MANHOLE 4', 5' AND 6' DIAMETER**  
 12" THRU 48" PIPE

**GRADED INLET OPTION**

**MANHOLE OPTION**

**TYPICAL MANHOLE SECTION**

**ALTERNATE CONE SECTION**

**FLAT TOP SLAB**

**FRAME AND GRATE**

FRAME AND GRATE	STD. NO.
TRAPPEE BRATION	840.37
ADDITIONAL #4 REBAR	840.38
CONCRETE MANHOLE	840.39
CONCRETE MANHOLE	840.40
CONCRETE MANHOLE	840.41
CONCRETE MANHOLE	840.42


**STANDARD DETAIL**  
**GUIDELINES FOR WHEELCHAIR RAMPS & DEPRESSED CURBS**  
 SHEET 2 OF 2  
 2-47A

CITY OF WILMINGTON  
 ENGINEERING OFFICE  
 305 CHESTNUT STREET  
 P.O. BOX 1810  
 WILMINGTON, N.C. 28402  
 (910) 341-7807

**REVISIONS**

NO.	REV PER	CITY COMMENTS
1	REV PER	CITY COMMENTS
2	REV PER	CITY COMMENTS
3	REV PER	CITY COMMENTS
4	REV PER	CITY COMMENTS
5	REV PER	CITY COMMENTS
6	REV PER	CITY COMMENTS
7	REV PER	CITY COMMENTS
8	REV PER	CITY COMMENTS
9	REV PER	CITY COMMENTS
10	REV PER	CITY COMMENTS

**ENGINEERING AND SURVEYING, INC.**  
 LAND DEVELOPMENT CONSULTING  
 CORPORATE LICENSE NUMBER C-1315  
 4400 TYNING STREET  
 HIGH POINT, NORTH CAROLINA 27265  
 PHONE: (336) 812-8800 ~ FAX: (336) 812-8100

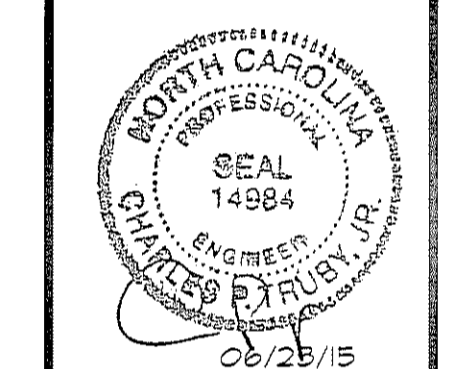

**NOTES and DETAILS**

**ANNEXE AT THE RESERVE**

CITY OF WILMINGTON ~ WILMINGTON TOWNSHIP  
 NEW HANOVER COUNTY, NORTH CAROLINA

**NOTES and DETAILS**

SCALE: N.T.S.

DATE: 03/17/15

PROJECT: 1140-12

DRAWN BY: TGL

SHEET **D3**

**CITY OF WILMINGTON**  
 NORTH CAROLINA  
 Public Services • Engineering Division

**APPROVED STORMWATER MANAGEMENT PLAN**

Date: \_\_\_\_\_ Permit # \_\_\_\_\_

Signed: \_\_\_\_\_

**Approved Construction Plan**

Name: \_\_\_\_\_ Date: \_\_\_\_\_

Planning: \_\_\_\_\_

Traffic: \_\_\_\_\_


Fire: \_\_\_\_\_

**OWNER / DEVELOPER:**  
 BRC WILMINGTON LLC  
 5826 SAMET DRIVE, SUITE 105  
 HIGH POINT, NC 27265  
 PHONE: (336) 889-1512  
 FAX: (336) 889-1501

**ENGINEER:**  
 CPT ENGINEERING & SURVEYING, INC.  
 4400 TYNING STREET  
 HIGH POINT, NC 27265  
 CONTACT: CHUCK TRUBY, P.E.  
 PHONE: (336) 812-8800 ext:304  
 FAX: (336) 812-8780

Jan 23, 2015 11:40:52 AM Project: 1140-12-D3-Details-D3-Details.dwg Tab Name: D3 SITE DETAILS



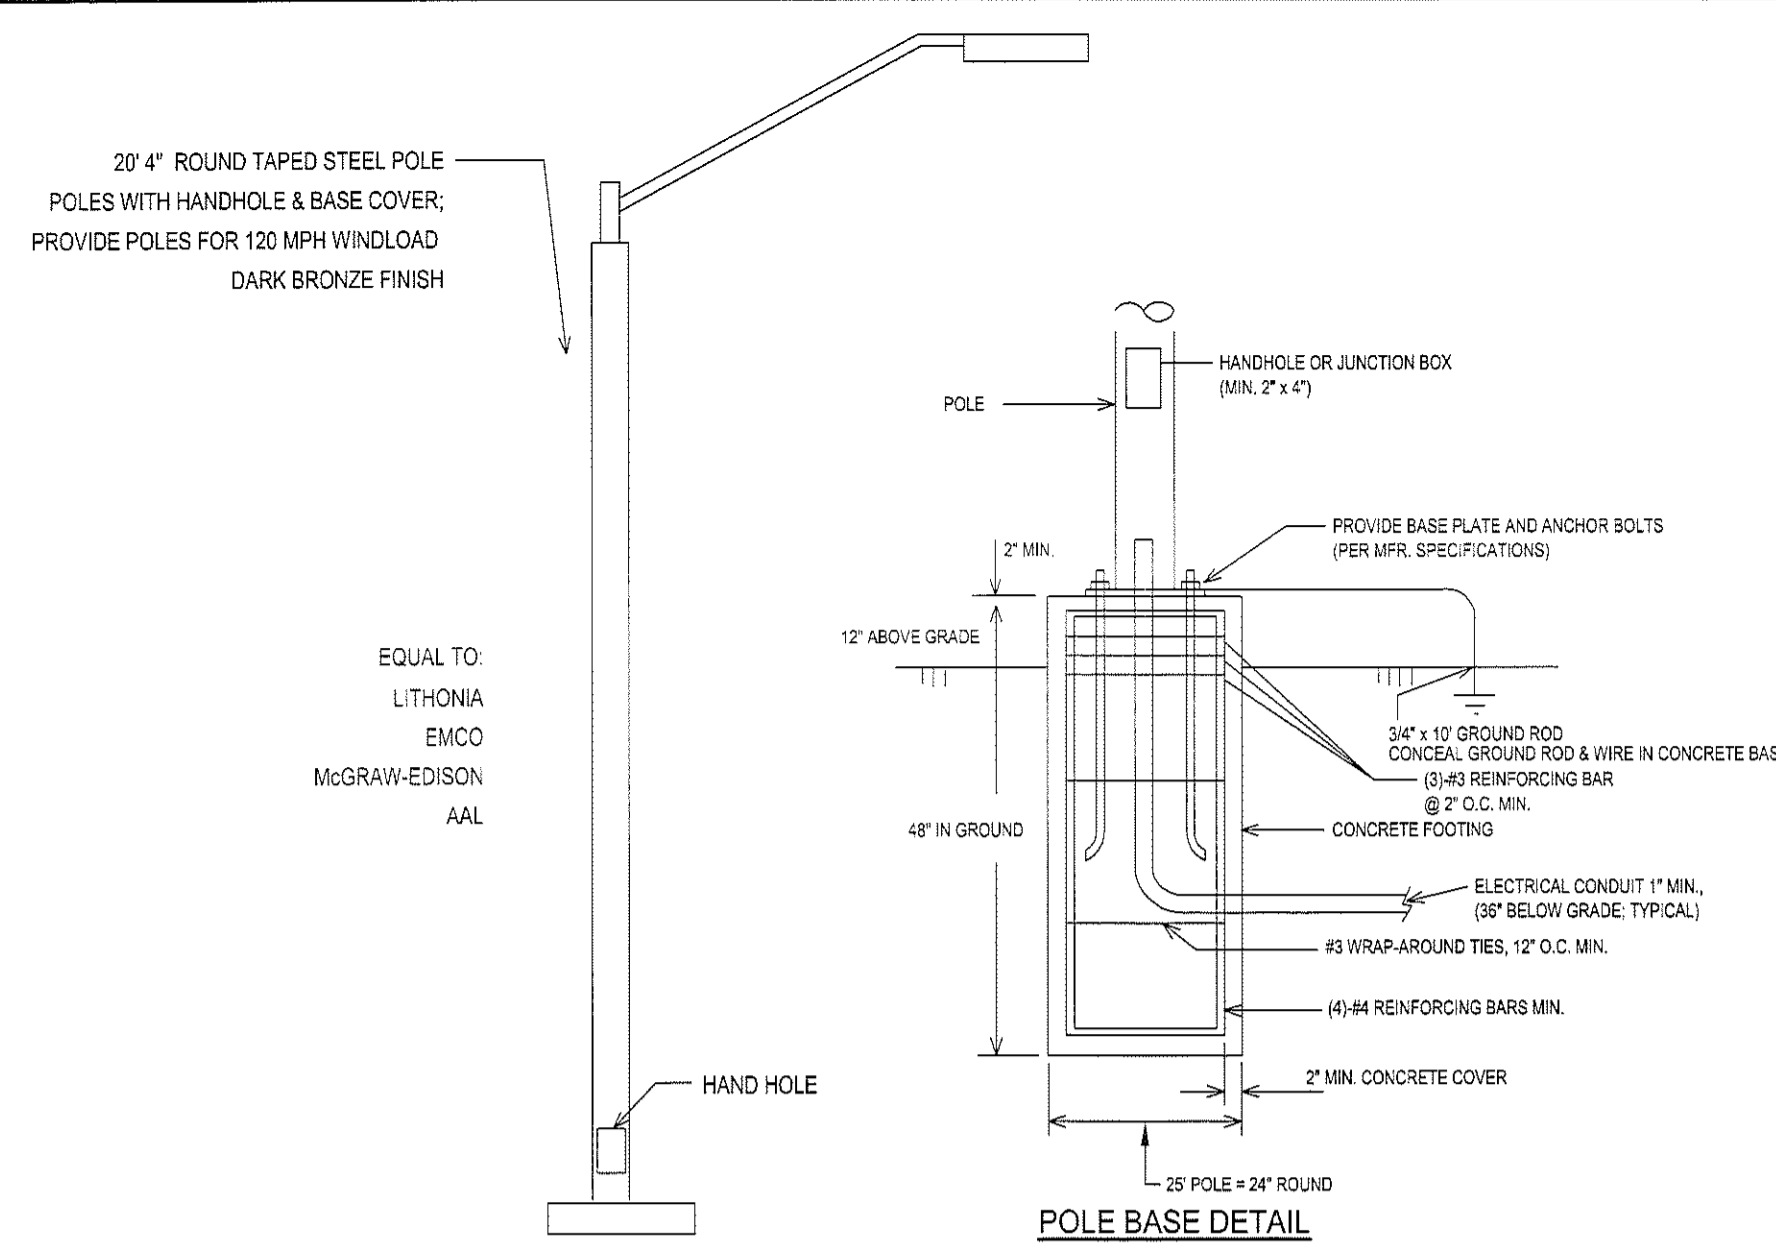

**POLE DETAIL**  
NO SCALE

**STATISTICS**

Description	Symbol	Avg	Max	Min	Max/Min	Avg/Min
Boundary Line	+	0.0 fc	0.5 fc	0.0 fc	N/A	N/A
Parking Lot	+	1.6 fc	3.2 fc	0.5 fc	6.4:1	3.2:1

**LUMINAIRE SCHEDULE**

Symbol	Label	Qty	Catalog Number	Description	Lamp	File	Lumens	LLF	Watts
<input checked="" type="checkbox"/>	A	38	DSX1 LED 400 700 30K TFTM MVOLT HS MA	DSX1 LED WITH (2) 20 LED LIGHT ENGINES, TYPE TFTM OPTIC, 3000K, @ 700mA WITH HOUSE SIDE SHIELD, FOR MAST ARM MOUNTING	LED	DSX1_LED_40 C_700_30K_TF TM_MVOLT_H S_MA.sld	Absolute	0.95	88.79

**D-Series Size 1 LED Area Luminaire**

**Specifications:**  
 Length: 33"  
 Width: 13"  
 Height: 7-1/2"  
 Weight (max): 27 lbs

**Introduction:**  
 The modern styling of the D-Series is striking yet unobtrusive - making a bold, progressive statement even as it blends seamlessly with its environment. The D-Series distills the benefits of the latest in LED technology into a high performance, high efficacy, long-life luminaire. The outstanding photometric performance results in sites with excellent uniformity, greater pole spacing and lower power density. It is ideal for replacing 100-400W metal halide in pedestrian and area lighting applications with typical energy savings of 65% and expected service life of over 100,000 hours.

**Ordering Information**

Series	LED	Beam/Spread	Color Temperature	IP Rating	Mounting	Shipped Included
DSX1 LED	Forward optics	550 550 mA	30K 3000K	T15 Type I Short	TFTM TFFM	Shipped included
	AC 400 (two engaged)	700 700 mA	40K 4000K	T35 Type II Short	Medium	SPM Spare pole mounting
	AC 60 (two engaged)	1000 1000 mA	50K 5000K	T2M Type I Medium	208' WBA Null bracket	WBA Null bracket
	AC 60 (two engaged)	1000 1000 mA	50K 5000K	T3M Type II Medium	250' Type I Short	SPOMBA Spare pole external mounting slider
	DC 60 (two engaged)	1000 1000 mA	50K 5000K	T4M Type I Medium	347' Type I Wide	SPUMBA Spare pole universal mounting slider
	DC 60 (two engaged)	1000 1000 mA	50K 5000K	T5W Type I Wide	480'	Shipped separately

**Shipped Installed**

Option	Description	Shipped Installed	Finish
PER	NEMA twist-lock receptacle only (no controls)	WTS Utility terminal block	DBLND Black
PERB	Non-wire receptacle only (no controls)	WTS Utility terminal block	DBLND Black
PERC	Non-wire receptacle only (no controls)	WTS Utility terminal block	DBLND Black
DIMS	5-10' dimming driver (no controls)	DF Double (120, 277, 347V)	DBLND Black
DCR	Dimmable and controllable via RDMAP (no controls)	LSO Left stacked optics	DBLND Black
DS	Dim switch	R90 Right stacked optics	DBLND Black
PR	Motion sensor, 8-15' mounting height	PRM200 Right night, dim 7 feet	DBLND Black

**Controls & Shields:**

**Accessories:**

**Notes:**



- GENERAL NOTES:**
1. ALL LIGHTING TO BE INSTALLED PER EXTERIOR LIGHTING STANDARDS (LOCAL ORDINANCE); THOROUGHLY REVIEW STANDARDS PRIOR TO INSTALLATION.
  2. DRAWING REFLECTS PROPOSED LIGHTING LOCATIONS; OWNER IS CONSIDERING UTILIZING UTILITY COMPANY TO INSTALL SITE LIGHTING.
  3. FIRST ISOMETRIC LINE REPRESENTS 5 FC AND OUTER ISOMETRIC LINE REPRESENTS 1 FC.
  4. POLES TO HAVE FINISHED HEIGHT OF 20' AFG.
  5. ALL FIXTURES ON ADJACENT TO PROPERLY LINE TO HAVE HOUSE SIDE SHIELD INSTALLED.
  6. PHOTOMETRIC STATISTICS REFLECT MAX BOUNDARY LIGHTING TRESPASS TO BE .5 FC.
  7. TREE AND LIGHTING POLE LOCATIONS COORDINATED.
  8. DOUBLE HEAD POLES IN CENTER OF PARKING LOT SHALL HAVE CONCRETE POLE BASE 36" AFG FOR PROTECTION; TYPICAL OF ALL.

**PHOTOMETRIC PLAN**  
SCALE - 1" = 30'

**Greensboro Engineering PLLC**  
 10125 Guilford Road, Suite 200  
 Greensboro, NC 27409  
 Phone: (336) 288-8800  
 Fax: (336) 288-8801

**North Carolina Professional Engineer**  
 License No. 029466 Charles B. Laney

**Greenwood Engineering, Inc. P.L.L.C.**  
 Seal Registered  
 Engineering Corporation  
 License No. P-0385  
 Greensboro, NC  
 Consulting Engineer

**REVISIONS**

No.	Description	Date

**Engineering and Surveying, Inc.**  
 Land Development Consulting  
 Corporate License Number C-1975  
 4400 TYNING STREET  
 HIGH POINT, NORTH CAROLINA 27265  
 PHONE: (336) 812-8800 FAX: (336) 812-8780

**SITE LIGHTING PLAN**  
**ANNEXE AT THE RESERVE**  
 CITY OF WILMINGTON ~ WILMINGTON TOWNSHIP  
 NEW HOVER COUNTY, NORTH CAROLINA

**PHOTOMETRIC PLAN**

SCALE: 1" = 30'

DATE: 5/28/15

PROJECT: 1140-12

DRAWN BY: CBL

SHEET PH-01



**LANDSCAPE PLAN & INSTALLATION**

Before the issuance of a building permit for the construction, renovation or alteration of any structure, a landscape plan including the type, amount and location of any required landscaping prepared in accordance with the provisions of this section shall be submitted by the property owner and shall be approved by the city manager.

(b) No certificate of occupancy for any construction or renovations shall be approved by the zoning inspector, until:

(1) The required landscaping is completed in accordance with the approved plan; or

(2) A letter of credit or certified check has been posted, which is available to the city, and in sufficient amount to assure installation of the required landscaping. The amount shall be maintained by the developer and returned to the city manager as necessary.

(3) No newly or partially cleared, as provided for in this section, shall be released by the city until all landscaping has been installed, inspected, and approved, and until all required certifications of such approval have been presented to the city.

(4) The board of adjustment may modify or waive the requirements of Division VII of this article, where it can be demonstrated by the property owner that the specific screening buffer or landscaped open space is not needed for the protection of surrounding residential areas because of intervening streets, roadways, drainageways, or other factors such as natural growth of sufficient height and density to serve the same purpose as the required screening buffer.

(5) Any requirements of this article conflict with other requirements of this ordinance, the more stringent or higher standard shall control over the less stringent or lower standard.

**TREE PROTECTION DURING CONSTRUCTION**

(a) To protect existing trees specified on the required landscape plan to remain on the site as a function of existing purposes of the section, the critical root zone shall be protected by proper installation of barricades and signage from vehicular movement, material storage, compacting, grading, staking, and other development related activities during construction and in the final landscape design.

(b) The critical root zone (CRZ) shall be protected during construction by approved tree protection fencing and practices. Tree protective fencing shall be shown on site plans and grading plans around each tree, at perimeter of tree-free areas, and at limits of disturbance. No equipment is allowed on the site until all tree protection fencing and tree fencing has been installed and approved. Tree protective fencing shall remain in place through completion of construction activities.

(c) If the center CRZ cannot be preserved, the disturbed area shall extend no closer to the protected tree trunk than one half (1/2) the radius of the CRZ. In no case shall one foot (1') portion of the CRZ be disturbed.

(d) Disturbance of the CRZ will only be allowed on one (1) side of the retained tree and only with prior approval by the appropriate reviewing agency.

(e) Prior to grading, tree roots shall be pruned using appropriate arboriculture pruning tools and practices.

(f) Disturbance other than that allowed on the approved plan, including incorrectly placed tree protection fencing or improper root pruning constitutes negligence and will require the owner to post an irrevocable letter of credit or other means of financial assurance approved by the reviewing agency for three (3) years to provide for mitigation of the tree per section 18-460 to be released if determined by the reviewing agency that the tree is not at risk of dying due to the disturbance.

(g) Any person who is responsible for failing to properly install or maintain protection measures pursuant to this article shall be subject to a fine of five hundred dollars (\$500.00) per day and a stop work order shall be placed on the project. The owner of the property shall also be jointly and severally responsible party if the improper practices are conducted by an employee, agent, or other person under the control, employ, or direction of the property owner.

**MAINTENANCE**

(a) All planted and retained living material, required to meet the provisions of this section, shall be perpetually protected and maintained to professionally accepted standards by joint and several responsibility of the owner, occupant, tenant, and respective agency of the property on which the material is located. Maintenance of trees on nonresidential property shall be performed by a professional that has knowledge of both the ANSI standards and the OSHA standards for tree pruning, removal, and safety and that they are insured against potential damages. Any planted material that becomes damaged or diseased or dies, or is improperly maintained shall be replaced by the owner within sixty (60) days of the occurrence of such condition. If in the opinion of the city manager, there are seasonal conditions which will not permit the timely replacement of the vegetation (e.g., too hot or too cool for successful replacement), the requirement may be administratively waived until a time when such that the replacement would be safe.


(b) In addition to requirements for replacement, any person who is responsible for improper maintenance practices of trees on private or public property shall be subject to a fine of four hundred dollars (\$400.00) per tree. The owner of the property shall also be a responsible party if the improper practices are conducted by an employee, agent, or other person under the control or direction of the property owner. Improper maintenance practices for the purpose of this section means any of the following:

(1) Topping a tree (cutting a significant portion of the terminal growth);

(2) Cutting down a tree that destroys the natural habit and pattern of growth;



(3) Pruning that leaves scars or results in a flush cut, or splitting of limbs;

(4) Use of climbing spikes, nails or hooks, except for the purpose of tree removal or as specified by the American National Standards Institute.

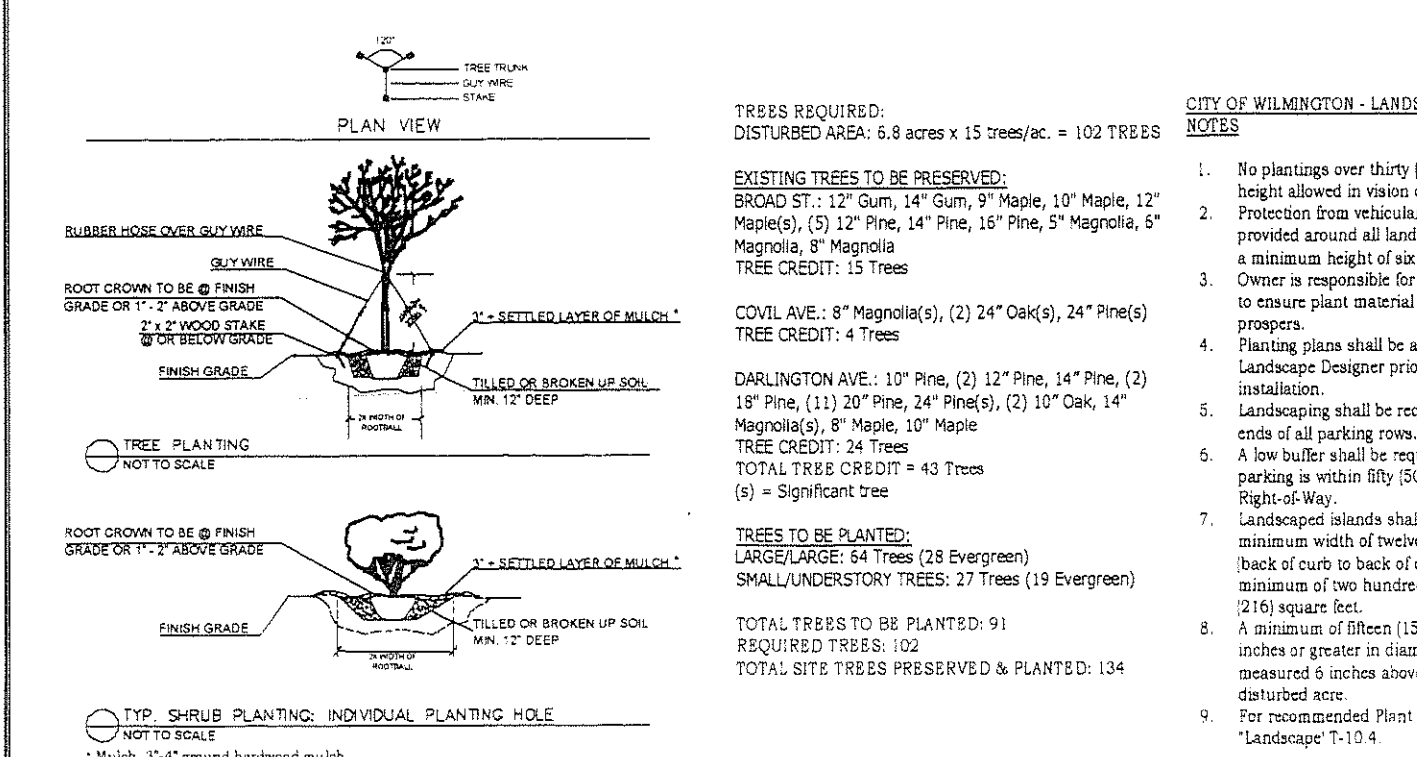

**PLANT SCHEDULE**

Name	Botanical Name	Size
<b>Large Trees</b>		
7	American Holly	Ilex opaca 'American Holly' 2"-2 1/2" cal., 8'-10' hgt.
4	Bald Cypress	Taxodium distichum 2"-2 1/2" cal., 8'-10' hgt.
3	Black Gum	Nyssa sylvatica 2"-2 1/2" cal., 8'-10' hgt.
4	Fruitless Sweetgum	Liquidambar styraciflua 'Rotundifolia' 2"-2 1/2" cal., 8'-10' hgt.
13	Laurel Oak	Quercus laurifolia 2"-2 1/2" cal., 8'-10' hgt.
2	Live Oak	Quercus virginiana 2"-2 1/2" cal., 8'-10' hgt.
6	Loblolly Pine	Pinus taeda 2"-2 1/2" cal., 8'-10' hgt.
5	Red Maple	Acer rubrum 'October Glory' 2"-2 1/2" cal., 8'-10' hgt.
5	River Birch	Betula nigra 'Heritage' 8'-10' hgt., multi-stem
3	Sugar Maple	Acer saccharum 'Green Mountain' (or sim.) 2"-2 1/2" cal., 10' hgt.
6	Willow Oak	Quercus phellos 2"-2 1/2" cal., 10' hgt.
6	Zelkova	Zelkova serrata 'Village Green' 2"-2 1/2" cal., 8'-10' hgt.
<b>Understory Trees</b>		
6	Cherry Laurel	Prunus caroliniana 8'-10' hgt.
5	Crape Myrtle	Lagerstroemia indica 'Dynamite' 8'-10' hgt., multi-stem
1	Kwanzan Cherry	Prunus serrulata 'Kwanzan' 8'-10' hgt.
1	Redbud	Cercis canadensis 'Forest Pansy' 8'-10' hgt.
1	Star Magnolia	Magnolia stellata 8'-10' hgt., multi-stem
9	Sweetbay Magnolia	Magnolia virginiana 8'-10' hgt., multi-stem
4	Yaupon Holly	Ilex vomitoria 8'-10' hgt.
<b>Shrubs</b>		
29	Abelia	Abelia grandiflora 'Edward Goucher' 12" hgt. min., 3 gal.
5	Burford Holly	Ilex cornuta 'Burfordi' 3'-4' hgt.
32	Cleyera	Cleyera japonica 36" hgt. min.
28	Compacta Holly	Ilex crenata 'Compacta' 12" hgt. min., 3 gal.
87	Dwarf Burford Holly	Ilex cornuta 'Burfordi Nana' 12" hgt. min., 3 gal.
71	Dwarf Pittosporum	Pittosporum tobira 'Wheeler's Dwarf' 12" hgt. min., 3 gal.
14	Dwarf Yaupon Holly	Ilex vomitoria 'Nana' 12" hgt. min., 3 gal.
4	Evergreen Euonymus	Euonymus japonica 36" hgt. min.
25	Fortune's Osmanthus	Osmanthus fortunei 36" hgt. min.
8	Grey Owl Juniper	Juniperus virginiana 'Grey Owl' 12" hgt. min., 3 gal.
16	Gulfstream Nandina	Nandina domestica 'Gulfstream' 3 gal., 18" hgt. min.
28	Sasanqua Camellia	Camellia sasanqua 'Yuletide' (red & pink var.) 36" hgt. min.
13	Spice Plant	Illicium anisatum 36" hgt. min.
7	Wax Myrtle	Myrica cerifera 36" hgt. min.
<b>Groundcovers</b>		
200	Blue Fescue	Festuca ovina glauca 1 gal.
27	Blue Pacific Juniper	Juniperus conferta 'Blue Pacific' 3 gal.
31	Cotoneaster, Rockspray	Cotoneaster horizontalis var. perpusillus 3 gal.
59	Daylily	Hemerocallis 'Happy Returns' or 'Suzie Wong' 1 gal.
41	Gardenia Radicans	Gardenia jasminoides 'Radicans' 3 gal.
200	Hypericum, St. John's Wort	Hypericum calycinum 1 gal.

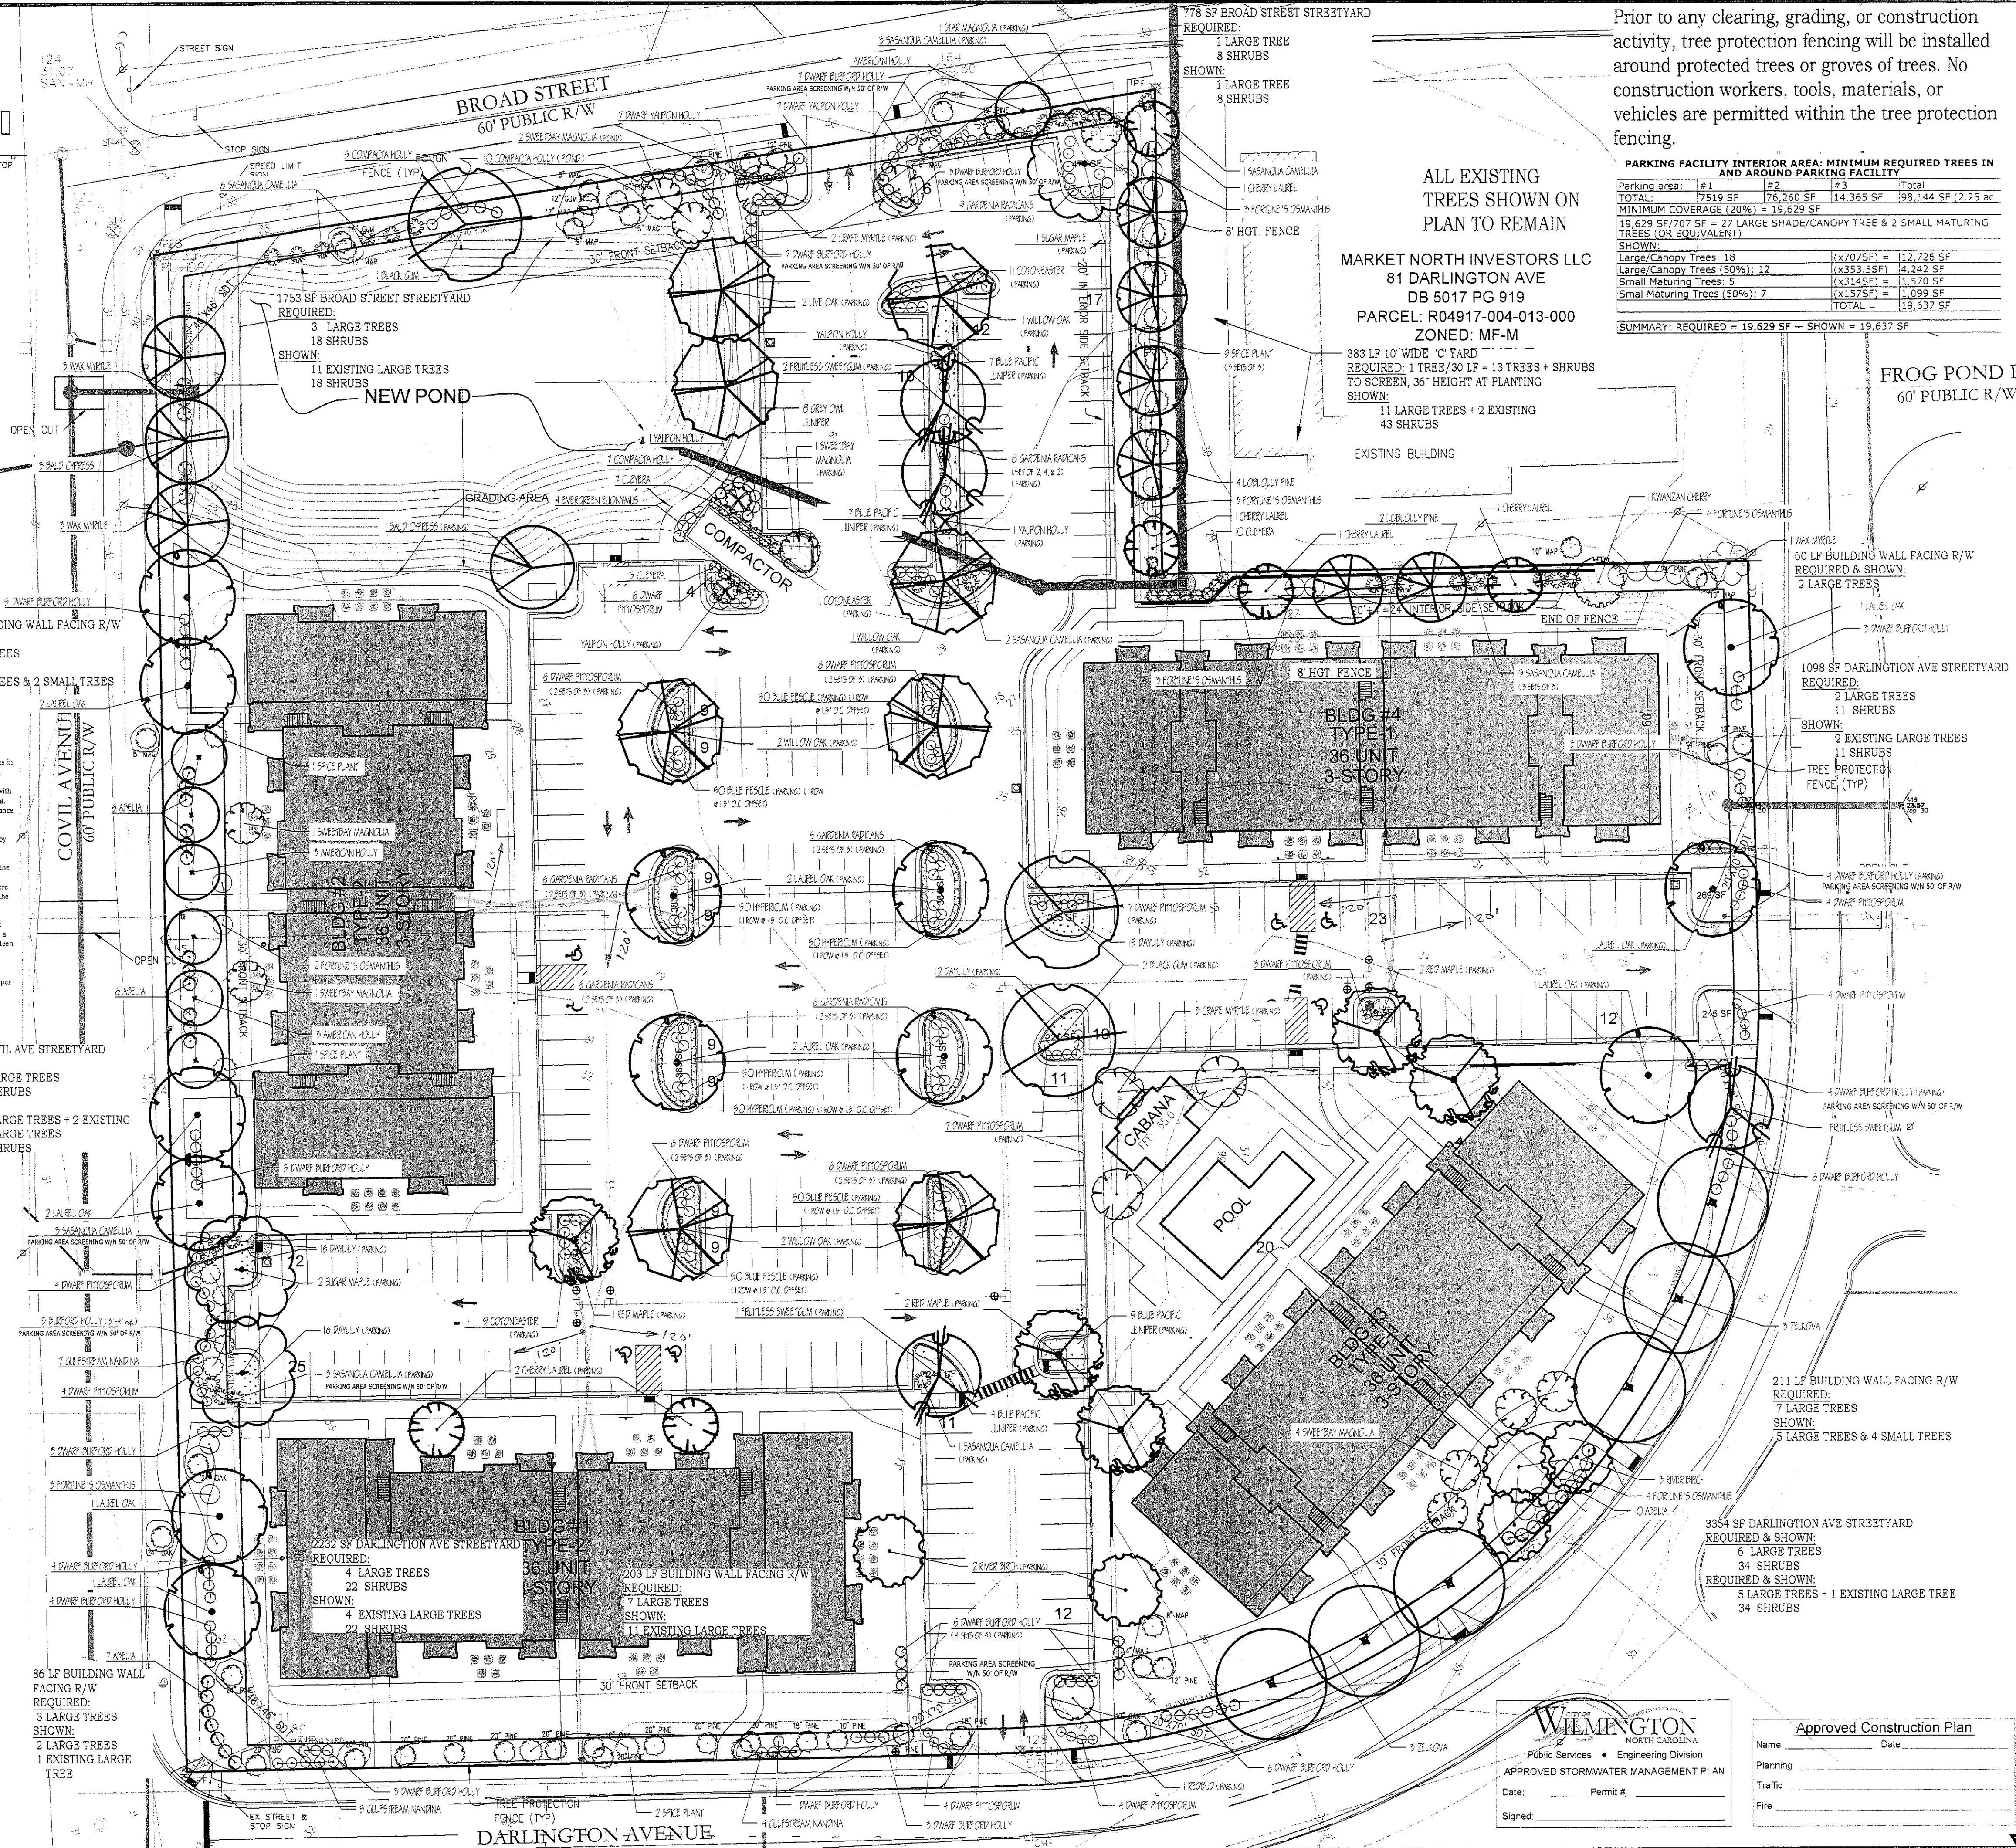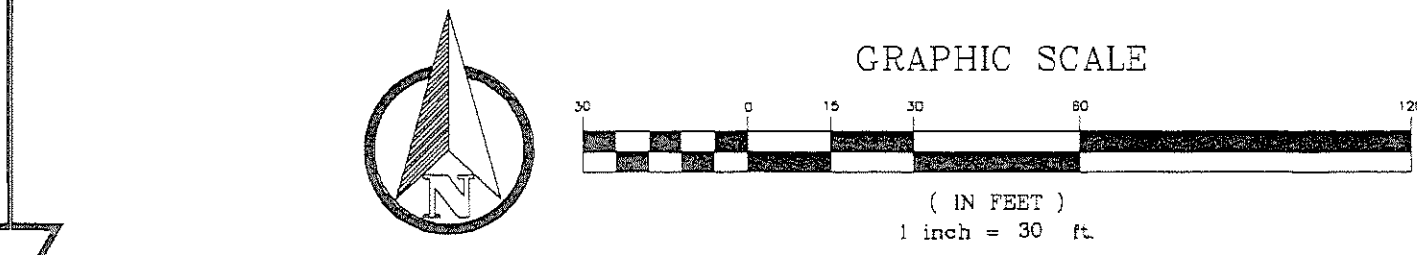

Prior to any clearing, grading, or construction activity, tree protection fencing will be installed around protected trees or groves of trees. No construction workers, tools, materials, or vehicles are permitted within the tree protection fencing.

**PARKING FACILITY INTERIOR AREA: MINIMUM REQUIRED TREES IN AND AROUND PARKING FACILITY**

Parking area: #1	#2	#3	Total
1753 SF	176,260 SF	14,365 SF	198,144 SF (2.25 ac)
MINIMUM COVERAGE (20%) = 19,819 SF			
19,829 SF/707 SF = 27.9 LARGE SHADE/CANOPY TREE & 2 SMALL MATURING TREES (OR EQUIVALENT)			
SHOWING:			
Large/Canopy Trees: 18	(x707SF)	= 12,726 SF	
Large/Canopy Trees (50%): 12	(x353.5SF)	= 4,242 SF	
Small Maturing Trees: 5	(x314SF)	= 1,570 SF	
Small Maturing Trees (50%): 7	(x157SF)	= 1,099 SF	
TOTAL = 19,637 SF			
SUMMARY: REQUIRED = 19,829 SF - SHOWN = 19,637 SF			

*Designature*

RANDAL SCOTT ROMIE, ASLA  
LANDSCAPE ARCHITECT

PO BOX 38903  
Greensboro, NC 27438

336/282-6582



Approved Construction Plan

ANNEXE AT THE RESERVE

Wilmington, North Carolina

OWNER/DEVELOPER:  
BRC Wilmington LLC  
5826 Sамет Drive,  
Suite 105  
High Point,  
North Carolina  
27265  
Phone: (336) 889-1512  
Fax: (336) 889-1501

ENGINEERING AND SURVEYING INC.  
101 WEST WASHINGTON STREET  
WILMINGTON, NC 28401  
PHONE: (336) 799-1111 FAX: (336) 799-1112

Landscape Plan

DATE: 03/03/2015  
PROJECT NO:  
SCALE: 1" = 30'  
DRAWN BY: SVK  
REVISION:  
03/11/2015 - Updated 6' wide streetyard  
06/09/2015 - Address Review Comments

Approved Construction Plan

Name \_\_\_\_\_ Date \_\_\_\_\_  
Planning \_\_\_\_\_  
Traffic \_\_\_\_\_  
Fire \_\_\_\_\_

L1  
1 OF 2



**LANDSCAPE PLAN & INSTALLATION**

Before the issuance of a building permit for the construction, renovation or alteration of any structure, a landscape plan indicating the type, amount and location of any required landscaping prepared in conformance with the provisions of this section shall be submitted by the property owner and approved by the city manager.


- (8) No certificate of occupancy for any construction or renovations shall be approved by the issuing inspector, until:
  - (1) The required landscaping is completed in accordance with the approved plan; or
  - (2) A letter of credit or certified check has been posted, which is available to the city, and in sufficient amount to assure installation of the required landscaping. The amount shall be submitted by the developer and reviewed by the city manager as to acceptability.
- (9) No survey or portion thereof, as provided for in this section, shall be provided for by the city until all landscaping has been installed, inspected, and approved, and until all required certification of such approval has been presented to the city.
- (10) The board of adjustment may modify or waive the requirements of Division VII of this article, where it can be demonstrated by the property owner that the specific screening buffer or landscaped open space is not needed for the protection of surrounding residential areas because of intervening streets, roadways, drainage ways, or other factors such as natural growth of sufficient height and density to serve the same purpose as the required screening buffer.
- (11) If any requirements of this article conflict with other requirements of this ordinance, the more stringent or higher standard shall control over the less stringent or lower standard.

**TREE PROTECTION DURING CONSTRUCTION**

- (a) To preserve existing trees specified on the required landscape plan to remain on the site as a function of fulfilling purposes of this section, the critical root zone shall be protected by proper installation of barriers and signage from vehicular movement, material storage, compacting, grading, excavating, and other development related activities during construction and in the final landscape design.
- (b) The critical root zone shall be protected during construction by approved tree protection fencing and practices. Tree protective fencing shall be shown on site plans and grading plans around each tree, cluster of trees, or perimeter of tree-save areas, and it shall be maintained. No equipment is allowed on the site until all tree protective fencing and all fencing has been installed and approved. Tree protective fencing shall remain in place through completion of construction activities.
- (c) If the entire CRZ cannot be preserved, the disturbed area shall extend no closer to the protected tree trunk than one-half (1/2) the radius of the CRZ. In no case can more than forty (40) percent of the CRZ be disturbed.
- (d) Disturbance of the CRZ will only be allowed on one (1) side of the retained tree and only with prior approval by the appropriate reviewing agency.
- (e) Prior to grading, tree roots shall be pruned using appropriate arboriculture pruning tools and practices.
- (f) Disturbance other than that allowed on the approved plan, including incorrectly placed tree protection fencing or improper root pruning constitutes negligence and will require the owner to post an irrevocable letter of credit or other means of financial assurance approved by the reviewing agency for three (3) years to provide for mitigation of the tree per section 16-40 to be released if determined by the reviewing agency that the tree is not at risk of dying due to the disturbance.
- (g) Any person who is responsible for failing to properly install or maintain protection measures pursuant to this article shall be subject to a fine of five hundred dollars (\$500.00) per day and a stop work order shall be placed on the project. The owner of the property shall also be a jointly and severally responsible party if the improper practices are conducted by an employee, agent, or other person under the control, employ, or direction of the property owner.

**MAINTENANCE**

- (a) All planted and retained living material, required to meet the provisions of this section, shall be perpetually protected and maintained to professionally accepted standards by joint and several responsibility of the owner, occupant, tenant, and respective agents of the property in which the material is located. Maintenance of trees on non-residential property shall be performed by a professional that has certified that they are knowledgeable of both the ANSI standards and the OSHA standards for tree pruning, removal, and safety and that they are insured against potential damages. Any planted material that becomes damaged or diseased or dies, or is improperly maintained shall be replaced by the owner within sixty (60) days of the occurrence of such condition. If, in the opinion of the city manager, there are seasonal residences which will not permit the timely replacement of the vegetation, the tree or tree root for successful replanting the requirement may be administratively waived until a later certain such that the replanting would be safe.
- (b) In addition to requirements for replacement, any person who is responsible for improper maintenance practices of trees on private or public property shall be subject to a fine of four hundred dollars (\$400.00) per tree. The owner of the property shall also be a responsible party if the improper practices are conducted by an employee, agent, or other person under the control or direction of the property owner. Proper maintenance practices for the purpose of this section include any of the following:
  - (1) Topping a tree (cutting a significant portion of the terminal growth).
  - (2) Cutting up a tree that destroys its natural habit and pattern of growth.
  - (3) Pruning that leaves stubs or results in a flush cut or splitting of limbs.
  - (4) Use of climbing spikes, dials or hooks, except for the purpose of total tree removal or as specified by the American National Standards Institute.

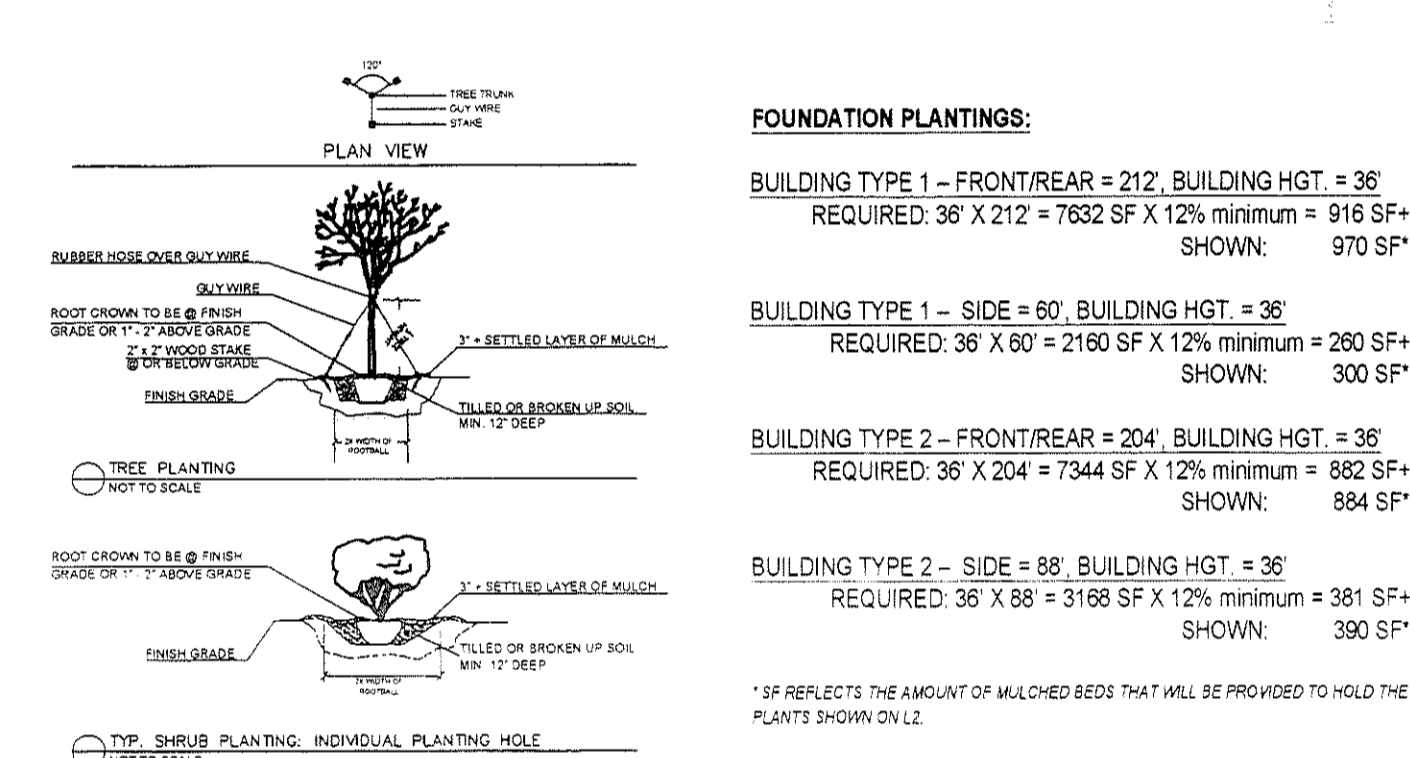

**FOUNDATION PLANTINGS:**

**BUILDING TYPE 1 - FRONT/REAR = 212', BUILDING HGT. = 36'**  
 REQUIRED: 36" X 212' = 7632 SF X 12% minimum = 916 SF+  
 SHOWN: 970 SF\*

**BUILDING TYPE 1 - SIDE = 60', BUILDING HGT. = 36'**  
 REQUIRED: 36" X 60' = 2160 SF X 12% minimum = 260 SF+  
 SHOWN: 300 SF\*

**BUILDING TYPE 2 - FRONT/REAR = 204', BUILDING HGT. = 36'**  
 REQUIRED: 36" X 204' = 7344 SF X 12% minimum = 882 SF+  
 SHOWN: 884 SF\*

**BUILDING TYPE 2 - SIDE = 88', BUILDING HGT. = 36'**  
 REQUIRED: 36" X 88' = 3168 SF X 12% minimum = 381 SF+  
 SHOWN: 390 SF\*

\*SF REFLECTS THE AMOUNT OF MULCHED BEDS THAT WILL BE PROVIDED TO HOLD THE PLANTS SHOWN ON L2.

QTY	Name	Botanical Name	Size
29	Abelia	Abelia grandiflora	12" hgt. min., 3 gal.
6	Aucuba	Aucuba japonica	12" hgt. min., 3 gal.
28	Compacta Holly	Ilex crenata 'Compacta'	12" hgt. min., 3 gal.
23	Dwarf Burford Holly	Ilex cornuta 'Burfordi Nana'	12" hgt. min., 3 gal.
20	Dwarf Yaupon Holly	Ilex vomitoria 'Nana'	12" hgt. min., 3 gal.
2	Evergreen Euonymus	Euonymus japonica	36"+ hgt. min.
22	Gardenia Radicans	Gardenia jasminoides 'Radicans'	12" hgt./spd., 3 gal.
10	Grey Owl Juniper	Juniperus virginiana 'Grey Owl'	12" hgt. min., 3 gal.
24	Gulfstream Nandina	Nandina domestica 'Gulfstream'	12" hgt. min., 3 gal.
16	Indian Hawthorn	Rhaphiolepis indica 'Clara' (or sim.)	12" hgt. min., 3 gal.
10	Inkberry	Ilex glabra 'Nigra'	12" hgt. min., 3 gal.
18	Kurume Azalea	Rhododendron obtusum	12" hgt. min., 3 gal.
2	Spice Plant	Illicium anisatum	36"+ hgt. min.

Note: Mulch: 3"-4" ground hardwood mulch  
 The Developer will provide foundation plantings for all four sides of the buildings, will be more than what is shown, and will specifically address the architectural features of the buildings. The building landscape design will be completed in the near future and can be submitted to the city if desired. A pool landscape plan will also be provided to show additional plantings.

**APPROVED CONSTRUCTION PLAN**

Name: \_\_\_\_\_ Date: \_\_\_\_\_

Planning: \_\_\_\_\_



Traffic: \_\_\_\_\_

Fire: \_\_\_\_\_

Approved By: \_\_\_\_\_

City of Wilmington, North Carolina

Prior to any clearing, grading, or construction activity, tree protection fencing will be installed around protected trees or groves of trees. No construction workers, tools, materials, or vehicles are permitted within the tree protection fencing.

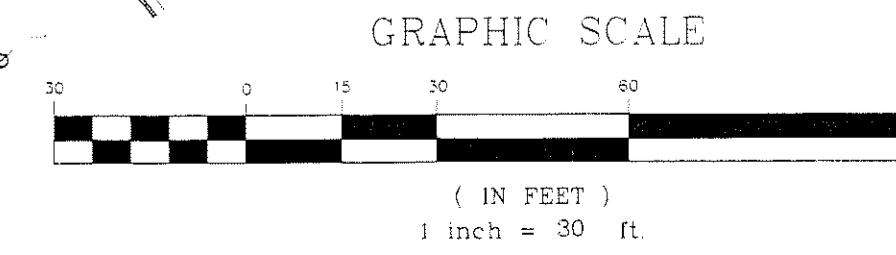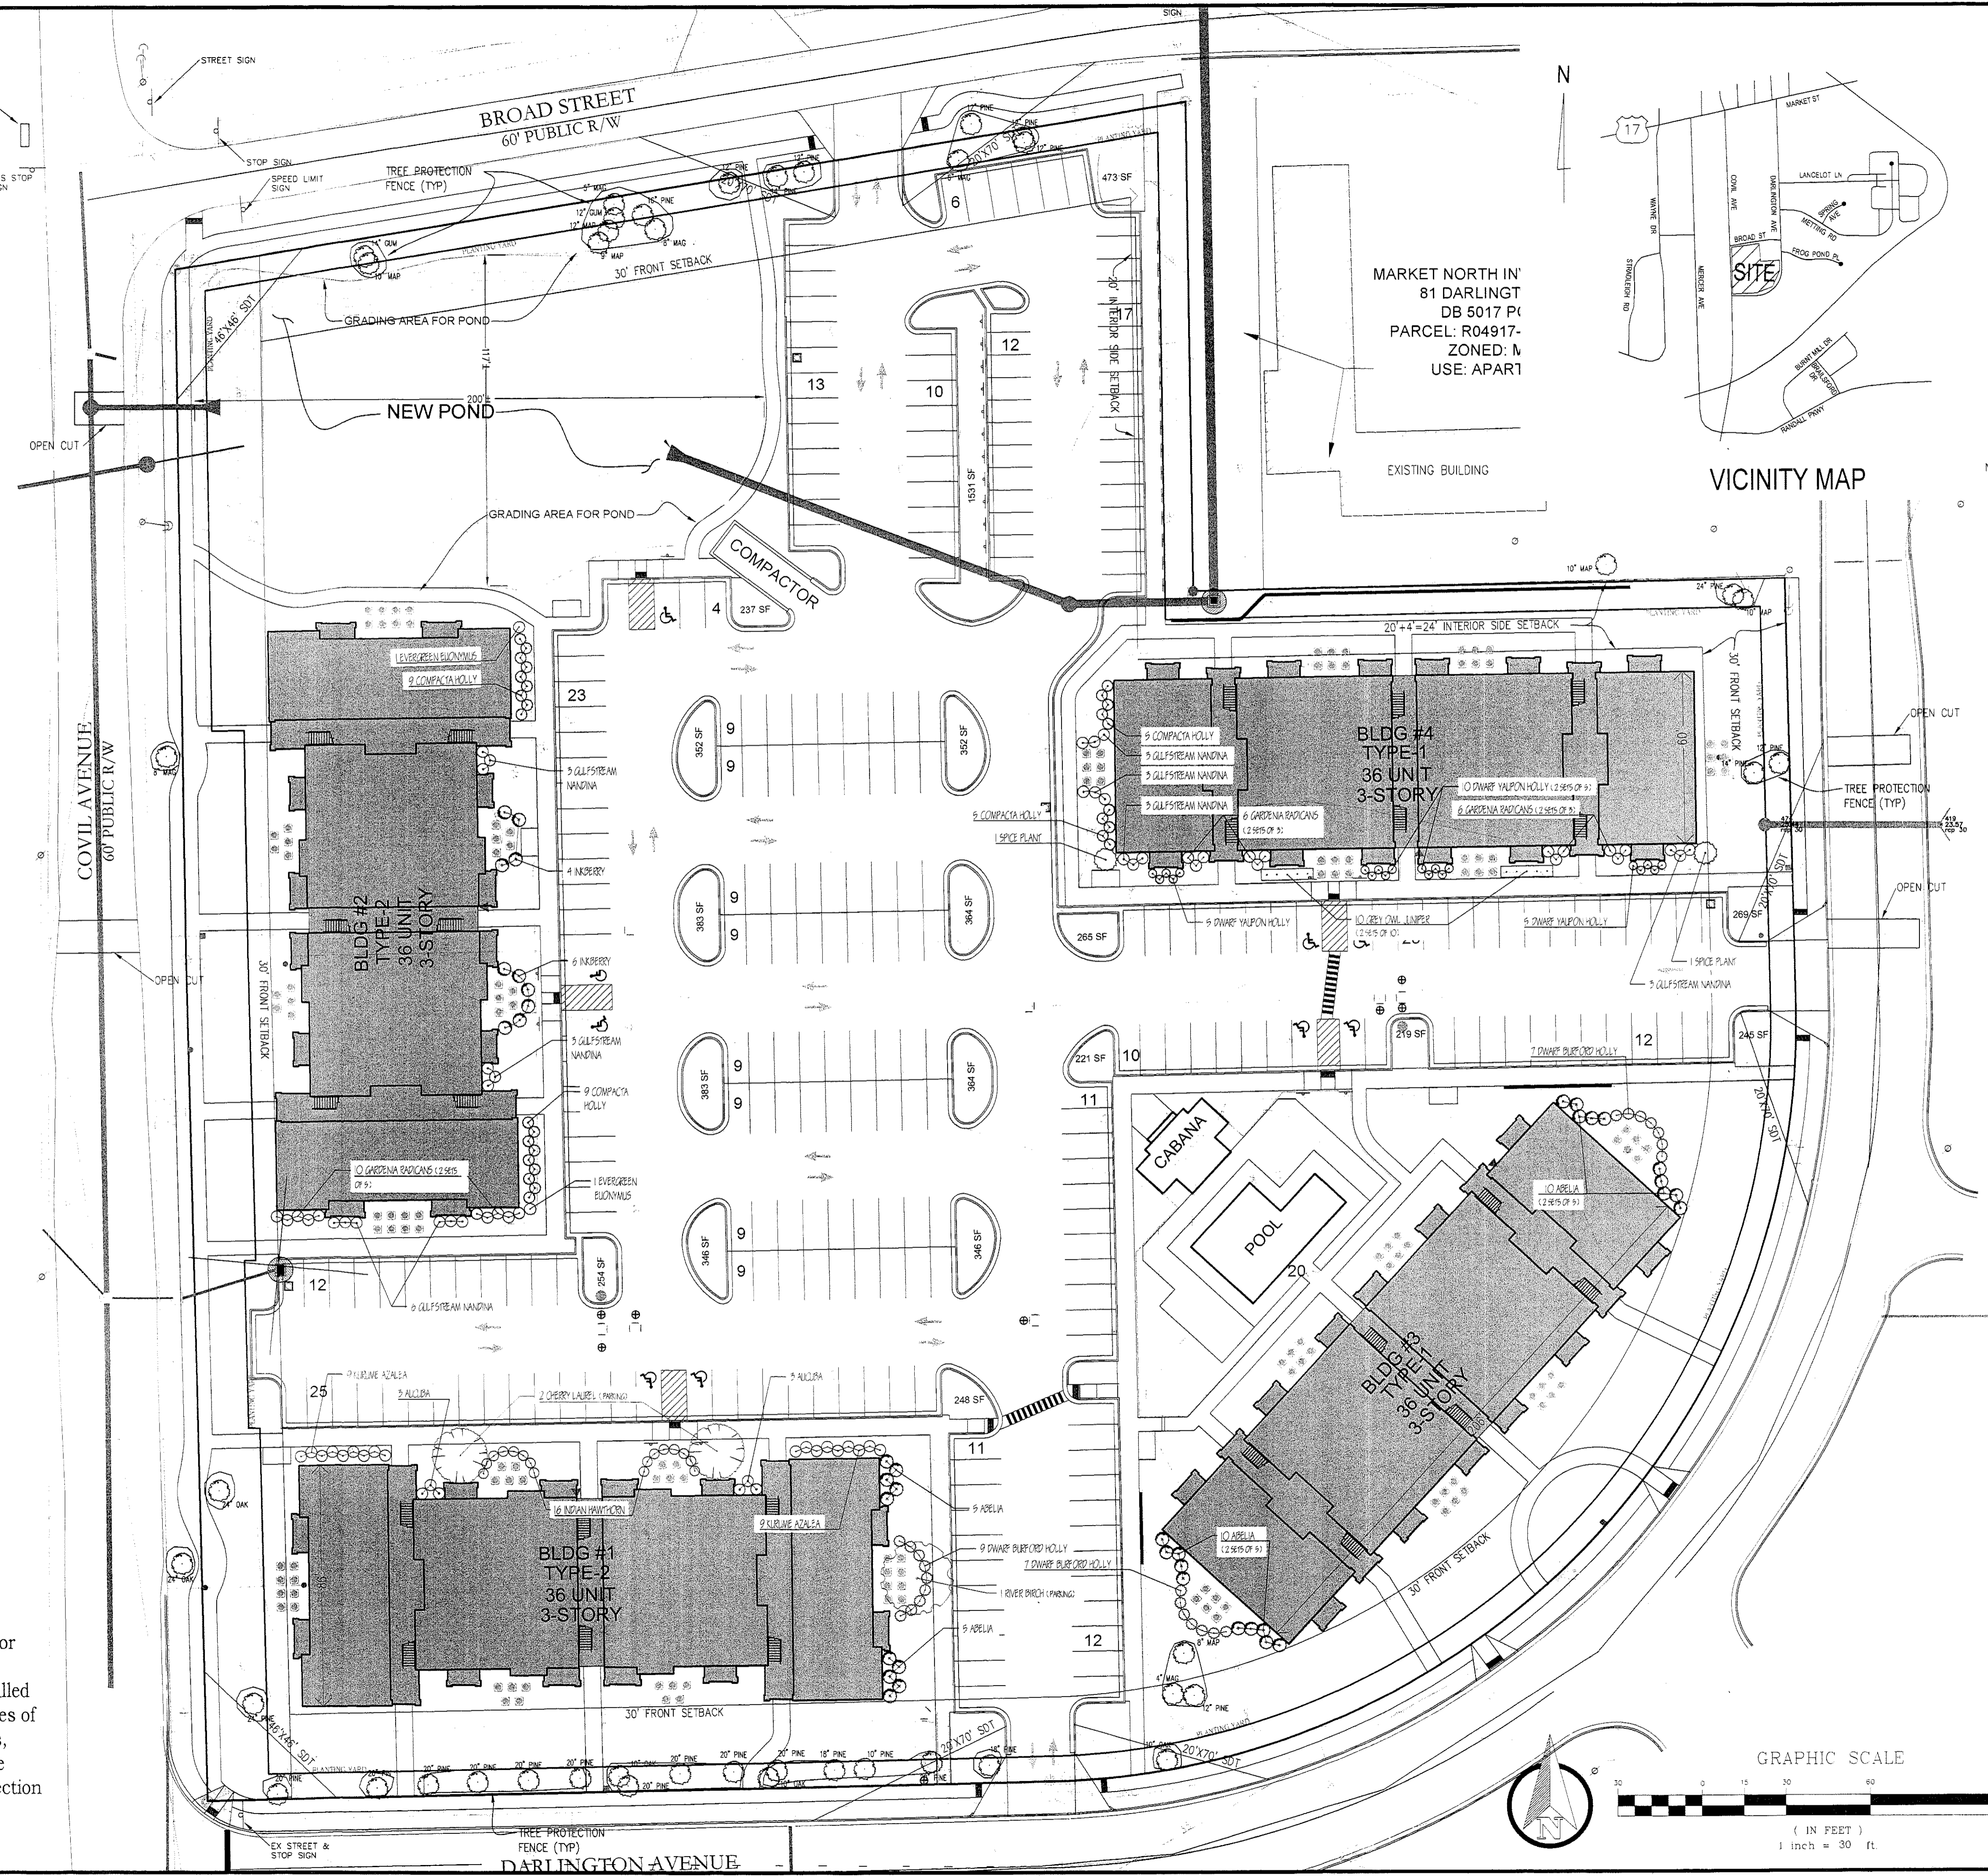


**Designature**

RANDAL SCOTT ROMIE, ASLA  
 LANDSCAPE ARCHITECT

PO BOX 38903  
 Greensboro, NC 27438


336/282-6582

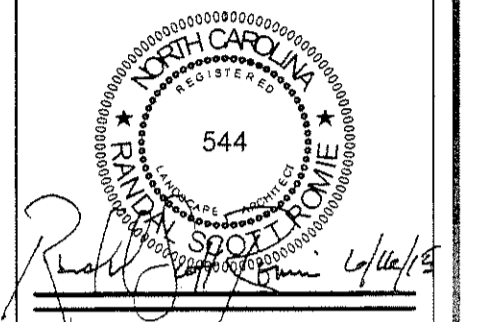

ANNEXE  
 AT  
 THE  
 RESERVE

Wilmington,  
 North Carolina

OWNER/DEVELOPER:  
 BRC Wilmington LLC  
 5826 Samet Drive,  
 Suite 105  
 High Point,  
 North Carolina  
 27265  
 Phone: (336) 889-1512  
 Fax: (336) 889-1501

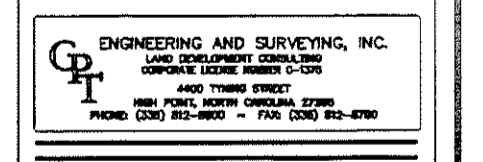

Building  
 Foundations  
 Landscape  
 Plan

DATE: 03/03/2015  
 PROJECT NO.  
 SCALE: 1" = 30'  
 DRAWN BY: SVK  
 REVISION:  
 03/11/2015 - Updated 5' wide street/walk  
 06/09/2015 - Address Review Comments

L2  
 1 OF 2





ARCHITECTURAL GROUP

704 841.1899 1242 Mann Drive Suite 200  
841.8440 fax Matthews, North Carolina 28105  
www.UrbanAIA.com

Seals:



02 ELEVATION: Building Type I Side



03 ELEVATION: Building Type I Front

**ANNEXE AT THE RESERVE**  
New Construction

315 Covil Ave  
Wilmington, NC 28403

Date:	June 17, 2015
Project Number:	2014-78
Issued For:	
Construction Only:	02.25.15

**BUILDING TYPE I  
ELEVATION**

**A3.1**

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Seals:



02

ELEVATION: Building Type II - A3.2



01

ELEVATION: Building Type II - A3.2

# ANNEXE AT THE RESERVE

New Construction

315 Covil Ave  
Wilmington, NC 28403

Date: June 17, 2015  
Project Number: 2014-78  
Issued For:  
Construction Only: 02.25.15

BUILDING TYPE II  
ELEVATION

# A3.2

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